
## **Appendix 9**

Sewage Treatment System Permit Application Support Drawings

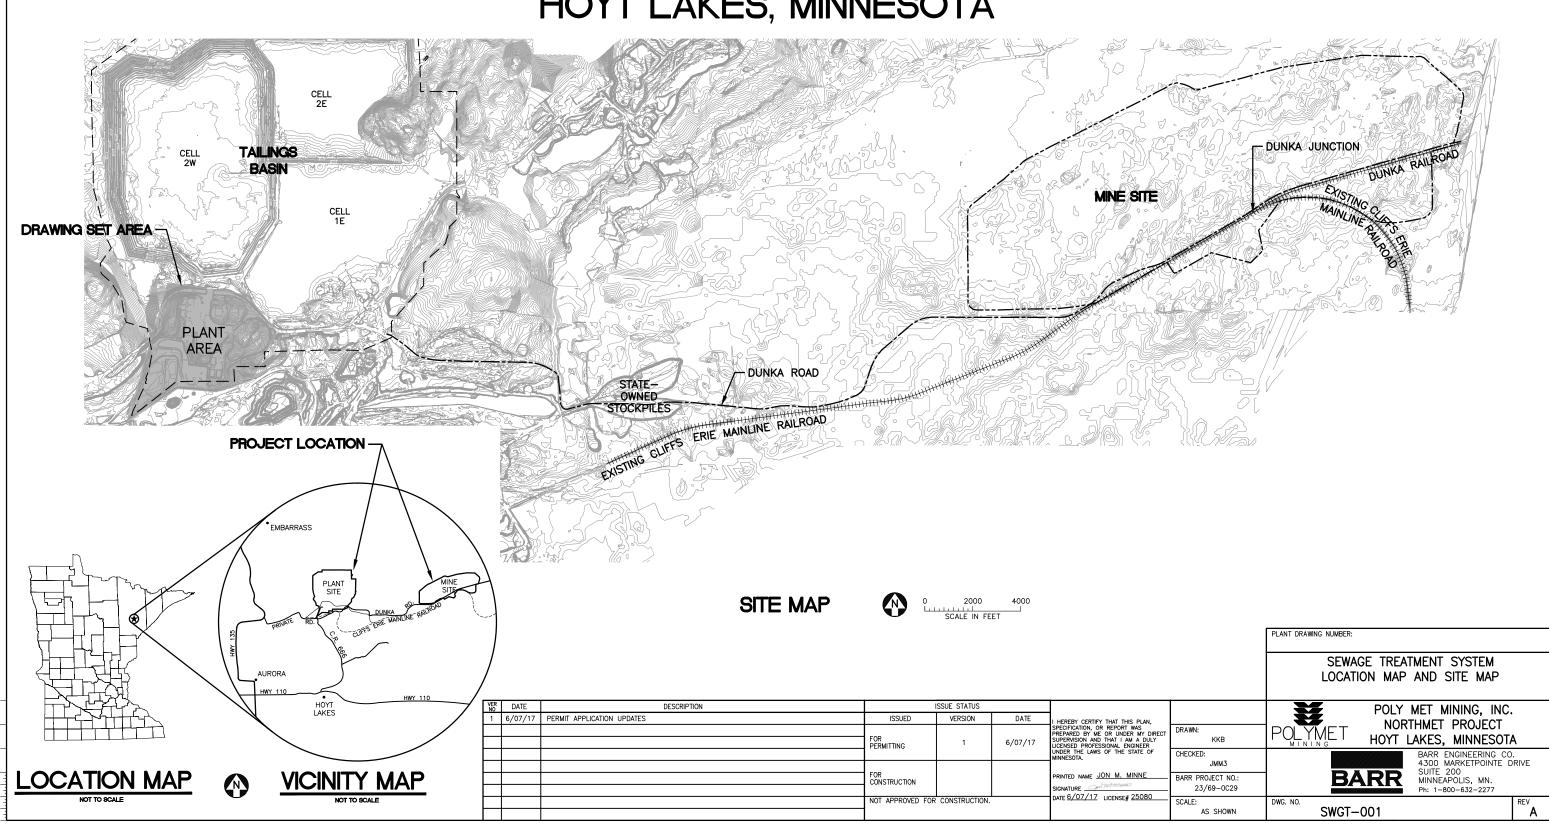

PROJECT AREA BOUNDARY

—--FМ-----EXISTING SANITARY SEWER FORCEMAIN

EXISTING CONTOUR - MAJOR

EXISTING CONTOUR - MINOR

IIIII EXISTING DRAIN FIELD ++++++ EXISTING RAILROAD

EXISTING ROAD EXISTING STRUCTURES

EXISTING OVERHEAD ELECTRIC — OE —— OE — EXISTING PIPELINE

EXISTING SEPTIC TANK

EXISTING FENCE ——×—— EXISTING CULVERT EXISTING MANHOLE EXISTING LIFT STATION SHEET INDEX

SHEET NO. TITLE

GENERAL DRAWINGS

SWGT-001 SWGT-002 SWGT-003 SWGT-004

LOCATION MAP AND SITE MAP LEGEND AND SHEET INDEX OVERALL SITE PLAN STABILIZATION PONDS OPTION PROCESS FLOW DIAGRAM

## **NOTES**


- COORDINATE SYSTEM IS MINNESOTA STATE PLANE NORTH ZONE, NAD83.
- 2. ELEVATIONS ARE BASED ON MEAN SEA LEVEL (MSL), NAVD88.
- EXISTING TOPOGRAPHIC INFORMATION SHOWN ON THE DRAWINGS WAS PREPARED BY AEROMETRIC, INC. FROM LIDAR DATA COLLECTED ON MARCH 17, 2010.
- 4. PIPE, STRUCTURE AND STABILIZATION POND DIMENSIONS ARE PRELIMINARY. FINAL DIMENSIONS SHALL BE DETERMINED DURING FINAL DESIGN.

## **ABBREVIATIONS**

CAST IRON
DUCTILE IRON PIPE
FLOTATION TAILINGS BASIN
GALLONS PER DAY
GALLONS PER MINUTE
INVERT
POUND
LINEAR FEET CI DIP FTB GPD GPM INV LB LF MH MIN PHWWF PT PVC SS SWGT VCP

LINEAR FEET
MANHOLE
MINIMUM
PEAK HOURLY WET WEATHER FLOW
PEAK INSTANTANEOUS WET WEATHER FLOW
POINT
POLYVINYL CHLORIDE
SANITARY SEWER
SEWAGE TREATMENT
VITRIFIED CLAY PIPE

## **DRAWING NUMBERING**

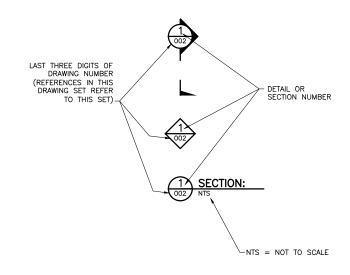

PLANT DRAWING NUMBER:

POLYMET

SEWAGE TREATMENT SYSTEM LEGEND AND SHEET INDEX

BARR

SWGT-002

POLY MET MINING, INC. NORTHMET PROJECT


HOYT LAKES, MINNESOTA

MINNEAPOLIS, MN.


Ph: 1-800-632-2277

BARR ENGINEERING CO. 4300 MARKETPOINTE DRIVE SUITE 200

VER NO	DATE	DESCRIPTION		SSUE STATUS			
1	6/07/17	PERMIT APPLICATION UPDATES	ISSUED	VERSION	DATE	I HEREBY CERTIFY THAT THIS PLAN,	
			FOR PERMITTING	1	6/07/17	SPECIFICATION, OR REPORT WAS PREPARED BY ME OR UNDER MY DIRECT SUPERVISION AND THAT I AM A DULY LICENSED PROFESSIONAL ENGINEER	DRAWN: KKB
						UNDER THE LAWS OF THE STATE OF MINNESOTA.	CHECKED: JMM3
			FOR CONSTRUCTION			PRINTED NAME JON M. MINNE	BARR PROJECT NO.:
						SIGNATURE	23/69-0C29
			NOT APPROVED FOR	CONSTRUCTION.		DATE ST. T. LICENSE# 20000	SCALE: AS SHOWN
							A3 31101111

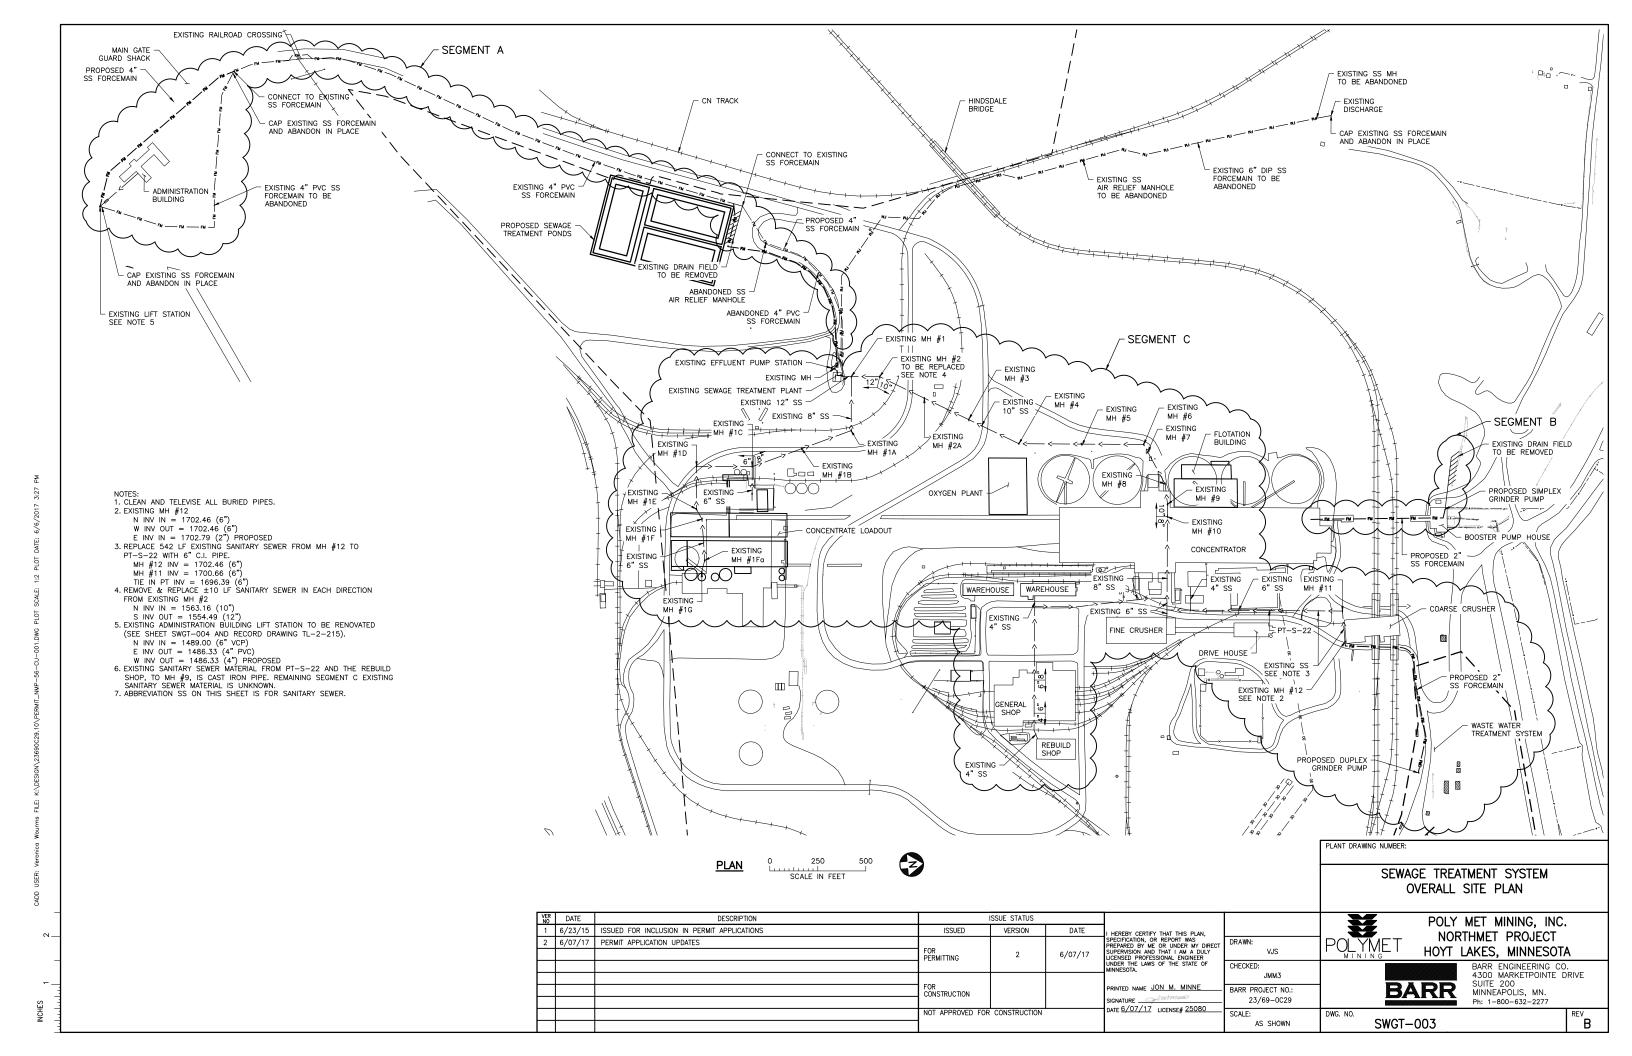



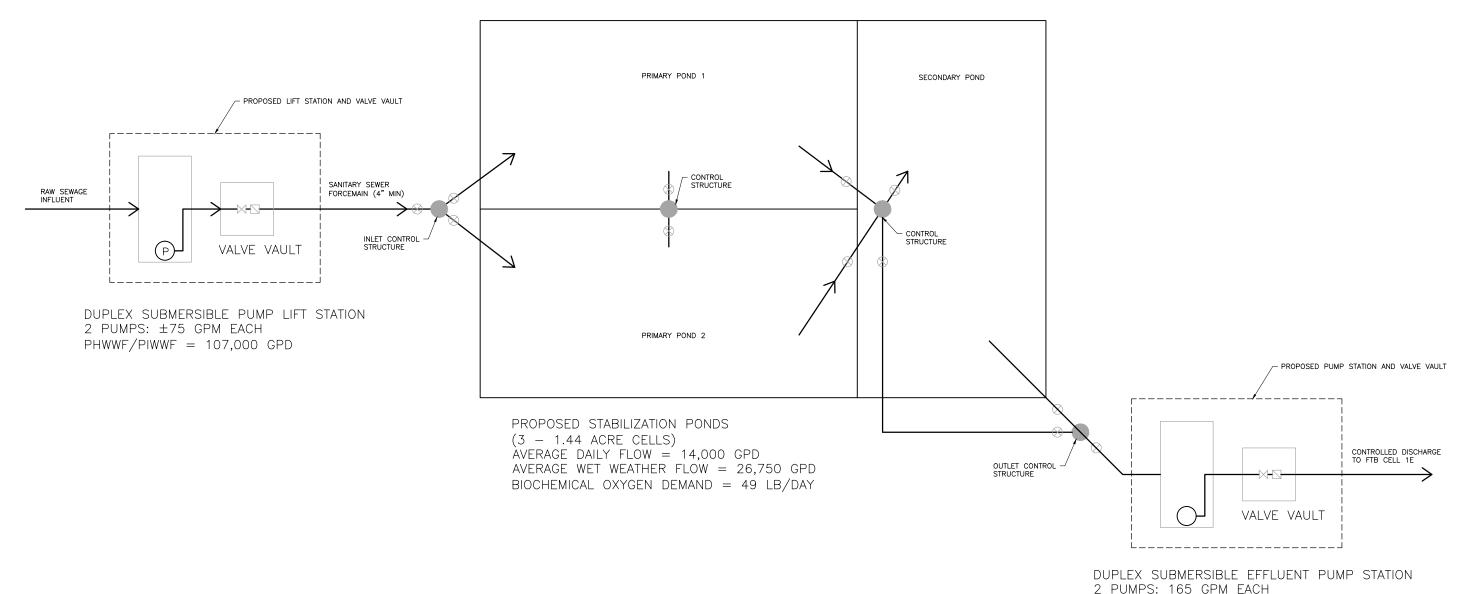

2 PUMPS: 165 GPM EACH POND DRAWDOWN = 0.5' PER DAY

PLANT DRAWING NUMBER:

								STABIL	GE TREATMENT SYSTEM IZATION PONDS OPTION ICESS FLOW DIAGRAM
VER NO	DATE	DESCRIPTION		ISSUE STATUS				**	POLY MET MINING, INC.
1	6/23/15	ISSUED FOR INCLUSION IN PERMIT APPLICATIONS	ISSUED	VERSION	DATE	I HEREBY CERTIFY THAT THIS PLAN.		<b>3</b>	NORTHMET PROJECT
2	6/07/17	PERMIT APPLICATION UPDATES	FOR			SPECIFICATION, OR REPORT WAS PREPARED BY ME OR UNDER MY DIRECT SUPERVISION AND THAT I AM A DULY	DRAWN:	1POLYMET	
			PERMITTING	2	0,0//1/	SUPERVISION AND THAT I AM A DULY LICENSED PROFESSIONAL ENGINEER UNDER THE LAWS OF THE STATE OF MINNESOTA.	KRM	MINING	HOYT LAKES, MINNESOTA
							CHECKED:		BARR ENGINEERING CO.
							ЈММ3		4300 MARKETPOINTE DRIVE SUITE 200
			CONSTRUCTION			PRINTED NAME JON M. MINNE	BARR PROJECT NO.:	l BA	SUITE 200 MINNEAPOLIS, MN.
						SIGNATURE OF THE STORE	23/69-0C29		Ph: 1-800-632-2277
			NOT APPROVED FOR	CONSTRUCTION	•	DATE 6/07/17 LICENSE# 25080	SCALE:	DWG. NO.	REV
			1				AS SHOWN	SWGT-	·004 I E