
Appendix 7 Hydrometallurgical Residue Facility Permit Application Support Drawings

POLY MET MINING, INC. NORTHMET PROJECT PERMIT SUPPORT DRAWINGS HYDROMETALLURGICAL RESIDUE FACILITY HOYT LAKES, MINNESOTA

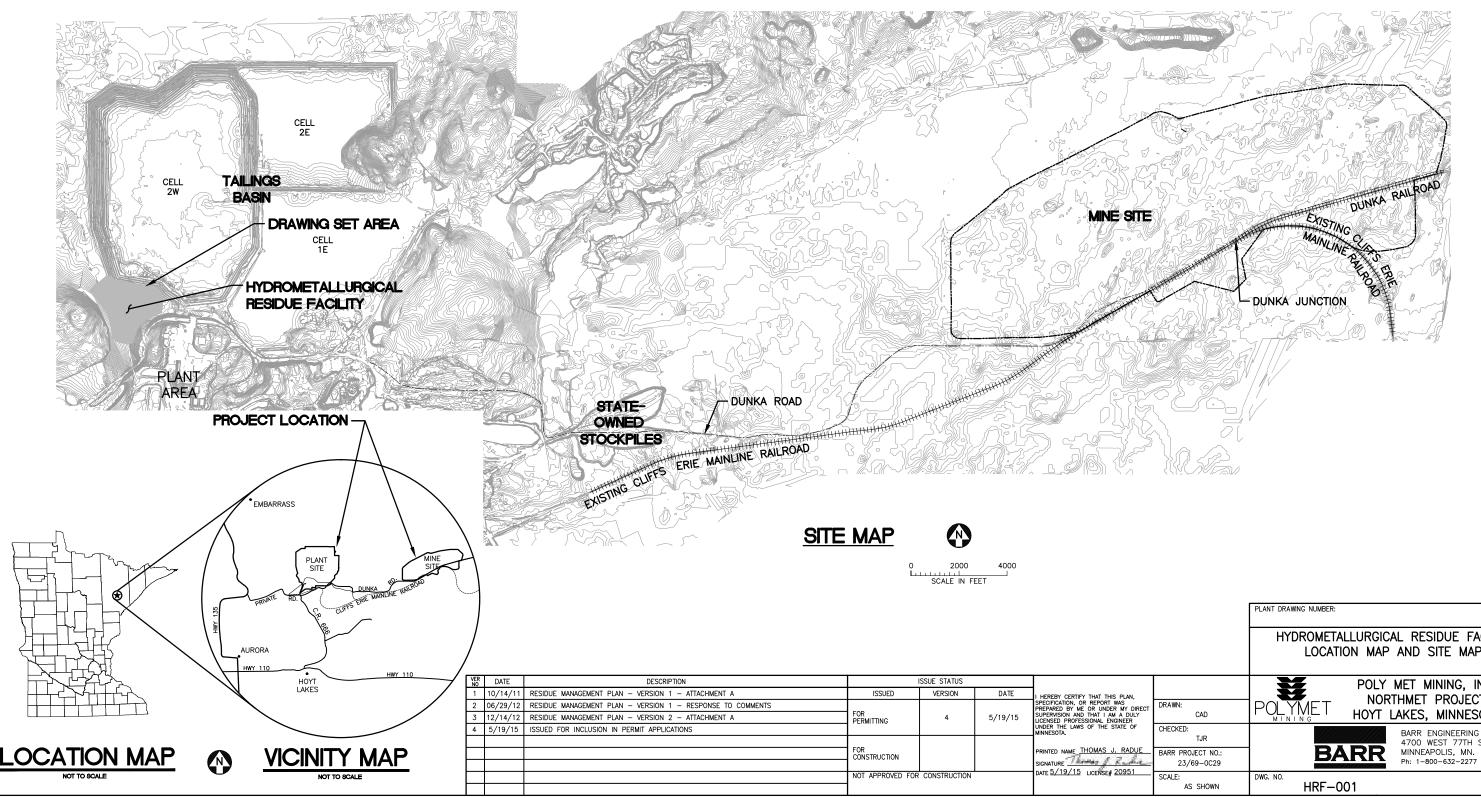

		PLANT DRAWING NUMBER:	
		HYDROMETALLURGICAL RESIDUE FACILT LOCATION MAP AND SITE MAP	Y
RECT	DRAWN: CAD	POLY MET MINING, INC. NORTHMET PROJECT HOYT LAKES, MINNESOTA	
	CHECKED: TJR BARR PROJECT NO.: 23/69-0C29	BARR ENGINEERING COM 4700 WEST 77TH STREE MINNEAPOLIS, MN. Ph: 1-800-632-2277	
-F	SCALE: AS SHOWN	DWG. NO. HRF-001	REV



GENERAL LEGEND

1000	EXISTING CONTOUR - MAJOR
	EXISTING CONTOUR - MINOR
1000	PROPOSED CONTOUR - MAJOR
	PROPOSED CONTOUR - MINOR
8	EXISTING POWER POLE
	EXISTING RAILROAD
	EXISTING ROAD
	EXISTING TRAIL
	EXISTING UNIMPROVED TRAIL
	EXISTING STRUCTURES
\sim	TREE LINE
<u>+</u>	WETLAND BOUNDARY
\rightarrow	EXISTING CULVERT
P	EXISTING PIPELINE
0E	OVERHEAD ELECTRIC
ţ	DISCHARGE POINT
ŕ	DEWATERING OUTLET POINT
ō	RETURN PUMP PAD
	DEWATERING PUMP
	SURFACE DRAINAGE
•	DRAINAGE COLLECTION STRUCTURE AND PIPE
	DRAINAGE AREA BOUNDARY
	PROPOSED DAMS
DW	PROPOSED DEWATERING PIPE
D	PROPOSED DISCHARGE PIPELINE
—— R ——	PROPOSED RETURN PIPELINE
\succ	PROPOSED CULVERT (NON-MINE DRAINAGE)
~	PROPOSED SEEPAGE COLLECTION DRAIN
	PROPOSED STORMWATER DRAIN
0	PROPOSED MANHOLE
	PROPOSED WICK DRAIN LATERAL PIPE
BSSES	PROPOSED RIP RAP
	FILL SLOPE
\succ	CUT SLOPE

CDSM	-	CEMENT DEEP SOIL MI
CMP	-	CORRUGATED METAL PI
CPEP	-	CORRUGATED POLYETHY
CY	-	CUBIC YARD
DR	-	DIMENSION RATIO
DWG	-	DRAWING
EL.	-	ELEVATION
F	-	DIAMETER
FTB	-	FLOTATION TAILINGS BA
GCL	-	GEOSYNTHETIC CLAY LI
HDPE	-	HIGH DENSITY POLYETH
HRF	-	HYDROMETALLURGICAL
LDPE	-	LOW DENSITY POLYETH
LF	-	LINER FEET
LTVSMC	-	LTV STEEL MINING COM
MCY	-	MILLION CUBIC YARDS
mil	-	one thousandth of an
MIN	-	MINIMUM
MSL	-	MEAN SEA LEVEL
NTS	-	NOT TO SCALE
SCH.	-	SCHEDULE
DR	-	DIMENSION RATIO
TYP.	-	TYPICAL

ABBREVIATIONS

APPROX.	_	APPROXIMATE
CDSM	-	CEMENT DEEP SOIL MIX
СМР	-	CORRUGATED METAL PIPE
CPEP	-	CORRUGATED POLYETHYLENE PIPE
CY	-	CUBIC YARD
DR	-	DIMENSION RATIO
DWG	-	DRAWING
EL.	-	ELEVATION
F	-	DIAMETER
FTB	-	FLOTATION TAILINGS BASIN
GCL	-	GEOSYNTHETIC CLAY LINER
HDPE	-	HIGH DENSITY POLYETHYLENE
HRF	-	HYDROMETALLURGICAL RESIDUE FACILITY
LDPE	-	LOW DENSITY POLYETHYLENE
LF	-	LINER FEET
LTVSMC	-	LTV STEEL MINING COMPANY
MCY	-	MILLION CUBIC YARDS
mil	-	one thousandth of an inch
MIN	-	MINIMUM
MSL	-	MEAN SEA LEVEL
NTS	-	NOT TO SCALE
SCH.	-	SCHEDULE
DR	-	DIMENSION RATIO
TYP	_	ΤΥΡΙΟΔΙ


SHEET INDEX

SHEET NO. TITLE

GENERAL DRAWINGS

HRF-002 HRF-003 HRF-004 HRF-005 HRF-005 HRF-0007 HRF-0009 HRF-0009 HRF-0100 HRF-0101 HRF-011 HRF-012 HRF-013 HRF-014 HRF-015 HRF-016 HRF-017 HRF-018 HRF-018 HRF-019	LOCATION MAP AND SITE MAP LEGEND AND SHEET INDEX EXISTING CONDITIONS RESIDUE FACILITY LAYOUT - MINE YEAR 20 EMERGENCY BASIN EXCAVATIONS AND REMOV SUBGRADE IMPROVEMENT AND SEEPAGE COL EMERGENCY BASIN PRELOAD PHASE 1 LAYOUT PHASE 2 LAYOUT PHASE 2 LAYOUT CROSS SECTIONS SUMP AND SIDE WALL RISER PLAN LAYOUT SUMP AND SIDE WALL RISER SECTIONS SUMP AND PUMP DETAILS PIPING PLAN AND PROFILE PIPING DETAILS PIPING DETAILS RETURN WATER PUMP RAFT CLOSURE PREPARATION PLAN
HRF-019	RETURN WATER PUMP RAFT
HRF-021 HRF-022 HRF-023	TEMPORARY COVER AND FINAL COVER GRADI FINAL CLOSURE GRADING AND DRAINAGE CLOSURE SECTIONS AND DETAILS
HRF-024	GEOTECHNICAL INSTRUMENTATION DETAILS

DRAWING NUMBERING

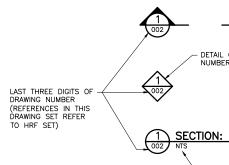

<u>NOTES</u>

1. COORDINATE SYSTEM IS MINNESOTA STATE PLANE NORTH ZONE, NAD83.

2. ELEVATIONS ARE MEAN SEA LEVEL (MSL), NAVD88.

3. EXISTING TOPOGRAPHIC INFORMATION SHOWN ON THE DRAWINGS WAS PREPARED BY AEROMETRIC, INC. FROM LIDAR DATA COLLECTED ON MARCH 17, 2010.

	VER NO	DATE	DESCRIPTION		ISSUE STATUS		
Γ	1	10/14/11	RESIDUE MANAGEMENT PLAN - VERSION 1 - ATTACHMENT A	ISSUED	VERSION	DATE	I HEREBY CERTIFY THAT THIS PLAN.
	2	06/29/12	RESIDUE MANAGEMENT PLAN - VERSION 1 - RESPONSE TO COMMENTS				SPECIFICATION, OR REPORT WAS PREPARED BY ME OR UNDER MY DIRE
	3	12/14/12	RESIDUE MANAGEMENT PLAN - VERSION 2 - ATTACHMENT A	FOR PERMITTING	4	5/19/15	SUPERVISION AND THAT I AM A DULY LICENSED PROFESSIONAL ENGINEER
	4	5/19/15	ISSUED FOR INCLUSION IN PERMIT APPLICATIONS				UNDER THE LAWS OF THE STATE OF MINNESOTA.
				FOR CONSTRUCTION			PRINTED NAME THOMAS J. RADUE
							SIGNATURE 7
				NOT APPROVED FOR	CONSTRUCTION.		DATE 57 157 15 LICENSE# 20951

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		HYDROMETALLURGICAL RESIDUE FACILT LEGEND AND SHEET INDEX	Y
N, DIRECT NULY R OF	DRAWN: CAD	POLYMET MINING, INC. NORTHMET PROJECT HOYT LAKES, MINNESOTA	
DUE	CHECKED: TJR BARR PROJECT NO.: 23/69-0C29	BARR ENGINEERING COMI 4700 WEST 77TH STREE MINNEAPOLIS, MN. Ph: 1-800-632-2277	
51	SCALE: AS SHOWN	DWG. NO. HRF-002	REV


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-NTS = NOT TO SCALE

- DETAIL OR SECTION NUMBER, TYPICAL


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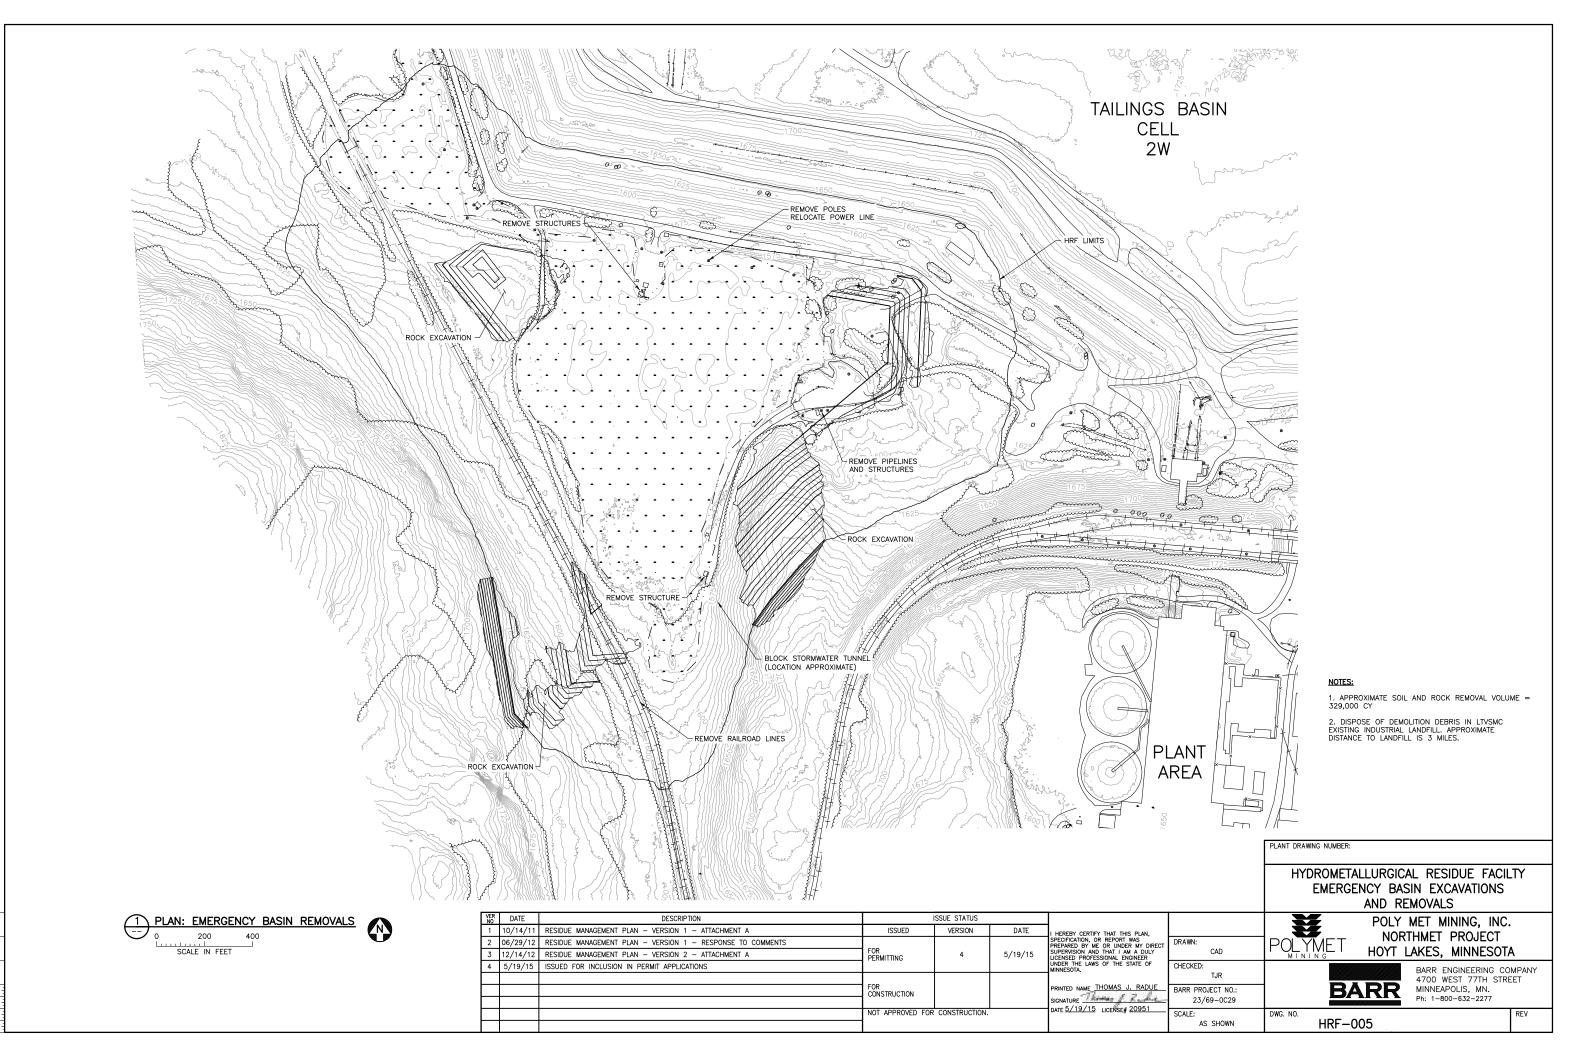



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	CHECKED:	BARR ENGINEERING	
F UE	TJR BARR PROJECT NO.:	BARR NINNEAPOLIS, MN. Ph: 1-800-632-2277	


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ER OF	CHECKED: TJR BARR PROJECT NO.: 23/69-0C29	BARR ENGINEERING COMPANY 4700 WEST 77TH STREET MINNEAPOLIS, MN. Ph: 1-800-632-2277
951	SCALE: AS SHOWN	DWG. NO. REV

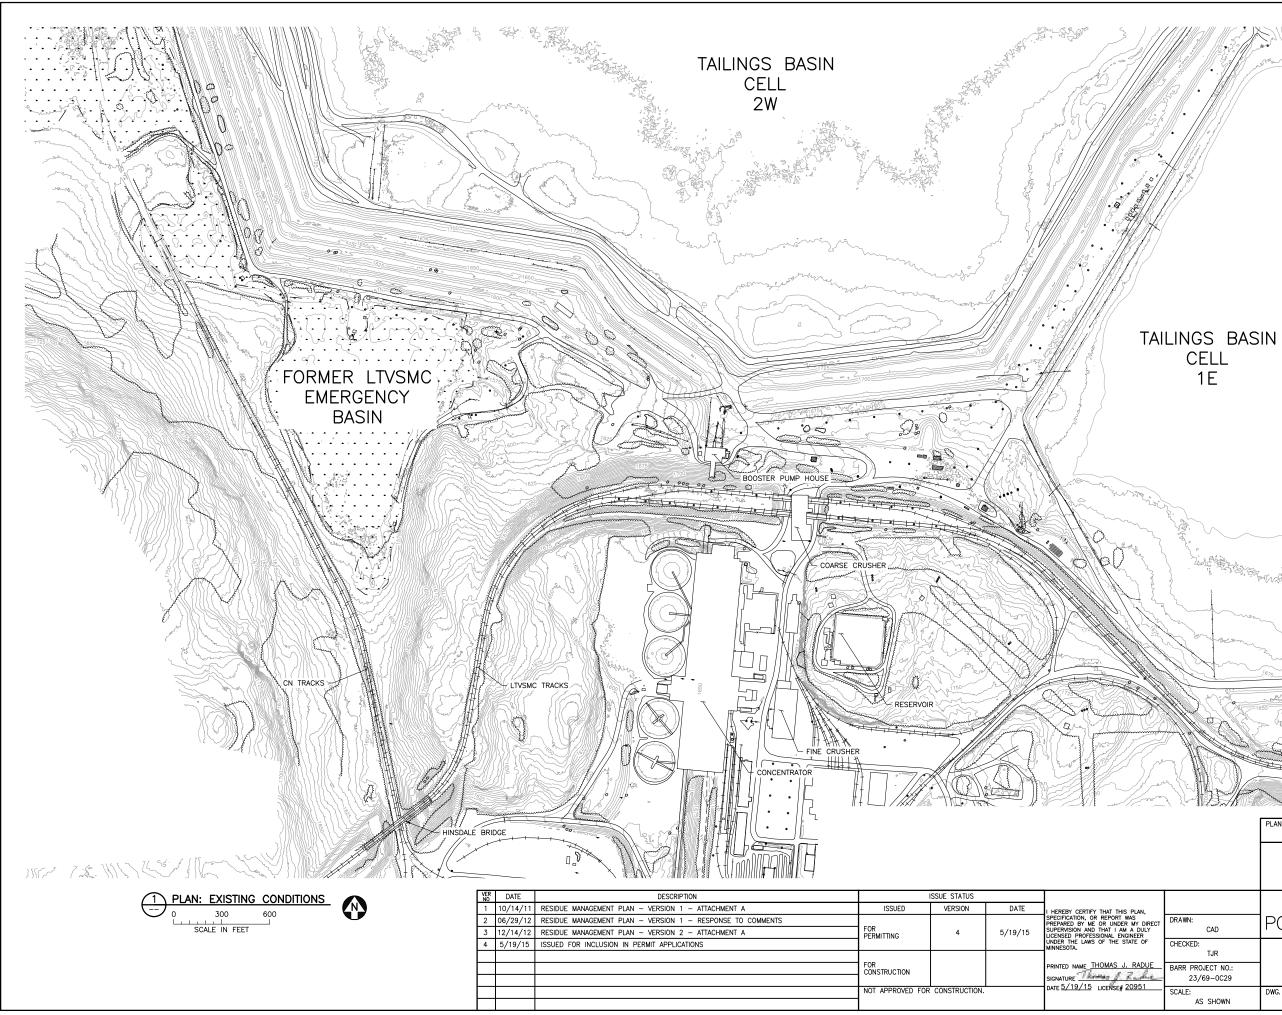



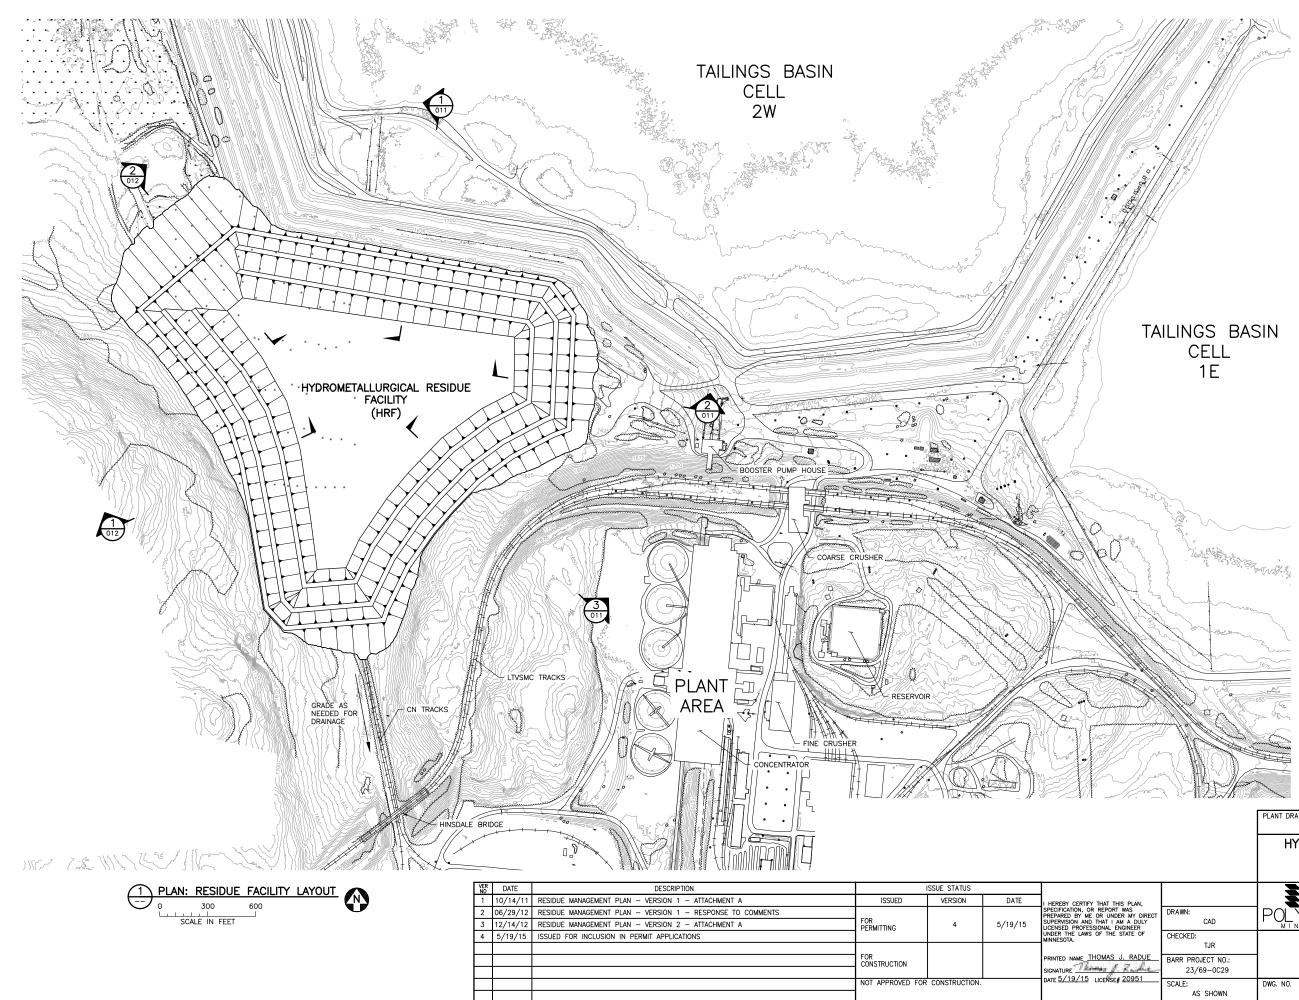
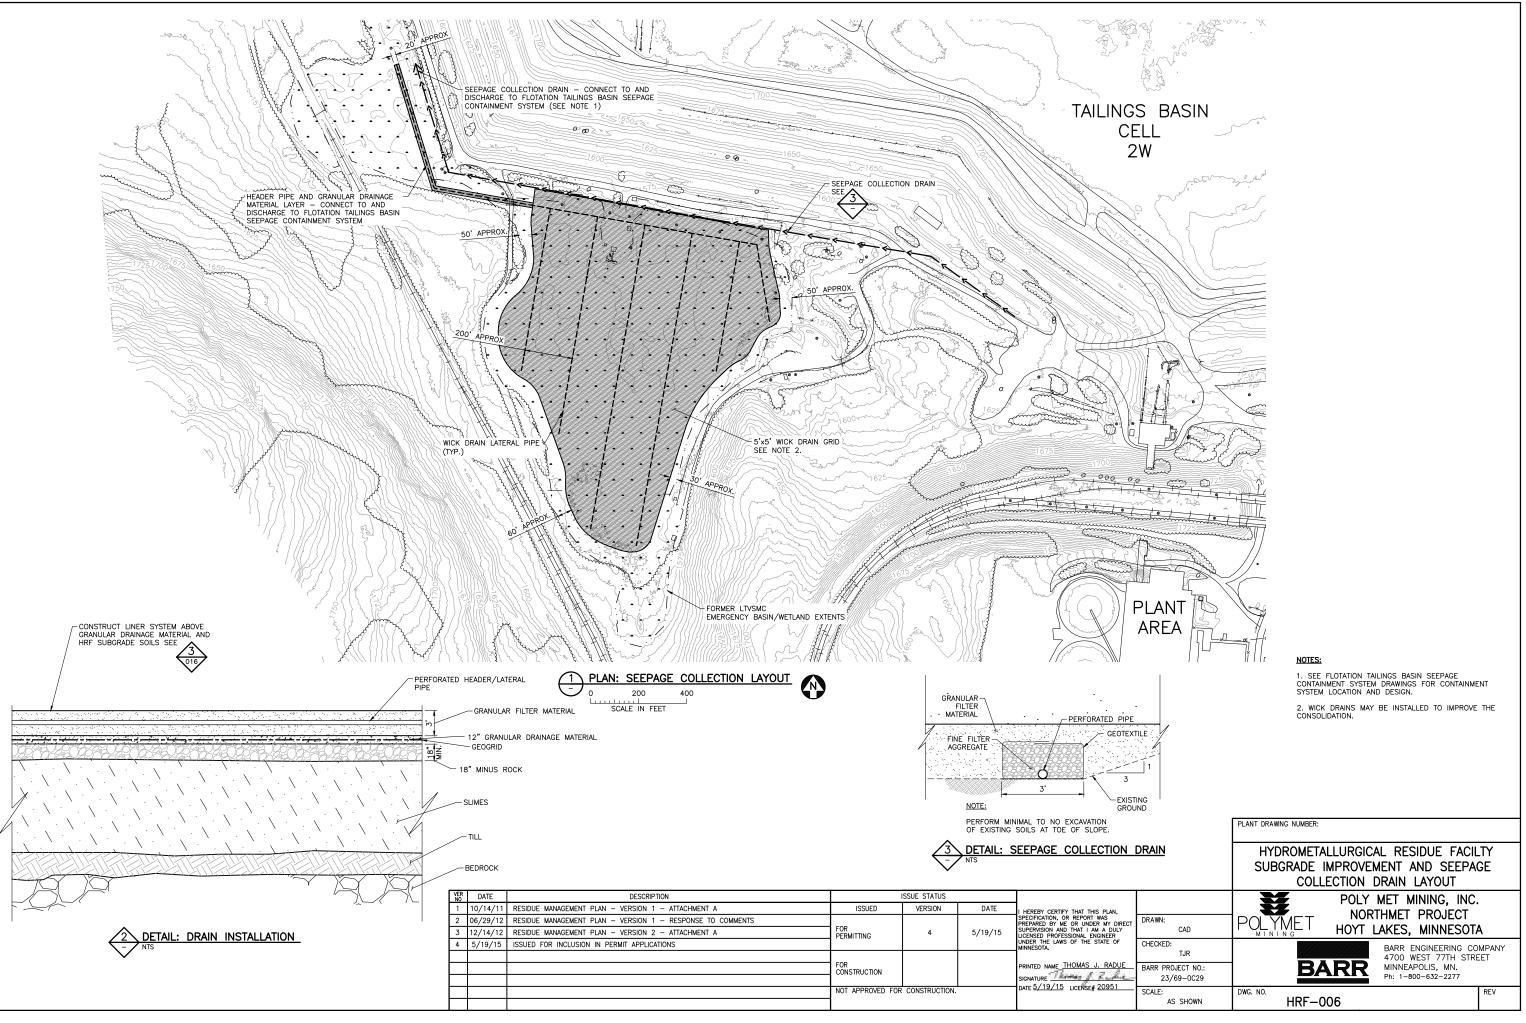
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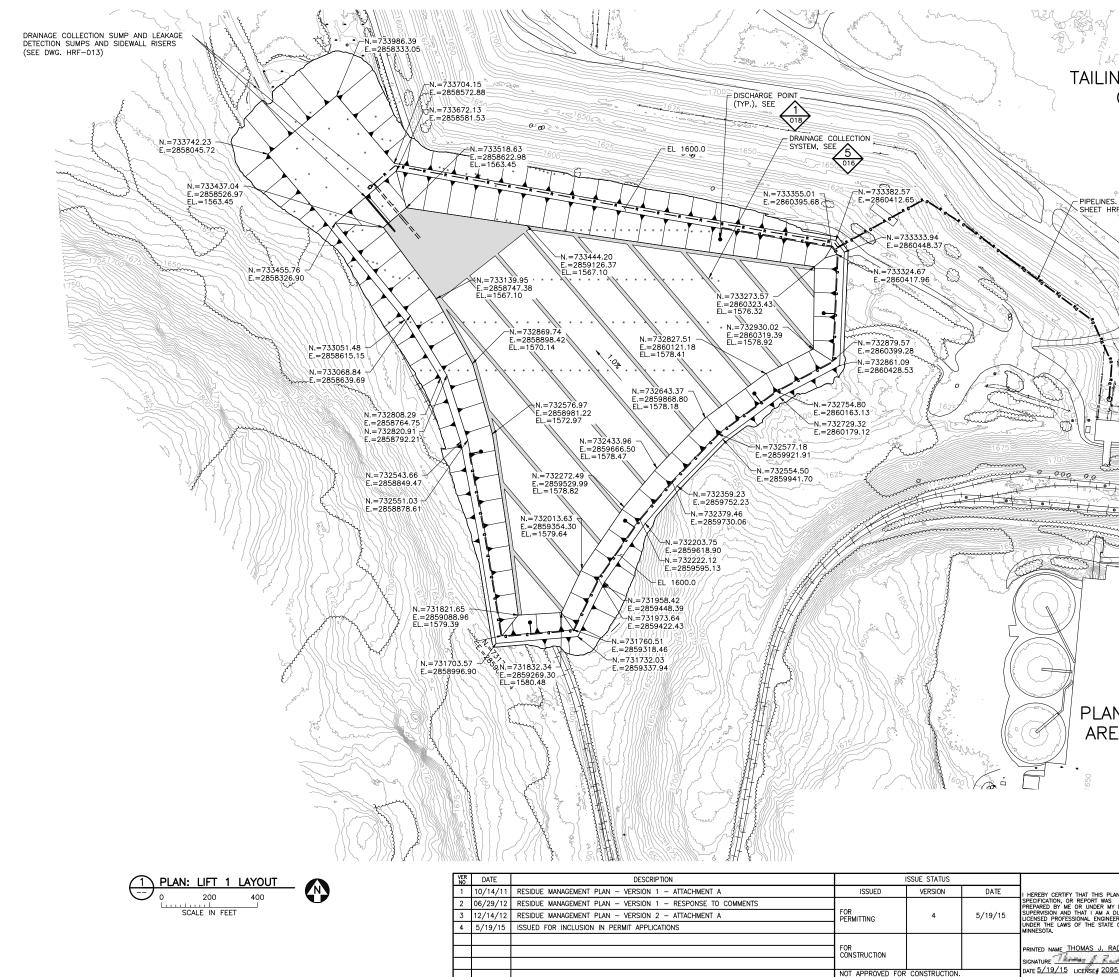
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I, DIRECT JLY SF	DRAWN: CAD	POLY MET MINING, INC NORTHMET PROJECT HOYT LAKES, MINNESOT	
DUE 51	CHECKED: TJR BARR PROJECT NO.: 23/69-0C29	BARR ENGINEERING C 4700 WEST 77TH STF MINNEAPOLIS, MN. Ph: 1-800-632-2277	
1	SCALE: AS SHOWN	DWG. NO. HRF-007	REV
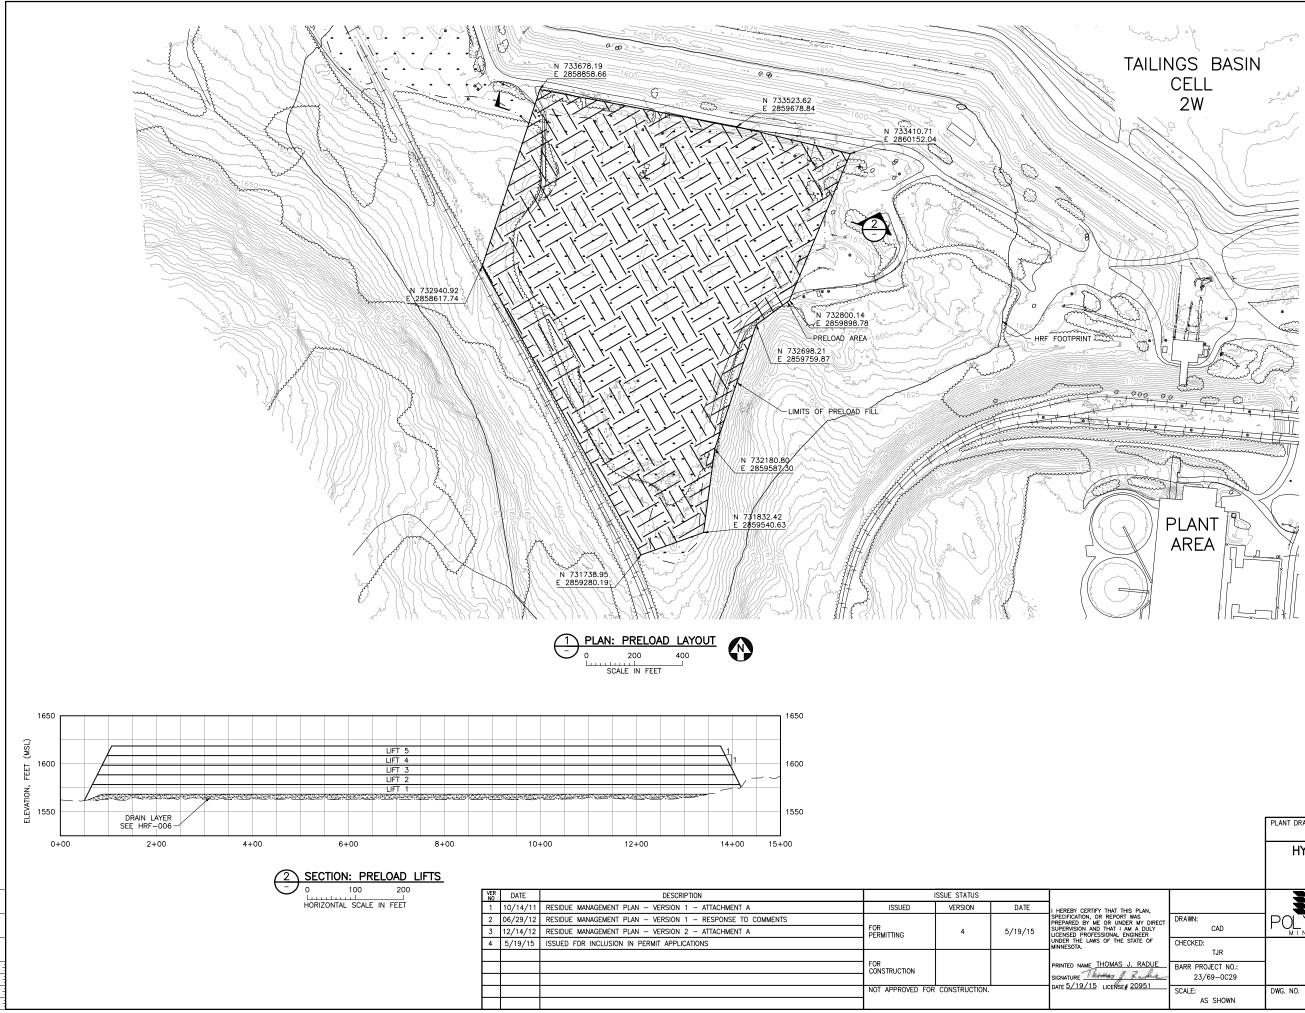
### NOTES:


1. PRELOAD AREA USING SOIL AND ROCK REMOVED FOR HRF (SEE DWG. HRF-005).

2. SOIL AND ROCK PRELOAD MATERIAL TO BE REMOVED TO HRF LINER GRADE AND UTILIZED FOR HRF DAM CONSTRUCTION.


3. NUMBER OF PRELOAD LIFTS IS PRELIMINARY.



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IS. SEE IRF-017	
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	NOTES:
	3. PLACE HRF LINER OVER BASE AND INTERIOR SLOPES OF CELL. SEE DWG. HRF-016.
	PLANT DRAWING NUMBER:
	HYDROMETALLURGICAL RESIDUE FACILTY LIFT 1 LAYOUT
PLAN, SM DIRECT DRAWN: DULY CAD EER E OF CHECKED:	POLY MET MINING, INC. POLYMET HOYT LAKES, MINNESOTA
TJR BARR PROJECT NO.:	BARR ENGINEERING COMPANY 4700 WEST 77TH STREET MINNEAPOLIS, MN. Ph: 1-800-632-2277
23/69-0C29 951 SCALE: AS SHOWN	DWG. NO. REV

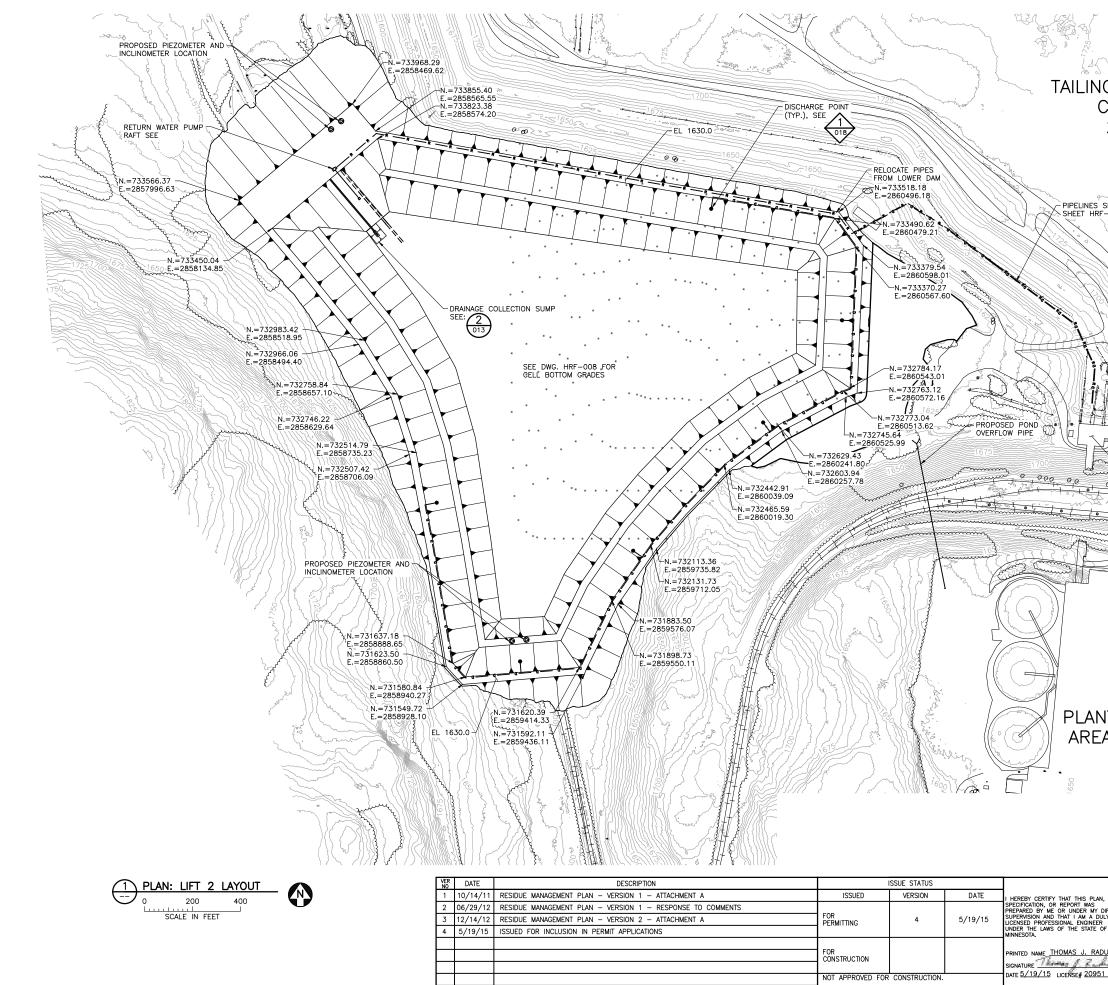


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LAN, MY DIRECT DRAWN: DULY EER E OF CHECKED: TJR BARR PROJECT NO.: 23/69-0C29 951 SCALE: DWG. NO. NORTHMET PROJECT HOYT LAKES, MINNESOTA BARR ENGINEERING COMPANY 4700 WEST 77TH STREET MINNEAPOLIS, MN. Ph: 1-800-632-2277 REV		HYDROMETALLURGICAL RESIDUE FACILTY	_
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	BARR PROJECT NO.:           23/69-0C29           951           SCALE:	BARR         MINNEAPOLIS, MN.           Ph: 1-800-632-2277         Ph: 1-800-632-2277	

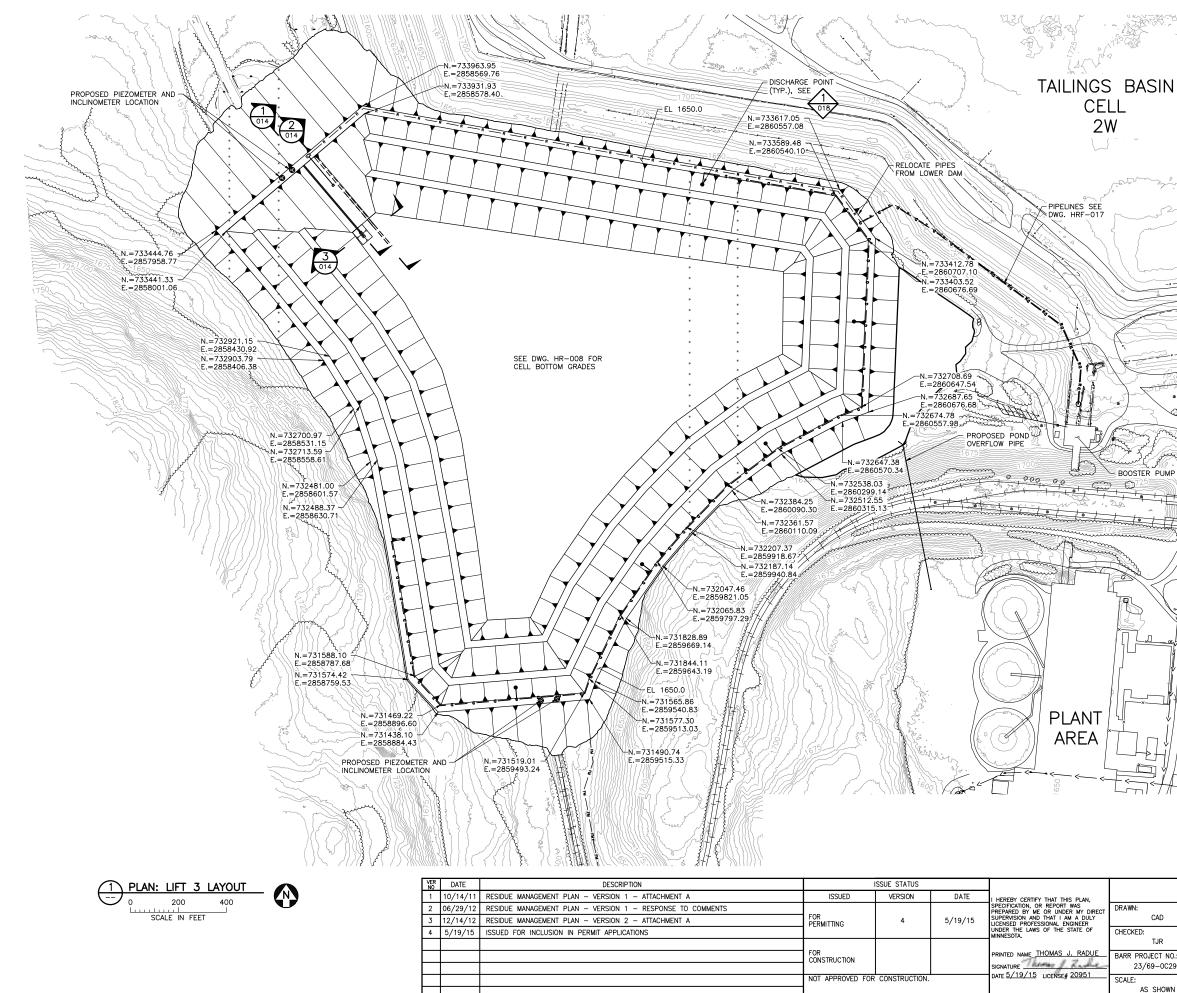

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	1. LIFT 3 CONSTRUCTION YEAR TO BE BASED ON HRF CAPACITY CONSUMPTION RATE.
	2. UPPER LINER SURFACE SHOWN.
	3. PLACE HRF LINER OVER BASE AND INTERIOR SLOPES OF CELL. SEE DWG. HRF-016.
NT / 🖳 🗍 🕌	SLOPES OF CELL. SEE DWG. HINI-OTO.
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	PLANT DRAWING NUMBER:
	HYDROMETALLURGICAL RESIDUE FACILTY
	LIFT 3 LAYOUT
AN,	POLY MET MINING, INC.
Y DIRECT DULY CAD ER E OF CHECKED:	POLYMET HOYT LAKES, MINNESOTA
	BARR ENGINEERING COMPANY
ADUE BARR PROJECT NO.:	4700 WEST 77TH STREET MINNEAPOLIS, MN. bit 1=800-632-2277
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SCALE: AS SHOWN	DWG. NO. REV


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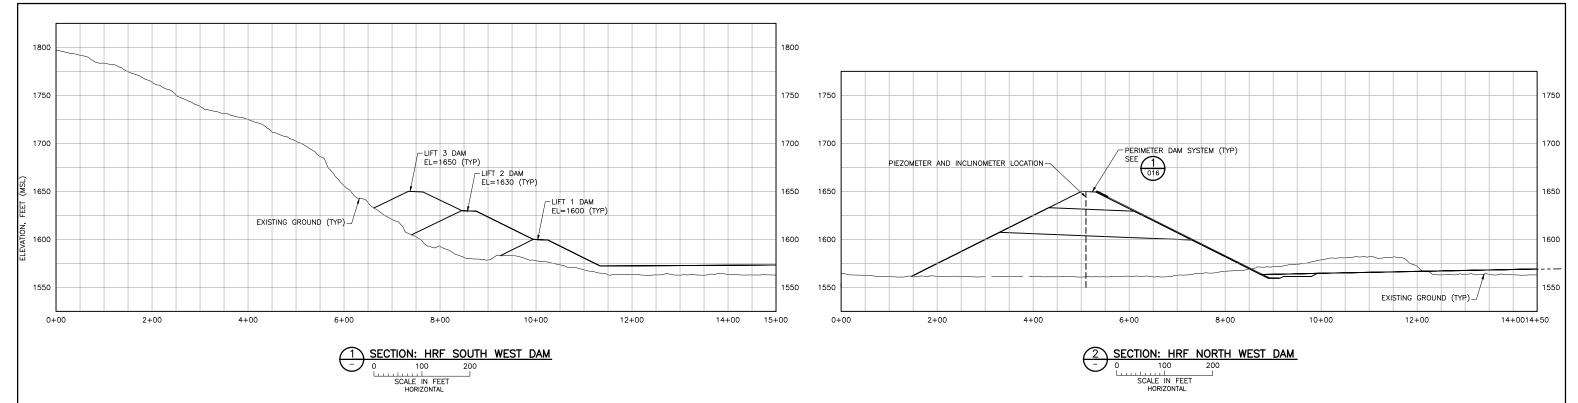

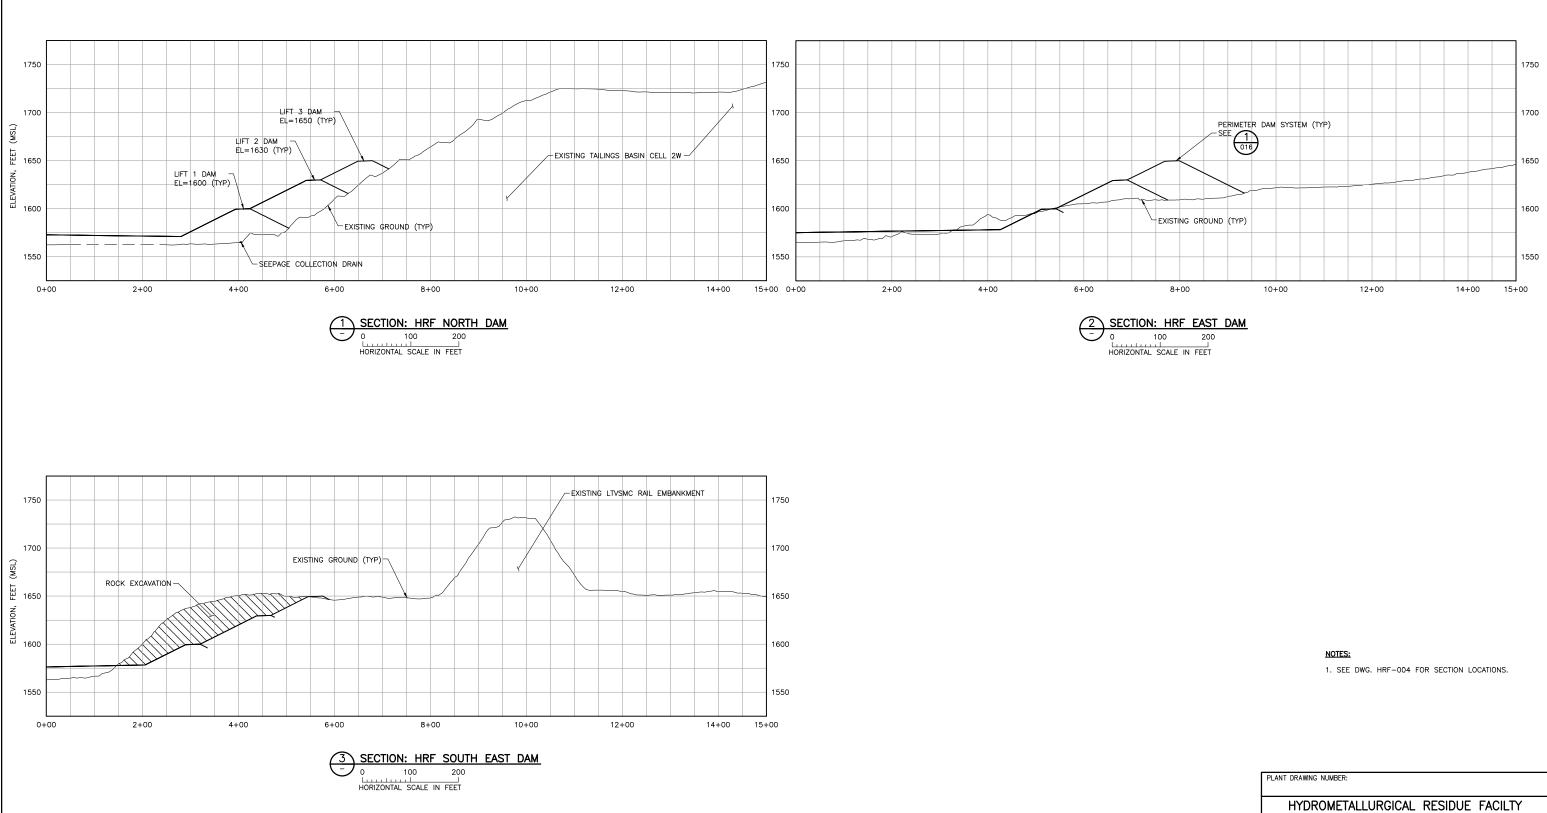
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2	06/29/12	RESIDUE MANAGEMENT PLAN - VERSION 1 - RESPONSE TO COMMENTS				SPECIFICATION, OR REPORT WAS PREPARED BY ME OR UNDER MY DIRE
3	12/14/12	RESIDUE MANAGEMENT PLAN – VERSION 2 – ATTACHMENT A	FOR PERMITTING	4		SUPERVISION AND THAT I AM A DULY
4	5/19/15	ISSUED FOR INCLUSION IN PERMIT APPLICATIONS				UNDER THE LAWS OF THE STATE OF MINNESOTA.
			FOR CONSTRUCTION			PRINTED NAME THOMAS J. RADUE
						SIGNATURE
			NOT APPROVED FOR	CONSTRUCTION.		DATE 07 197 10 LICENSE# 20951
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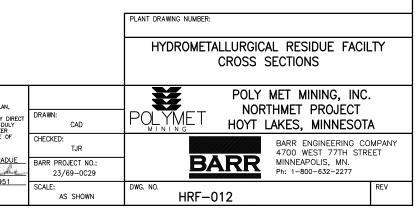



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1	10/14/11	RESIDUE MANAGEMENT PLAN - VERSION 1 - ATTACHMENT A	ISSUED	VERSION	DATE	I HEREBY CERTIFY THAT THIS PLAN.
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3	12/14/12	RESIDUE MANAGEMENT PLAN – VERSION 2 – ATTACHMENT A	FOR PERMITTING	4	5/19/15	SUPERVISION AND THAT I AM A DULY LICENSED PROFESSIONAL ENGINEER
4	5/19/15	ISSUED FOR INCLUSION IN PERMIT APPLICATIONS				UNDER THE LAWS OF THE STATE OF MINNESOTA.
			FOR CONSTRUCTION			PRINTED NAME THOMAS J. RADUE
						SIGNATURE
			NOT APPROVED FOR	CONSTRUCTION.		DATE 37 197 13 LICENSE# 20931

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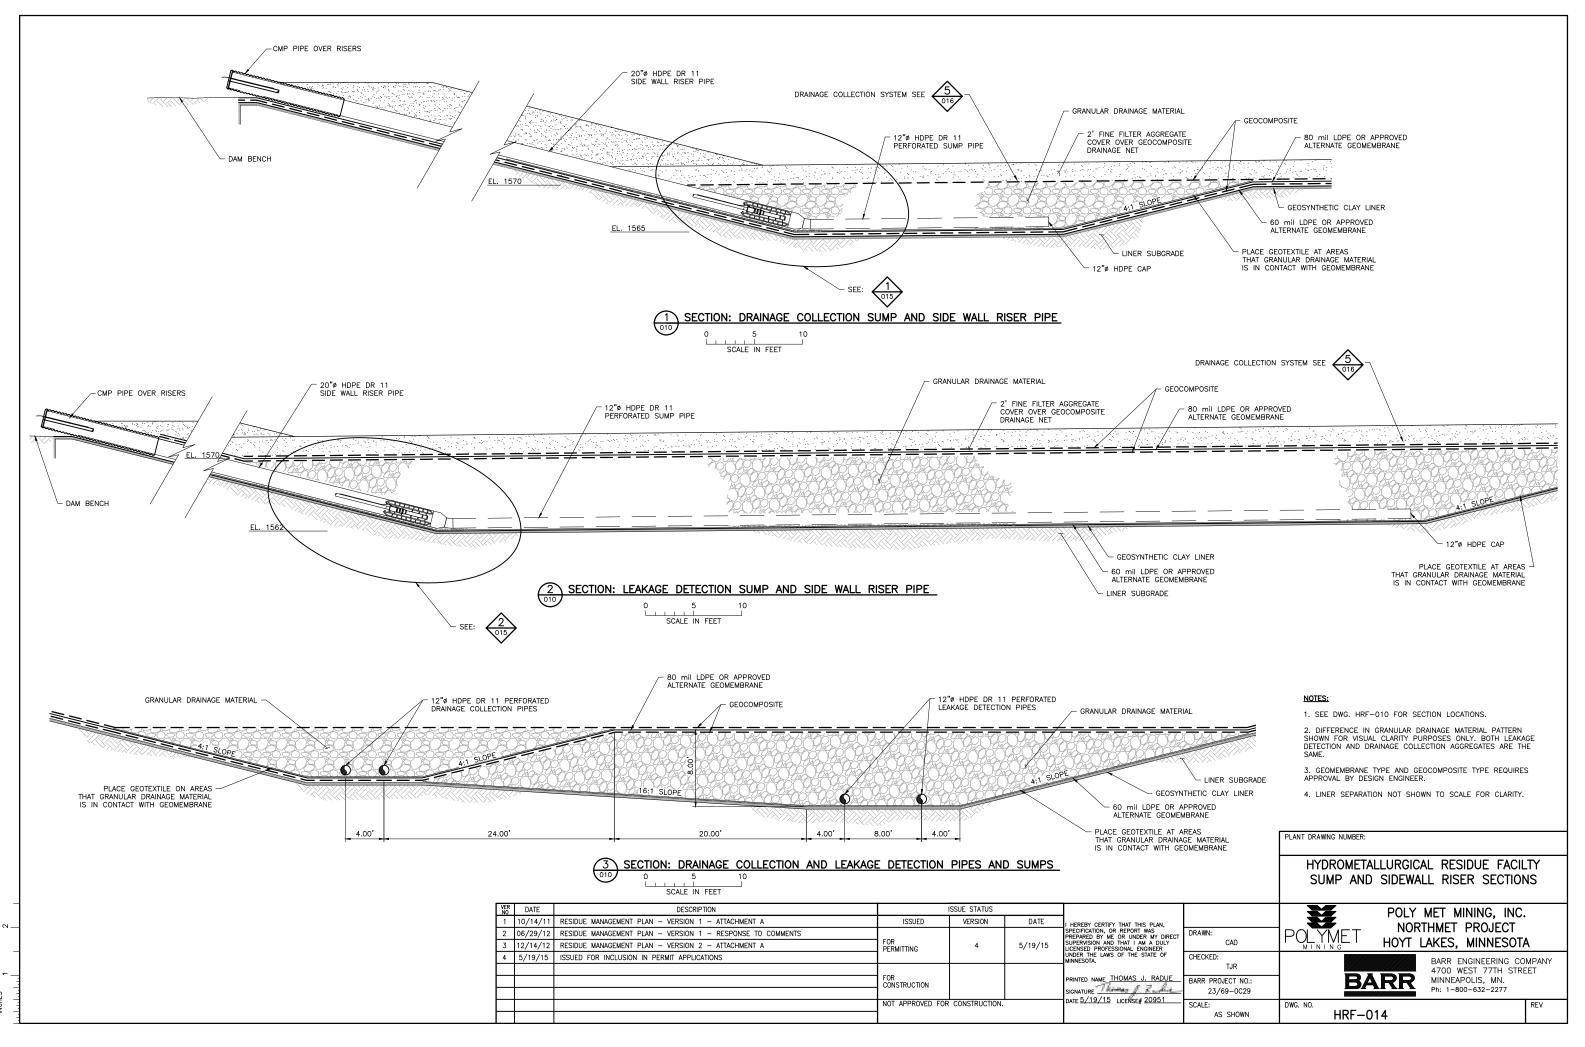
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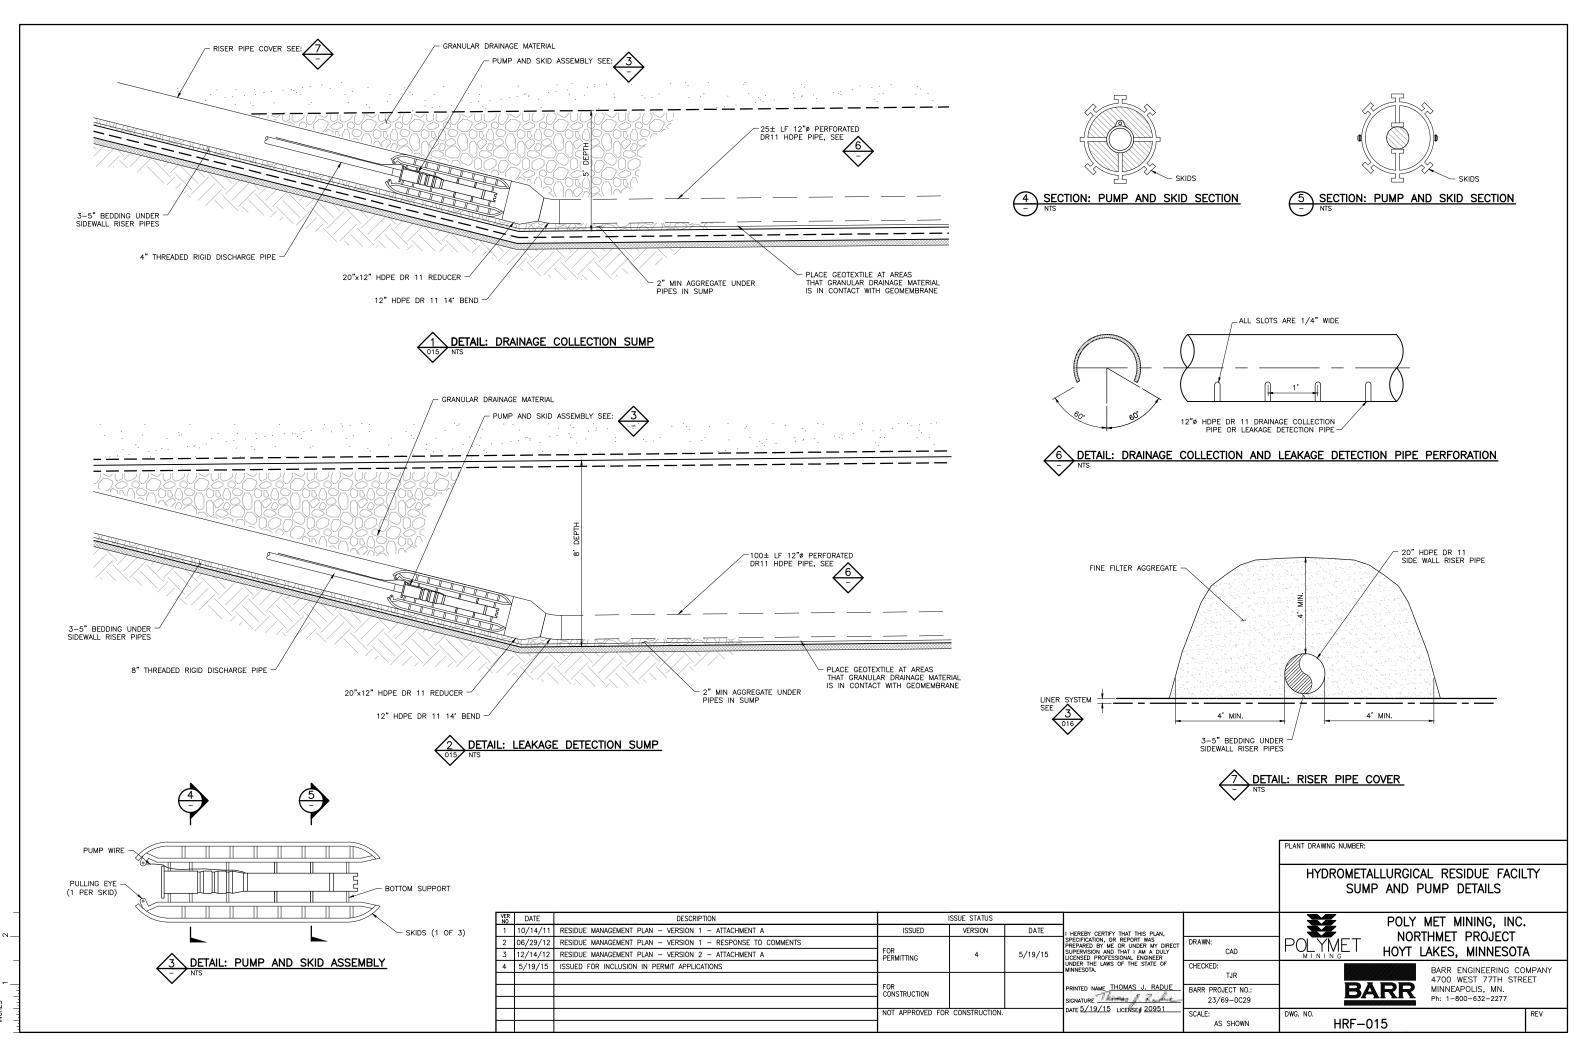


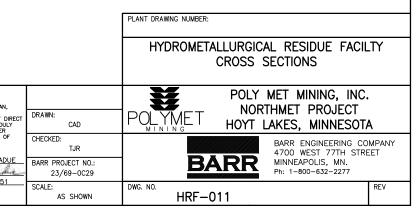


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4	5/19/15	ISSUED FOR INCLUSION IN PERMIT APPLICATIONS				UNDER THE LAWS OF THE STATE OF MINNESOTA.
			FOR CONSTRUCTION			PRINTED NAME THOMAS J. RADU
						SIGNATURE
			NOT APPROVED FOR	CONSTRUCTION.		DATE 57 137 15 LICENSE# 20951


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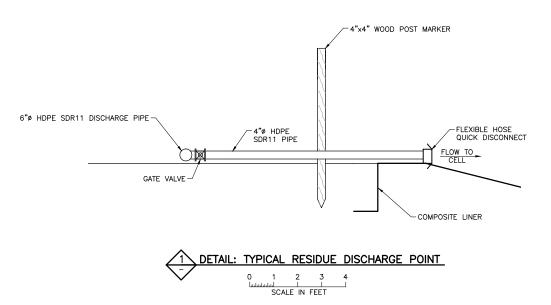


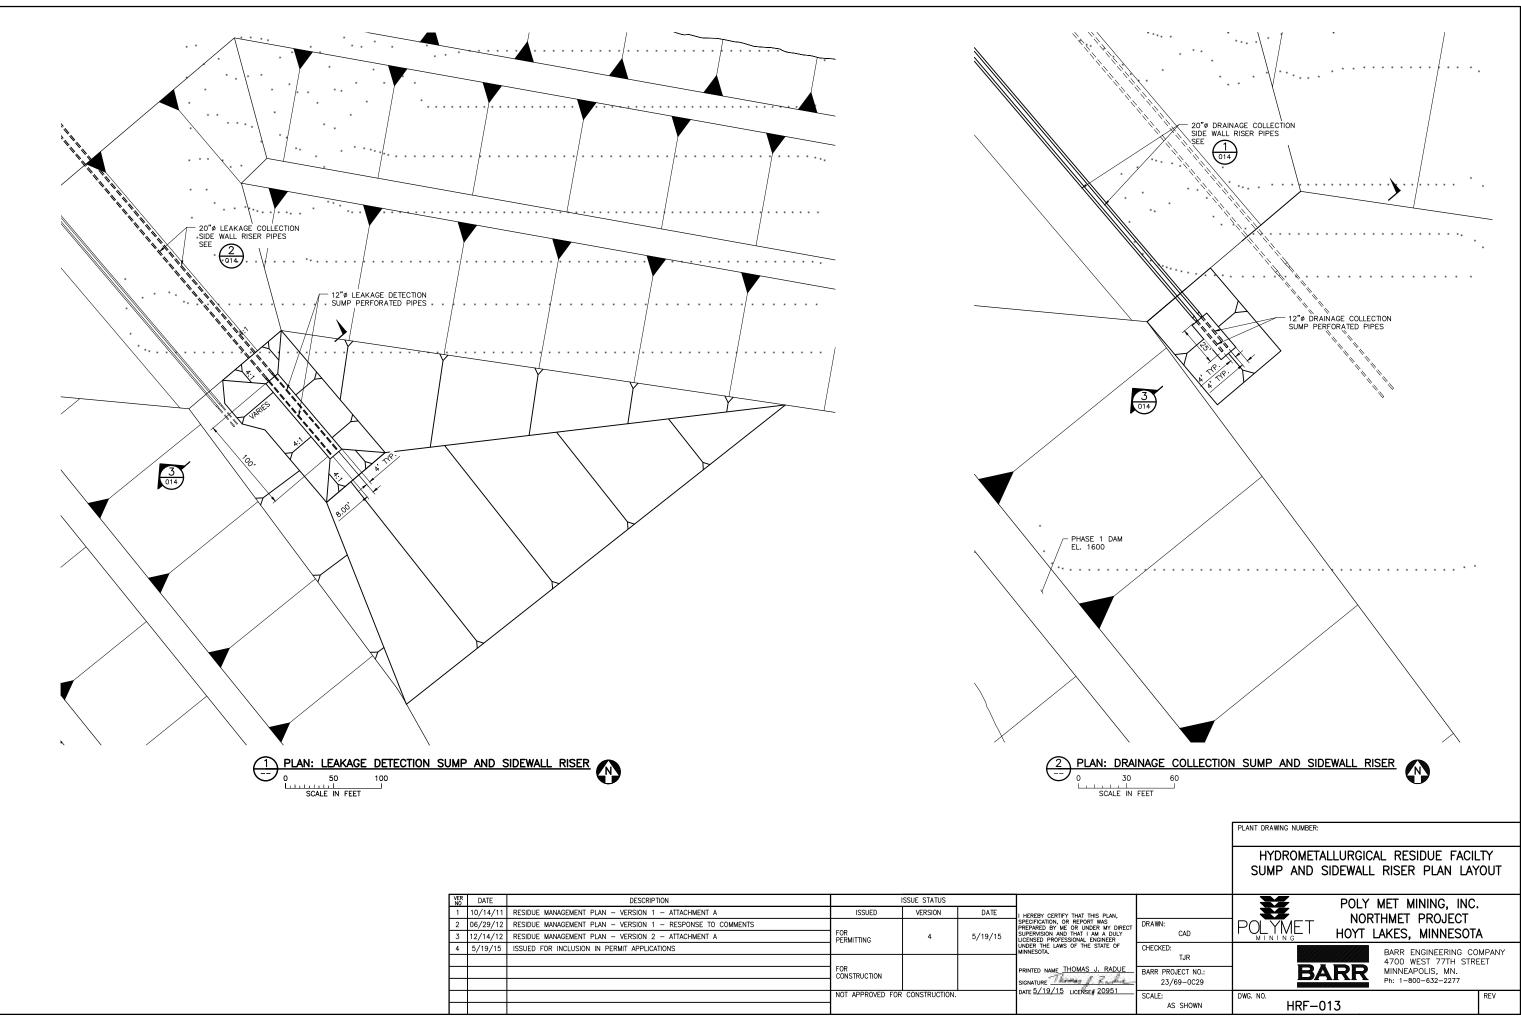

		PLANT DRAWING NUMBER:			
		HYDROMETALLURGICAL RESIDUE FACILTY TYPICAL SECTIONS AND DETAILS			
AN, DIRECT DULY ER OF	DRAWN: CAD	POLY MET MINING, INC. NORTHMET PROJECT HOYT LAKES, MINNESOTA			
ADUE	CHECKED: TJR BARR PROJECT NO.: 23/69-0C29	BARR ENGINEERING COMPAI 4700 WEST 77TH STREET MINNEAPOLIS, MN. Ph: 1-800-632-2277	NY		
51	SCALE: AS SHOWN	DWG. NO. HRF-016			

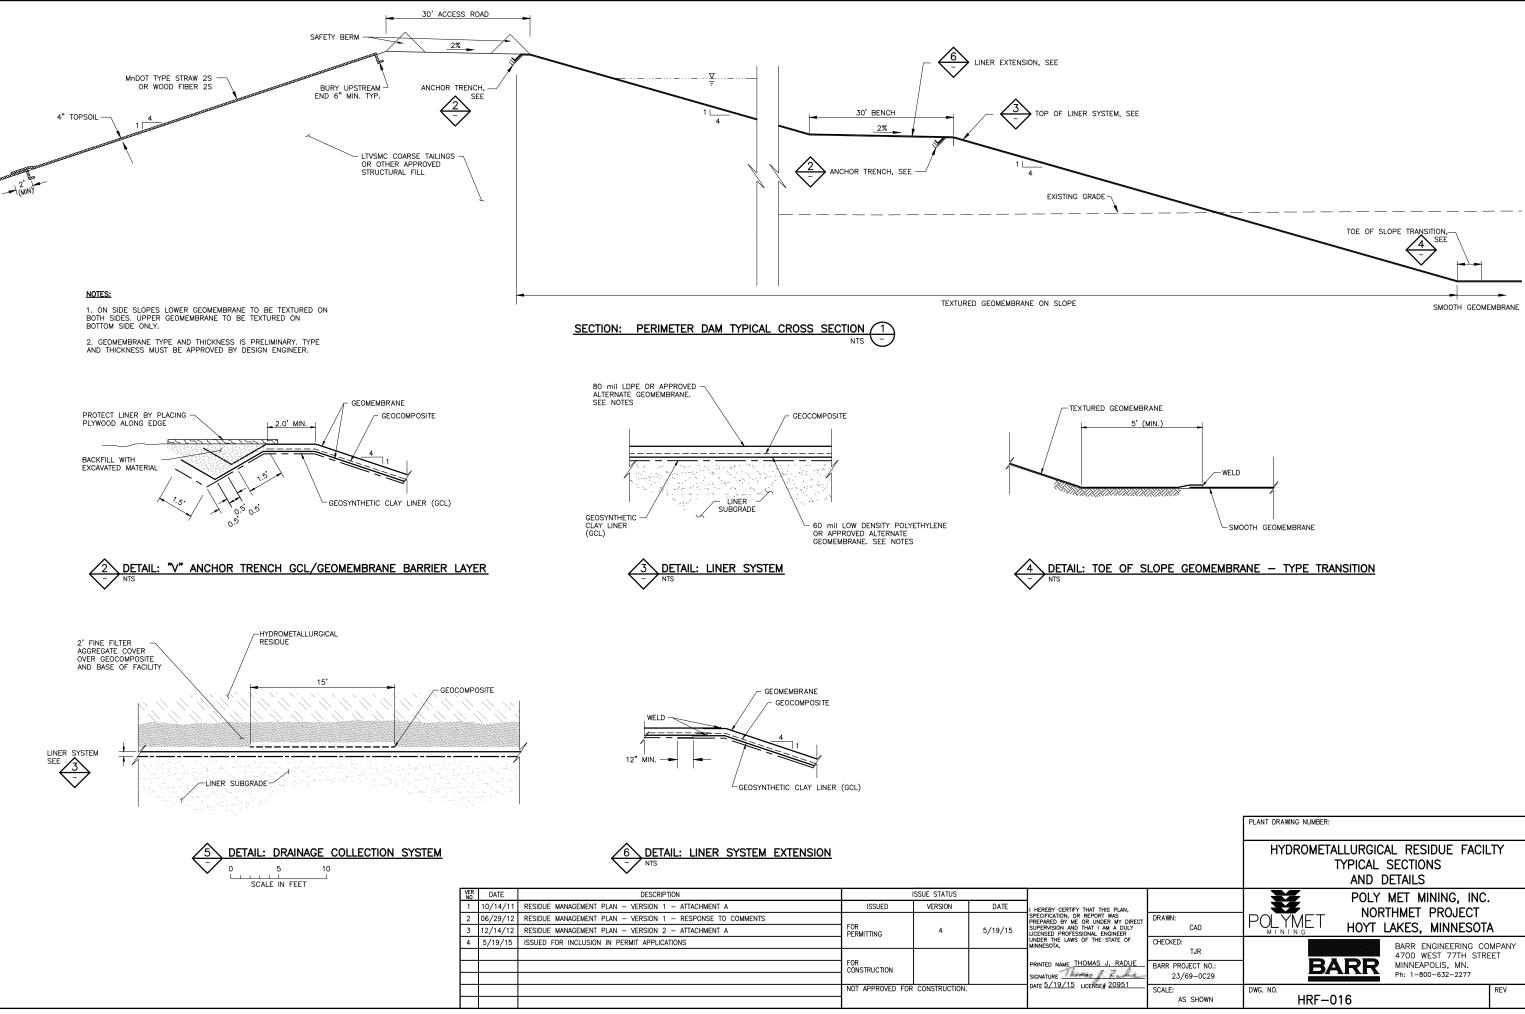


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4	5/19/15	ISSUED FOR INCLUSION IN PERMIT APPLICATIONS				UNDER THE LAWS OF THE STATE OF MINNESOTA.
			FOR CONSTRUCTION			PRINTED NAME THOMAS J. RADU
						SIGNATURE
			NOT APPROVED FOR	CONSTRUCTION.		DATE 07 197 10 LICENSE# 20931

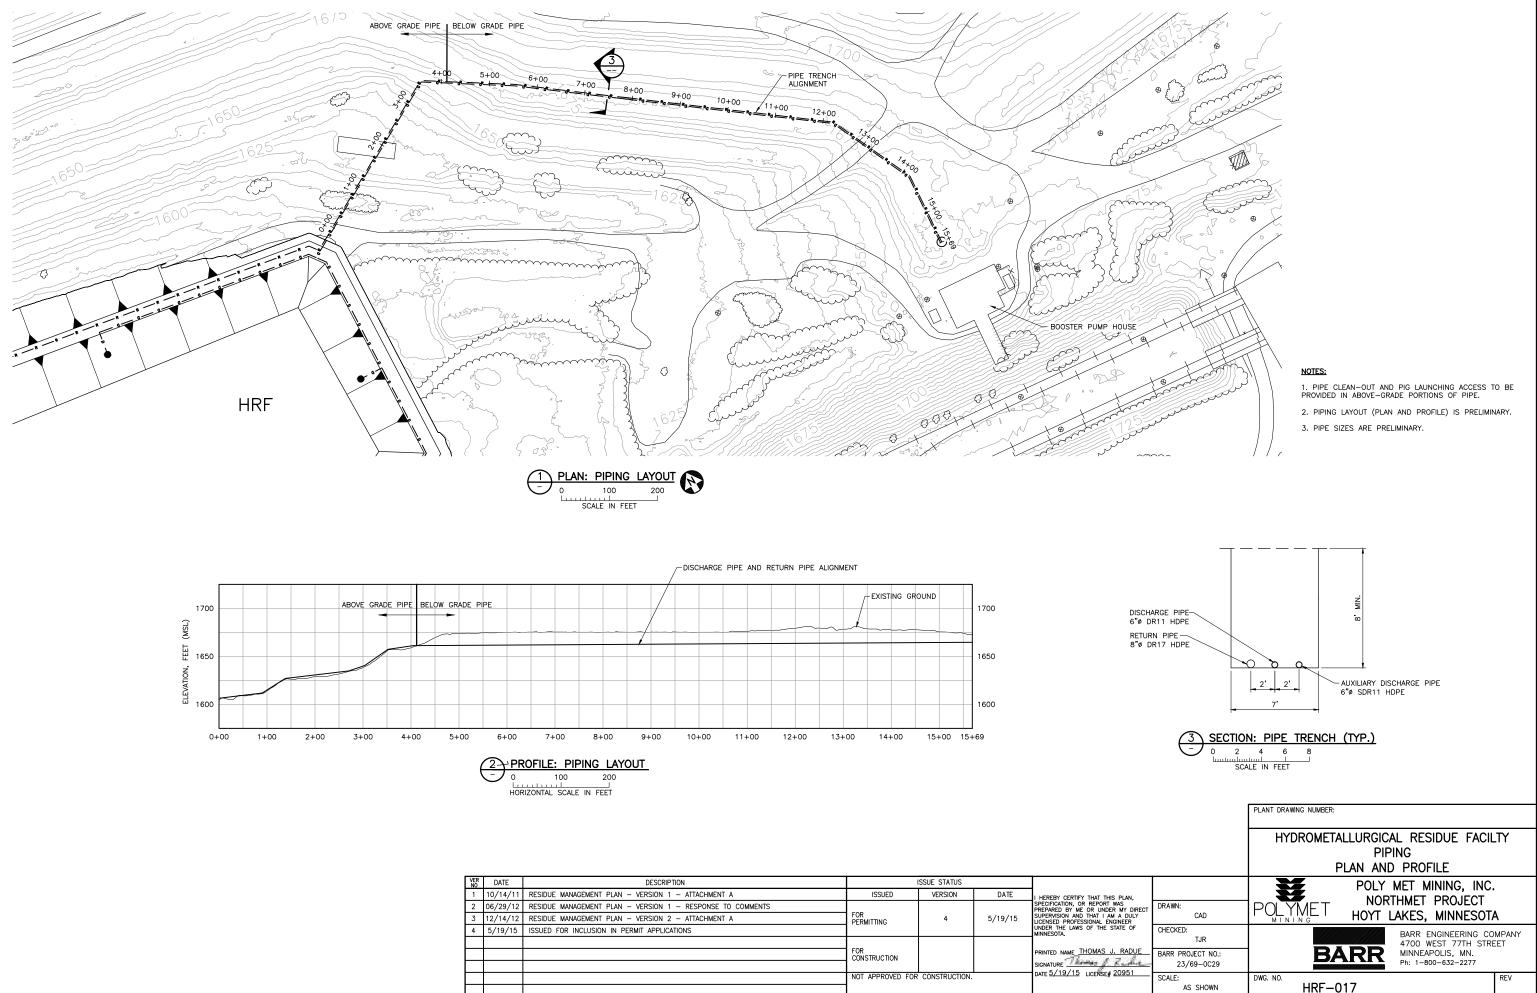



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3	12/14/12	RESIDUE MANAGEMENT PLAN - VERSION 2 - ATTACHMENT A	FOR PERMITTING	4		SUPERVISION AND THAT I AM A DULY LICENSED PROFESSIONAL ENGINEER
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			FOR CONSTRUCTION			PRINTED NAME THOMAS J. RADU
						SIGNATURE
			NOT APPROVED FOR	CONSTRUCTION.		DATE <u>5/19/15</u> LICENSE# <u>20951</u>

		PLANT DRAWING NUMBER:	
		HYDROMETALLURGICAL RESIDUE FACILT PIPING DETAILS	Y
N, DIRECT NULY R OF	DRAWN: CAD	POLY MET MINING, INC. NORTHMET PROJECT HOYT LAKES, MINNESOTA	
DUE	CHECKED: TJR BARR PROJECT NO.: 23/69-0C29	BARR ENGINEERING COMF 4700 WEST 77TH STREET MINNEAPOLIS, MN. Ph: 1-800-632-2277	
51	SCALE: AS SHOWN	DWG. NO. HRF-018	REV

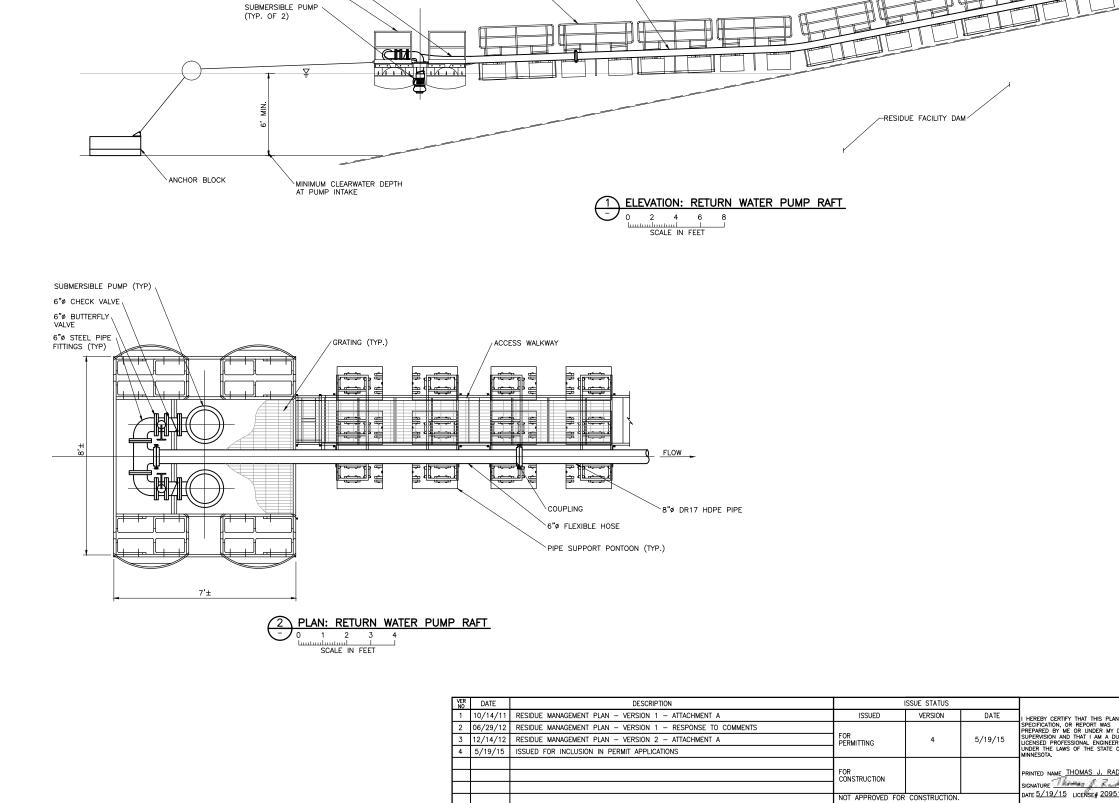


8"ø DR17 HDPE RETURN WATER PIPE


ACCESS WALKWAY


6"Ø FLEXIBLE HOSE \


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DUE	CHECKED: TJR BARR PROJECT NO.: 23/69-0C29	BARR ENGINEERING COMF 4700 WEST 77TH STREET MINNEAPOLIS, MN. Ph: 1-800-632-2277		
51	SCALE: AS SHOWN	HRF-019	EV	




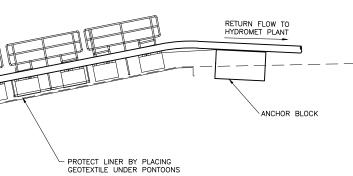


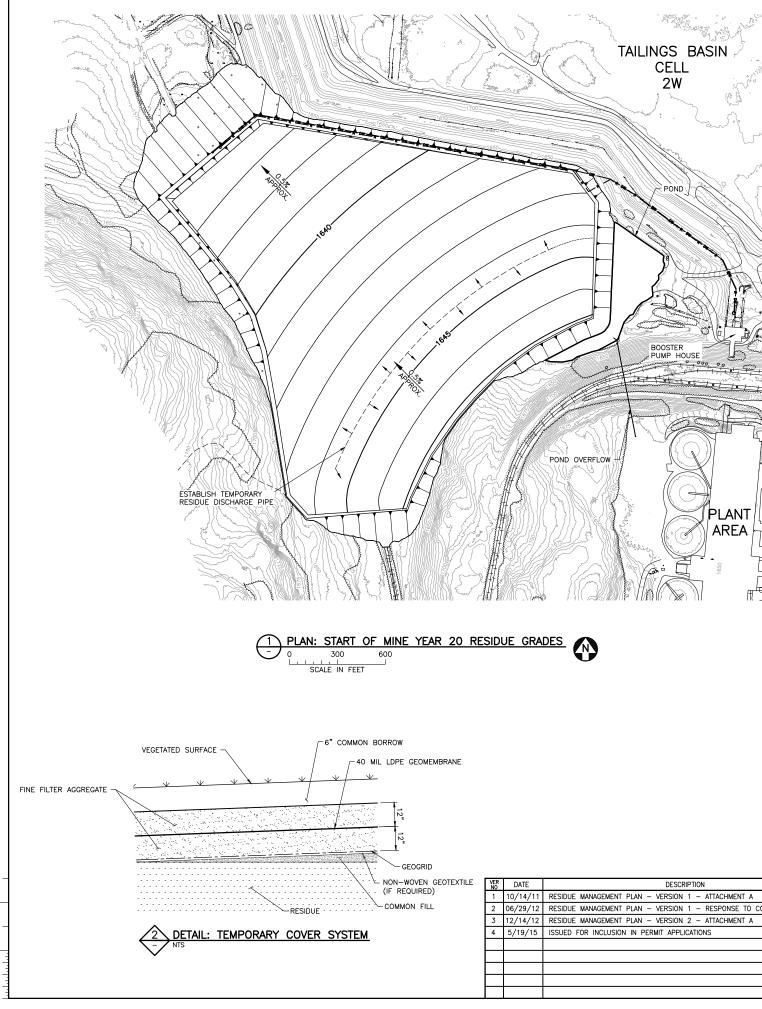

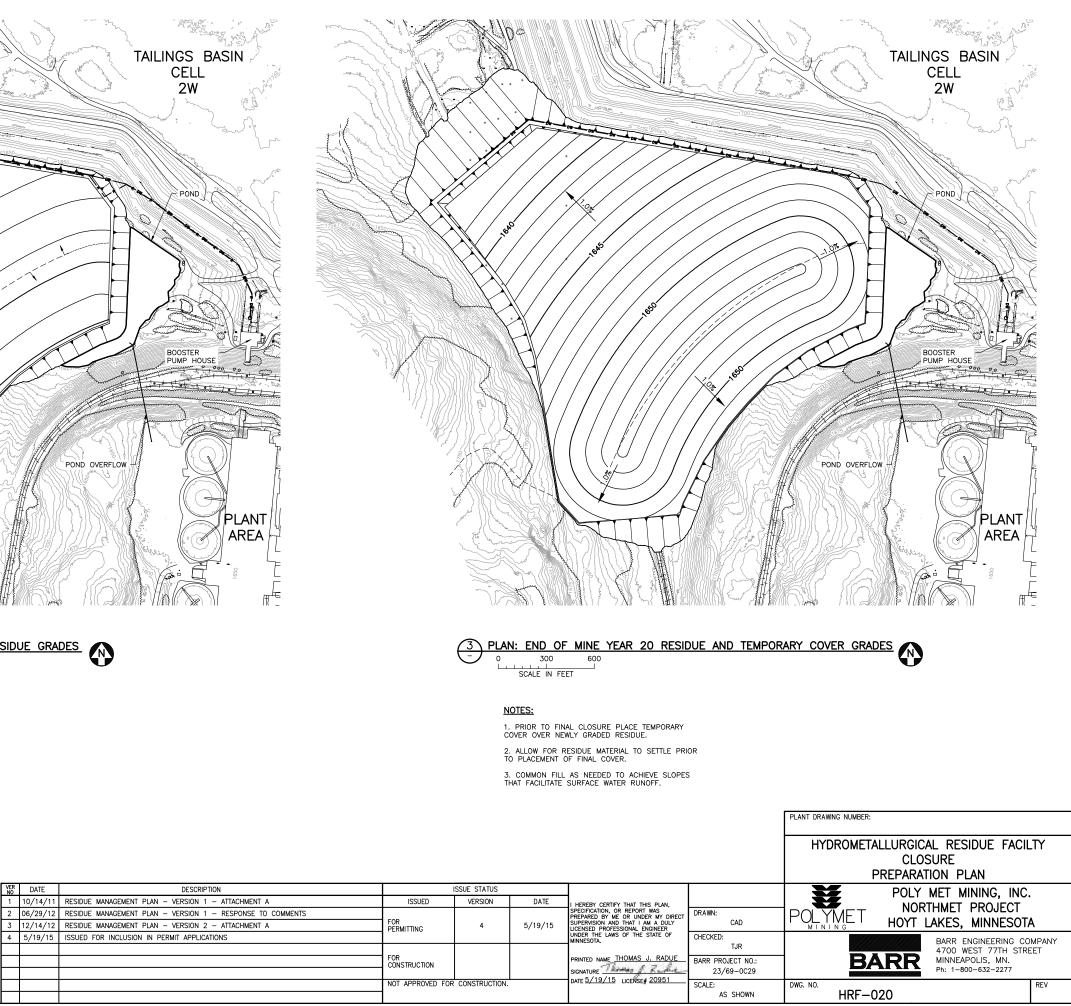

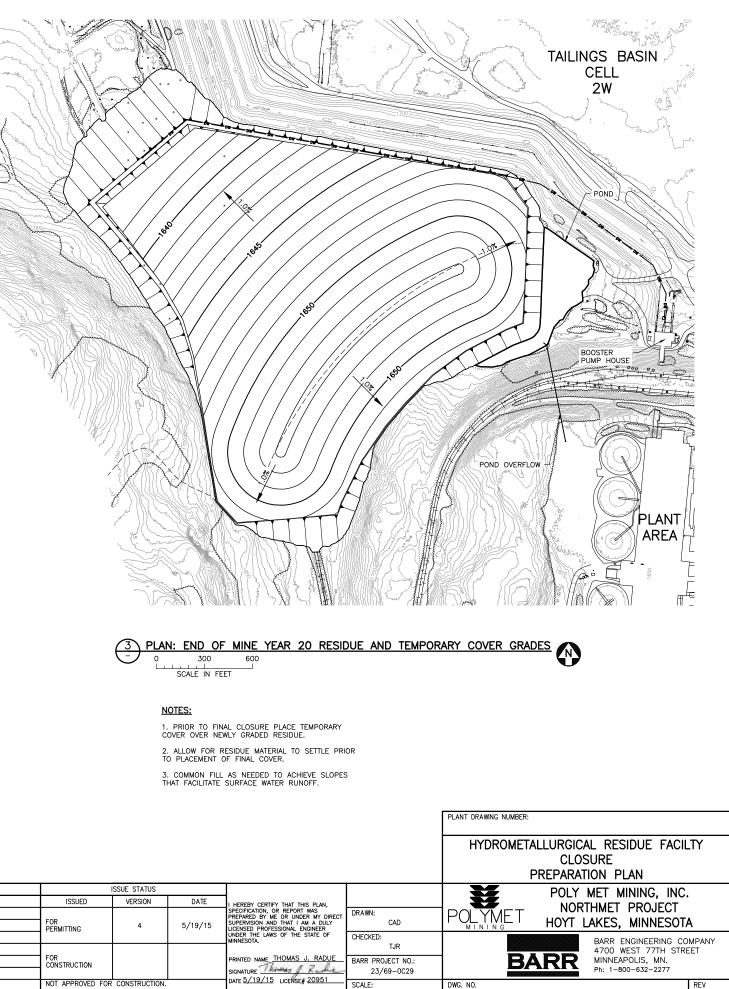NCHES

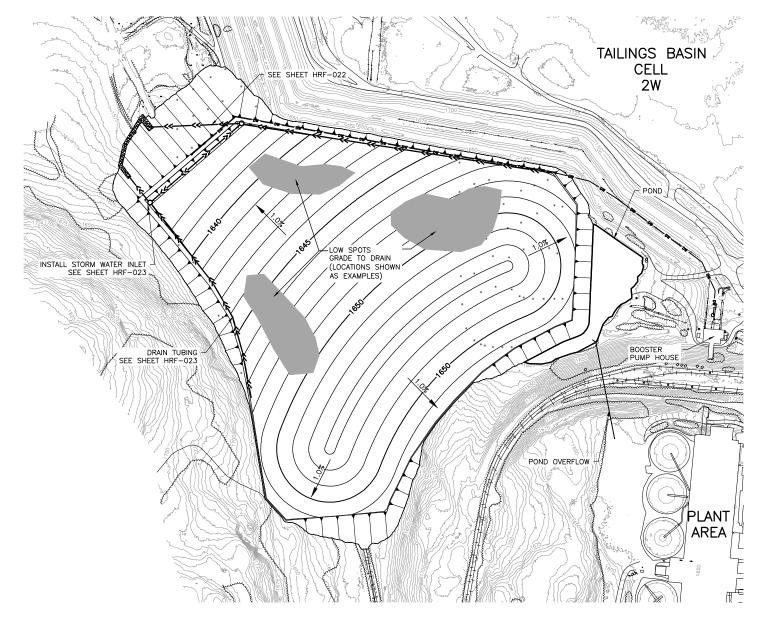


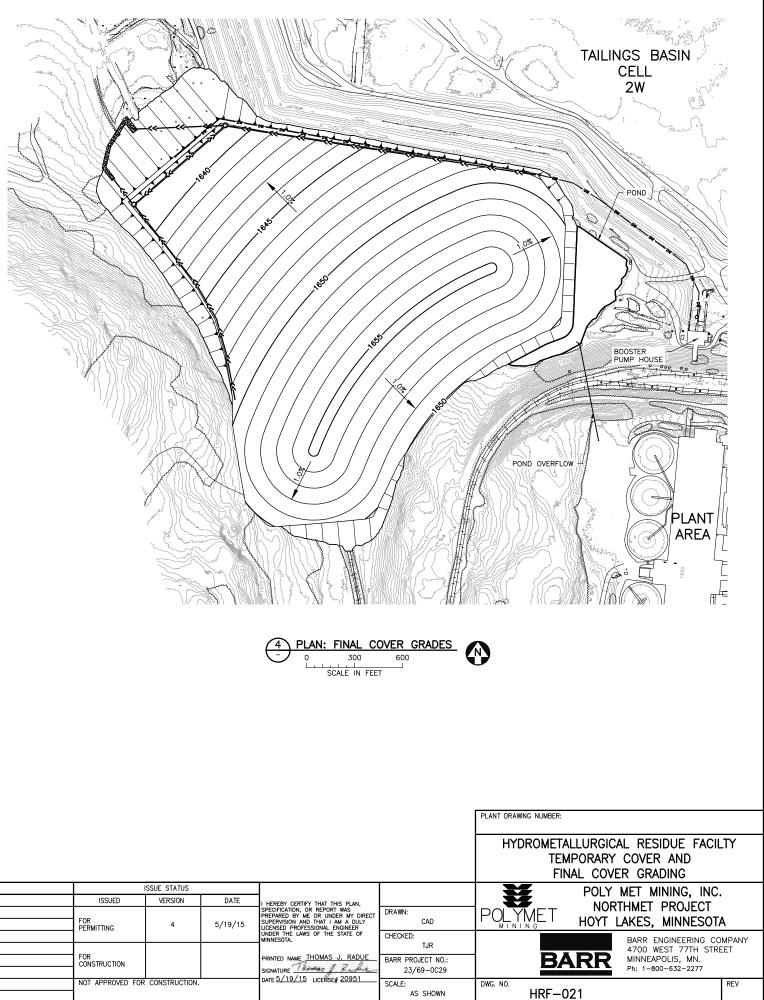




NOTES: 1. PRIOR TO FINAL CLOSURE GRADE ANY LOW SPOTS CREATED DURING SETTLEMENT ALLOTMENT TIME. 2. INSTALL DRAIN TUBING AND SURFACE WATER INLETS.


VER NO	DATE	DESCRIPTION	l	SSUE STATUS		
1	10/14/11	RESIDUE MANAGEMENT PLAN - VERSION 1 - ATTACHMENT A	ISSUED	VERSION	DATE	I HEREBY CERTIFY THAT THIS PLAN
2	06/29/12	RESIDUE MANAGEMENT PLAN - VERSION 1 - RESPONSE TO COMMENTS				SPECIFICATION, OR REPORT WAS PREPARED BY ME OR UNDER MY D
3	12/14/12	RESIDUE MANAGEMENT PLAN - VERSION 2 - ATTACHMENT A	FOR PERMITTING	4	5/19/15	SUPERVISION AND THAT I AM A DU LICENSED PROFESSIONAL ENGINEER
4	5/19/15	ISSUED FOR INCLUSION IN PERMIT APPLICATIONS				UNDER THE LAWS OF THE STATE C MINNESOTA.
			FOR CONSTRUCTION			PRINTED NAME THOMAS J. RAD
						SIGNATURE
			NOT APPROVED FOR	CONSTRUCTION.		DATE 5/ 19/ 15 LICENSE# 2095

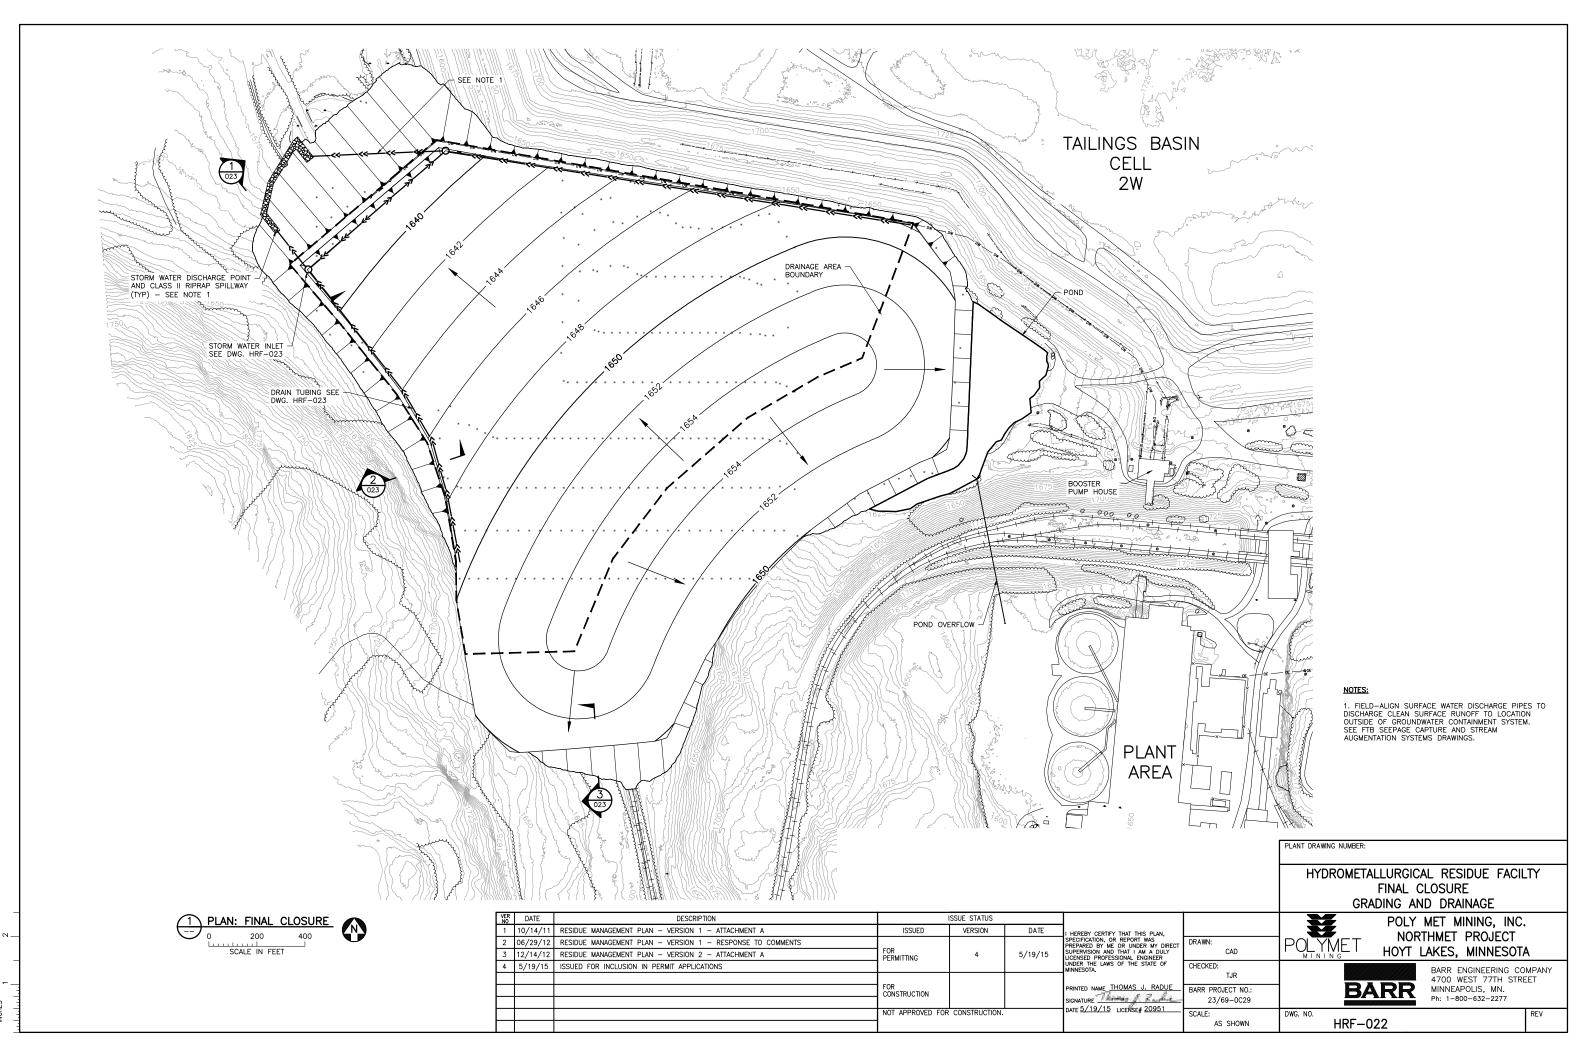

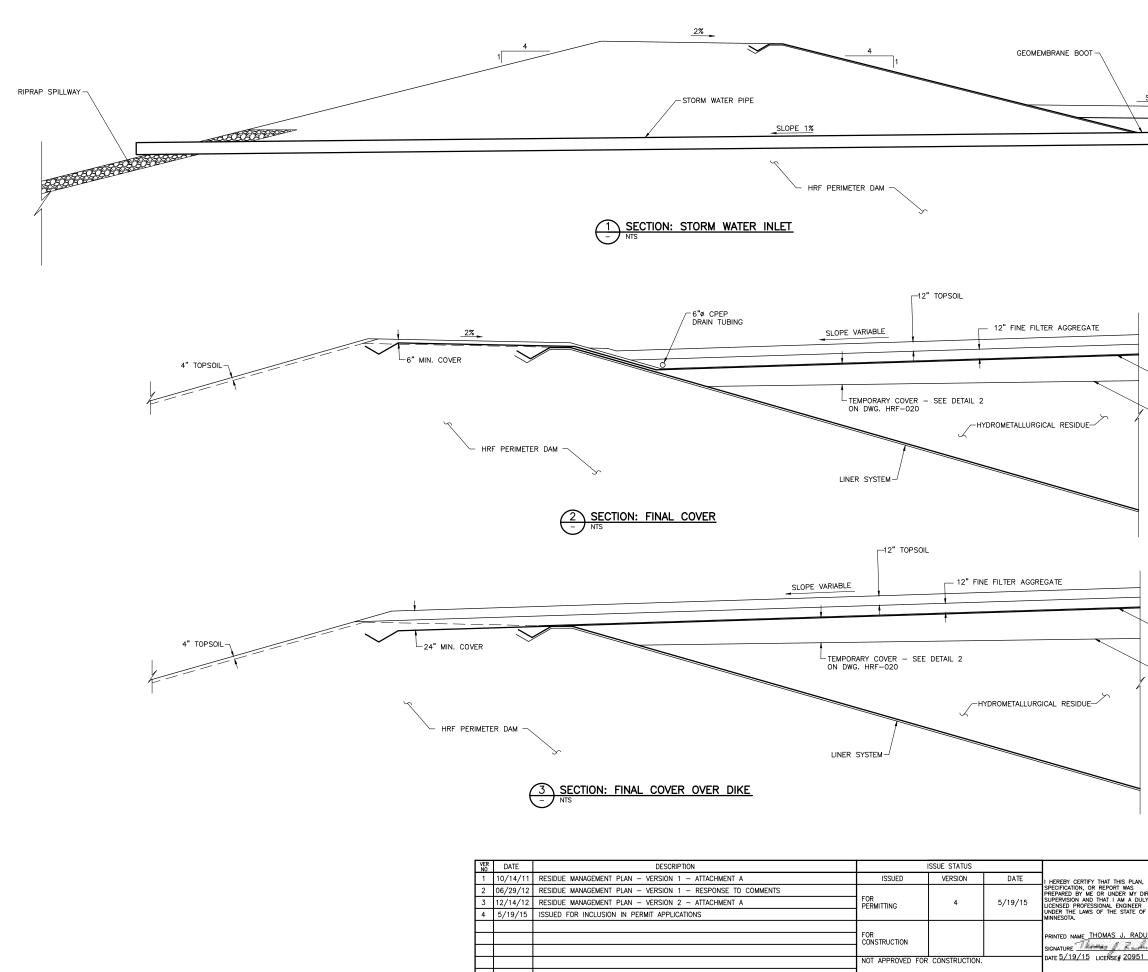

CATCH BASIN	/ TOP OF TEMPORARY COVER
	/ /6"¢ CPEP DRAIN TUBING
$\backslash$	
SLOPE	SLOPE 1%
	RESIDUE /
	LINER SYSTEM
	NOTES:
	NOTES.
	1. TEMPORARY COVER MATERIALS NOT SHOWN ON THS
	DRAWING. SEE DETAIL 3 ON DWG. HRF-020.
_	
-	
4	
40 MIL LDPE GEOMEMBRA	NE OVER
HYDRAULIC BARRIER COV	ER SYSTEM
NON-WOVEN GEOTEXTILE	(IF REQUIRED)
1	
-	
-	
1	
40 MIL LDPE GEOMEMBR	NE OVER
GCL OR APPROVED ALTE	
HYDRAULIC BARRIER COV	LR STSIEM
NON-WOVEN GEOTEXTILE	(IF REQUIRED)
Y	
<b>´</b>	
-	
	PLANT DRAWING NUMBER:
	HYDROMETALLURGICAL RESIDUE FACILTY
	CLOSURE
	SECTIONS AND DETAILS
	POLY MET MINING, INC.
AN,	NORTHMET PROJECT
DIRECT DRAWN:	
DULY CAD ER CHECKED:	TULTIVIE I HOYT LAKES, MINNESOTA
	BARR ENGINEERING COMPANY
TJR	4700 WEST 77TH STREET
ADUE BARR PROJECT NO.:	BARR MINNEAPOLIS, MN.
23/69-0C29	Ph: 1-800-632-2277
SCALE:	DWG. NO.
AS SHOWN	HRF-023
•	

TOP OF FINAL COVER

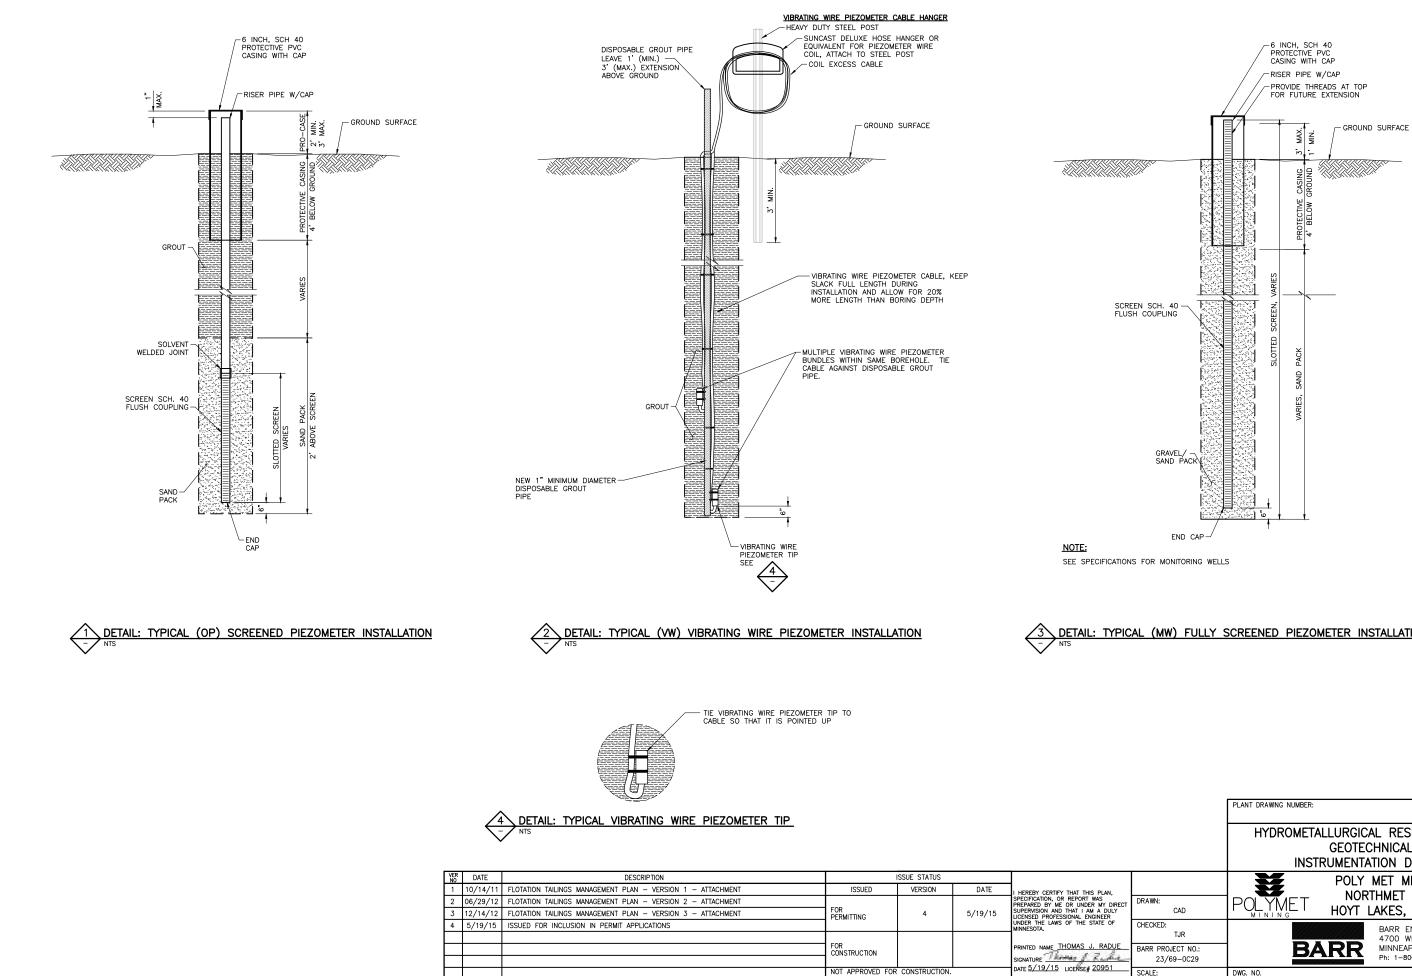

Ν-

CATIONS FOR MONITORING WEL	LS
YPICAL (MW) FULLY	SCREENED PIEZOMETER INSTALLATION
	PLANT DRAWING NUMBER:
	HYDROMETALLURGICAL RESIDUE FACILTY
	GEOTECHNICAL
	INSTRUMENTATION DETAILS
ı,	POLY MET MINING, INC.
DIRECT DRAWN: JLY CAD	POLYMET HOYT LAKES, MINNESOTA
CHECKED:	BARR ENGINEERING COMPANY 4700 WEST 77TH STREET
DUE BARR PROJECT NO.: 23/69-0C29	BARR MINNEAPOLIS, MN. Ph: 1-800-632-2277
237 09-0029 1SCALE:	DWG. NO.
AS SHOWN	HRF-024