Appendix 6 Flotation Tailings Basin and FTB Seepage Containment and Stream Augmentation Systems Permit Application Support Drawings

Errata Sheet

Poly Met Mining, Inc. NorthMet Project

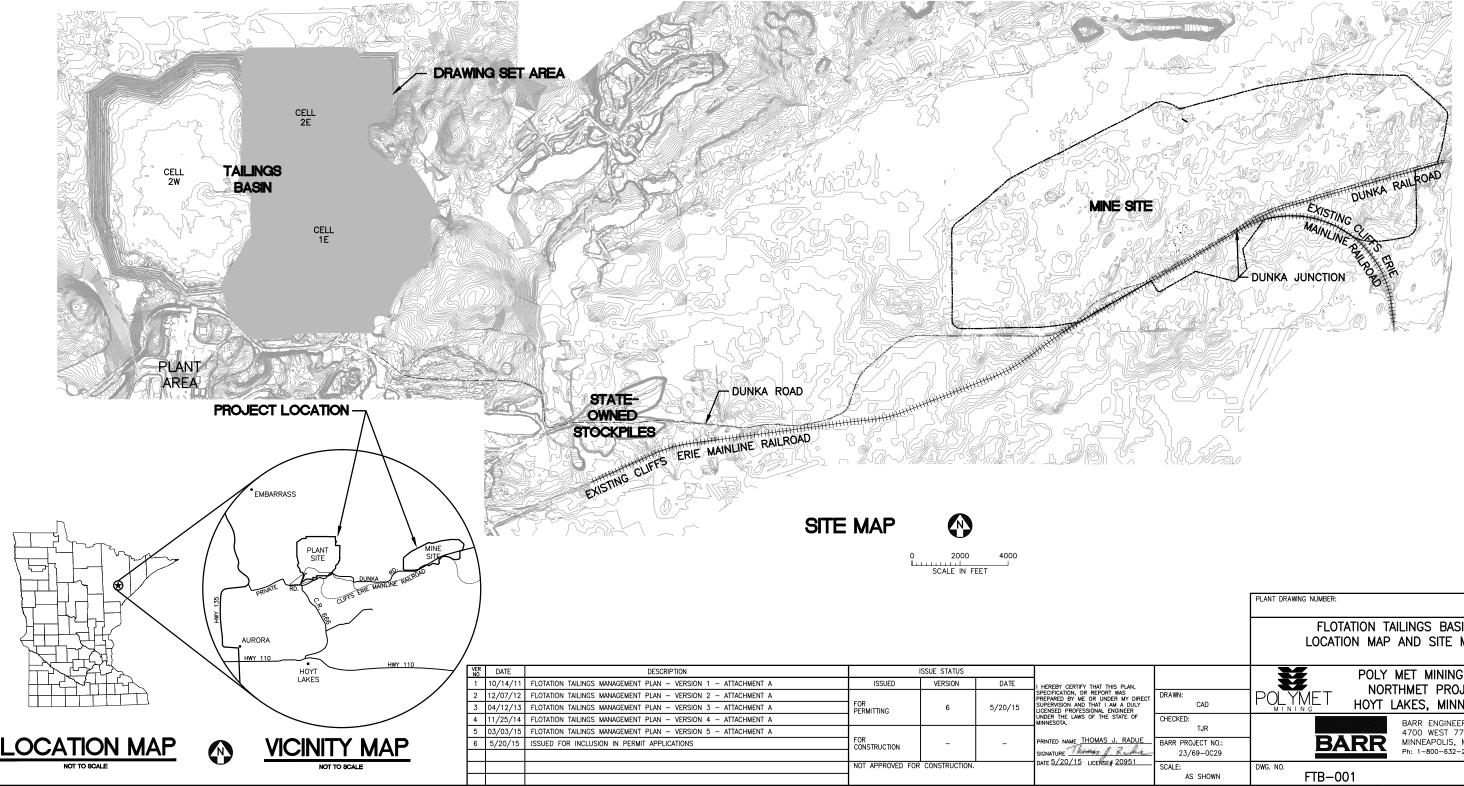
Permit Application Support Drawings: FTB Seepage Containment and Stream Augmentation Systems

July 2016 (version 2)

Engineering design is currently in progress. The table below lists changes that have been identified todate and have not yet been incorporated in the attached permit application support drawings within this set. Final design will incorporate these changes along with additional site-specific information (e.g., supplementary geotechnical data); therefore, additional adjustments may be made during final design that will be incorporated into the final design drawing set.

Drawing Sheet(s)	Change
FTBCA-002	A note 5 will be added to say: The term "stream augmentation" in this drawing set is synonymous with "surface water discharge"; these terms are used in the Water Appropriations Consolidated Permit Application and the NPDES/SDS Permit Application, respectively.
FTBCA-013, FTBCA-015	The cross slope on the perimeter access road surface will be revised so that it slopes entirely towards the FTB, instead of being crowned in the center.
FTBCA-013, FTBCA-015	To eliminate additional fill in wetlands, the monitoring wells located outside of the perimeter access road will be moved to within the road embankment.
FTBCA-004 through FTBCA-010	The final location and number of discharge locations to Unnamed Creek and Trimble Creek will be determined in permitting and final design.

POLY MET MINING, INC. NORTHMET PROJECT PERMIT SUPPORT DRAWINGS FLOTATION TAILINGS BASIN HOYT LAKES, MINNESOTA



		PLANT DRAWING NUMBER:	
		FLOTATION TAILINGS BASIN LOCATION MAP AND SITE MAP	
AN, ' DIRECT DULY ER OF	DRAWN: CAD	POLY MET MINING, IN NORTHMET PROJECT HOYT LAKES, MINNESC	
ADUE	CHECKED: TJR BARR PROJECT NO.: 23/69-0C29	BARR ENGINEERING 4700 WEST 77TH S MINNEAPOLIS, MN. Ph: 1-800-632-2277	
51	SCALE: AS SHOWN	DWG. NO. FTB-001	REV

GENERAL LEGEND

1000	EXISTING CONTOUR - MAJOR
	EXISTING CONTOUR - MINOR
1000	PROPOSED CONTOUR - MAJOR
	PROPOSED CONTOUR - MINOR
8	EXISTING POWER POLE
	EXISTING RAILROAD
	EXISTING ROAD
	EXISTING TRAIL
=======	EXISTING UNIMPROVED TRAIL
	EXISTING STRUCTURES
\sim	TREE LINE
<u></u>	WETLAND BOUNDARY
\rightarrow	EXISTING CULVERT
P	EXISTING PIPELINE
OE	OVERHEAD ELECTRIC
t	DISCHARGE POINT
ŧ	DEWATERING OUTLET POINT
8	RETURN PUMP PAD
	DEWATERING PUMP
>	SURFACE DRAINAGE
	DRAINAGE COLLECTION STRUCTURE
The second secon	AND PIPE
	DRAINAGE AREA BOUNDARY
	PROPOSED DAMS
DW	PROPOSED DEWATERING PIPE
D	PROPOSED DISCHARGE PIPELINE
—— R ——	PROPOSED RETURN PIPELINE
$\rightarrow \rightarrow \rightarrow$	PROPOSED CULVERT (NON-MINE DRAINAGE)
<	PROPOSED SEEPAGE COLLECTION DRAIN
<	PROPOSED STORMWATER DRAIN
0	PROPOSED MANHOLE
	PROPOSED WICK DRAIN LATERAL PIPE
	PROPOSED RIP RAP
	FILL SLOPE
>	CUT SLOPE

APPROX. – APPROXIMATE CDSM - CEMENT DEEP SOIL MIX CMP – CORRUGATED METAL PIPE CPEP – CORRUGATED POLYETHYLENE PIPE CY – CUBIC YARD DR - DIMENSION RATIO DWG – DRAWING EL. - ELEVATION F DIAMETER - FLOTATION TAILINGS BASIN FTB GCL

ABBREVIATIONS

GCL	-	GEOSYNTHETIC CLAY LINER
HDPE	-	HIGH DENSITY POLYETHYLENE
HRF	-	HYDROMETALLURGICAL RESIDUE FACILITY
LDPE	-	LOW DENSITY POLYETHYLENE
LF	-	LINER FEET
LTVSMC	-	LTV STEEL MINING COMPANY
MCY	-	MILLION CUBIC YARDS
mil	-	one thousandth of an inch
MIN	-	MINIMUM
MSL	-	MEAN SEA LEVEL

MSL NTS - NOT TO SCALE SCH. – SCHEDULE

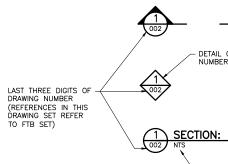
- DR - DIMENSION RATIO
- TYP. TYPICAL

SHEET INDEX

SHEET NO. TITLE

GENERAL DRAWINGS

DRAWING NUMBERING



NOTES

- 1. COORDINATE SYSTEM IS MINNESOTA STATE PLANE NORTH ZONE, NAD83.
- 2. ELEVATIONS ARE MEAN SEA LEVEL (MSL), NAVD88.
- 3. EXISTING TOPOGRAPHIC INFORMATION SHOWN ON THE DRAWINGS WAS PREPARED BY AEROMETRIC, INC. FROM LIDAR DATA COLLECTED ON MARCH 17, 2010.

4. EXISTING TOPOGRAPHIC INFORMATION WAS UPDATED FOR AREAS SOUTH EAST OF COAL ASH LANDFILL AND EAST OF OUTCROP BETWEEN CELLS 1E AND 2E USING CONTOURS FROM DATA COLLECTED IN 1999.

5. FLOATATION TAILINGS BASIN DESIGN WAS BASED ON CONTOURS FROM DATA COLLECTED IN 1999. PROPOSED DAM LAYOUTS MAY NOT EXACTLY MATCH THE EXISTING TOPOGRAPHY FROM 2010 LIDAR.

1.000			1			
VE	DATE	DESCRIPTION		ISSUE STATUS		
1	10/14/11	FLOTATION TAILINGS MANAGEMENT PLAN - VERSION 1 - ATTACHMENT A	ISSUED	VERSION	DATE	I HEREBY CERTIFY THAT THIS PLAN.
2	12/07/12	FLOTATION TAILINGS MANAGEMENT PLAN - VERSION 2 - ATTACHMENT A				SPECIFICATION, OR REPORT WAS PREPARED BY ME OR UNDER MY DIRE
3	04/12/13	FLOTATION TAILINGS MANAGEMENT PLAN - VERSION 3 - ATTACHMENT A	FOR PERMITTING	6		SUPERVISION AND THAT I AM A DULY LICENSED PROFESSIONAL ENGINEER
4	11/25/14	FLOTATION TAILINGS MANAGEMENT PLAN - VERSION 4 - ATTACHMENT A				UNDER THE LAWS OF THE STATE OF MINNESOTA.
5	03/03/15	FLOTATION TAILINGS MANAGEMENT PLAN - VERSION 5 - ATTACHMENT A				1
6	5/20/15	ISSUED FOR INCLUSION IN PERMIT APPLICATIONS	FOR CONSTRUCTION	-		PRINTED NAME THOMAS J. RADUE
						SIGNATURE
			NOT APPROVED FOR	CONSTRUCTION		DATE <u>5/20/15</u> LICENSE# <u>20951</u>


M

		PLANT DRAWING NUMBER:				
		FLOTATION TAILINGS BASIN LEGEND AND SHEET INDEX				
N, DIRECT DULY R OF	DRAWN: CAD	POLY MET MINING, INC. POLYMET HOYT LAKES, MINNESOTA				
OF ADUE 51	CHECKED: TJR BARR PROJECT NO.: 23/69-0C29	BARR ENGINEERING CO 4700 WEST 77TH STRE MINNEAPOLIS, MN. Ph: 1-800-632-2277				
51	SCALE: AS SHOWN	DWG. NO. FTB-002	REV			

-NTS = NOT TO SCALE

- DETAIL OR SECTION NUMBER, TYPICAL

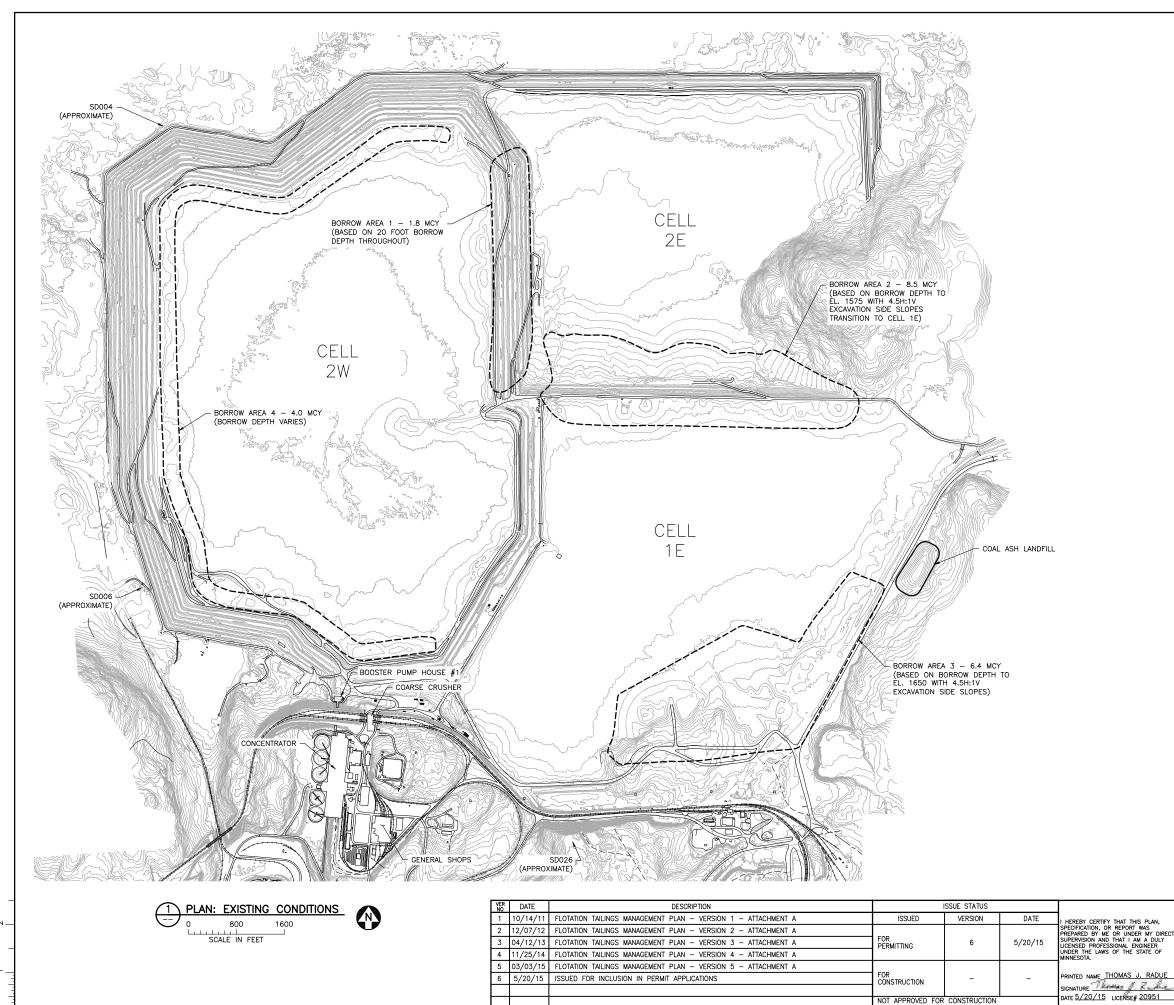ECTION ECTION EAR 20 LAYOUT CROSS SECTIONS AND DRAINAGE SWALE FOUT ECTION - LAYOUT - SECTIONS - DETAILS - SEQUENCING

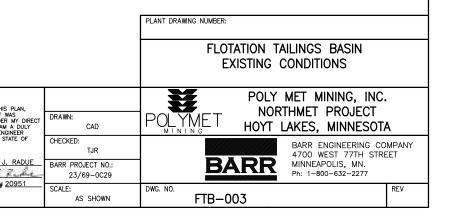


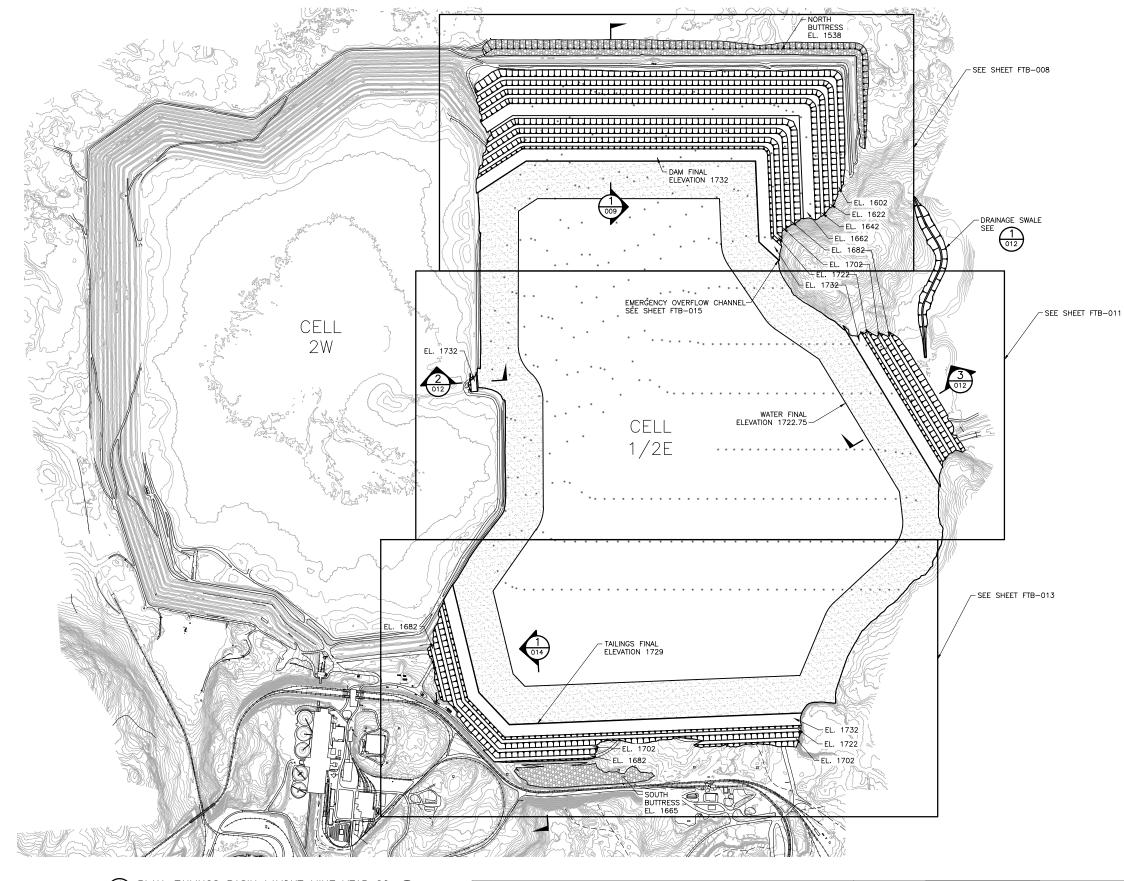
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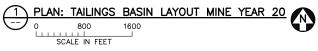
1. CONTOURS DO NOT REFLECT BORROW REMOVAL.

2. BORROW LTVSMC COARSE TAILINGS IN THE NUMERICAL SEQUENCE SHOWN.

3. COAL ASH LANDFILL TO BE RELOCATED TO HYDROMET RESIDUE FACILITY OR ALTERNATE PERMITTED FACILITY PRIOR TO TAILINGS DEPOSITION IN CELL 1E.








VCD	1		1			
VER NO	DATE	DESCRIPTION		ISSUE STATUS		
1	10/14/11	FLOTATION TAILINGS MANAGEMENT PLAN - VERSION 1 - ATTACHMENT A	ISSUED	VERSION	DATE	I HEREBY CERTIFY THAT THIS PLAN.
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5	03/03/15	FLOTATION TAILINGS MANAGEMENT PLAN - VERSION 5 - ATTACHMENT A				1
6	5/20/15	ISSUED FOR INCLUSION IN PERMIT APPLICATIONS	FOR CONSTRUCTION	-	-	PRINTED NAME THOMAS J. RADU
]			
			NOT APPROVED FOR	CONSTRUCTION		DATE 5/20/15 LICENSE# 20951


NCHES

		PLANT DRAWING NUMBER:	
		FLOTATION TAILINGS BASIN LAYOUT MINE YEAR 20	
AN, 7 DIRECT DULY ER	DRAWN: CAD	POLY MET MINING, INC NORTHMET PROJECT HOYT LAKES, MINNESOT	
ADUE	CHECKED: TJR BARR PROJECT NO.: 23/69-0C29	BARR ENGINEERING C 4700 WEST 77TH STE MINNEAPOLIS, MN. Ph: 1-800-632-2277	
51	SCALE: AS SHOWN	DWG. NO. FTB-004	REV

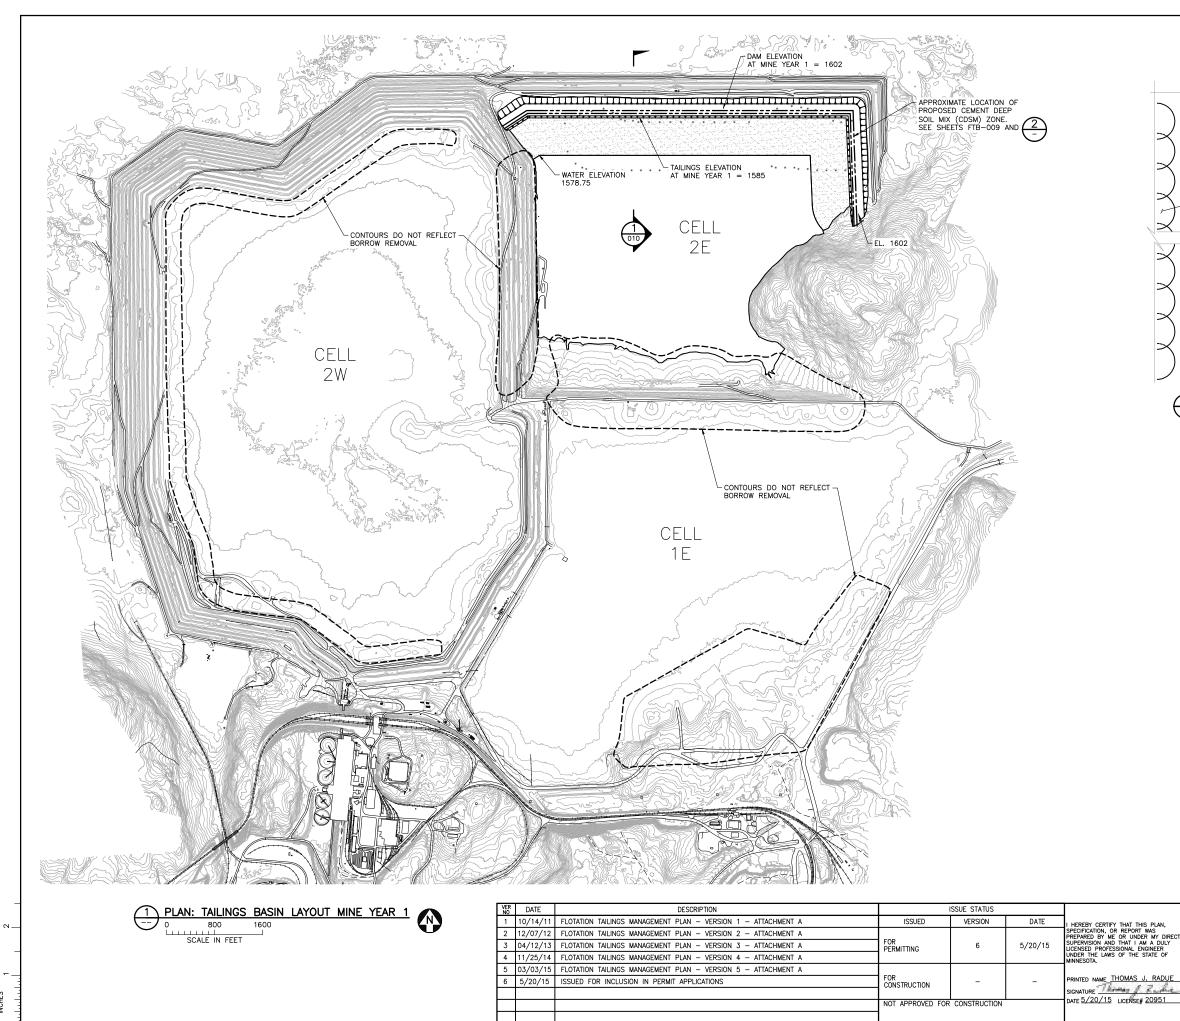- 2. LOCATION AND DIMENSIONS OF CDSM SHEAR WALL MAY CHANGE AS DESIGNS ARE FINALIZED.
- 1. CEMENT DEEP SOIL MIX (CDSM) ZONE NOT SHOWN. SEE SHEETS FTB-003 AND FTB-009.
- NOTE:




NCHES

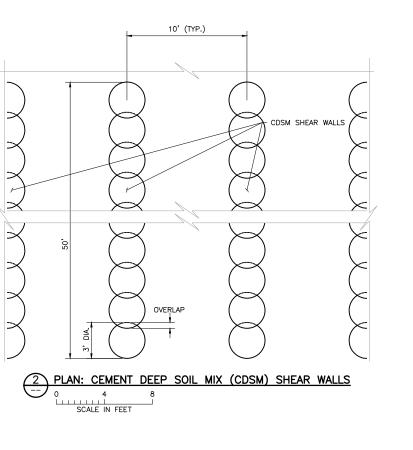


NOTES:

1. SEE SHEET FTB-015 FOR OPERATIONS-PHASE EMERGENCY OVERFLOW CHANNEL.

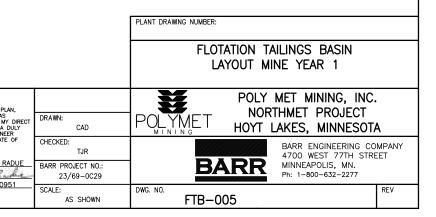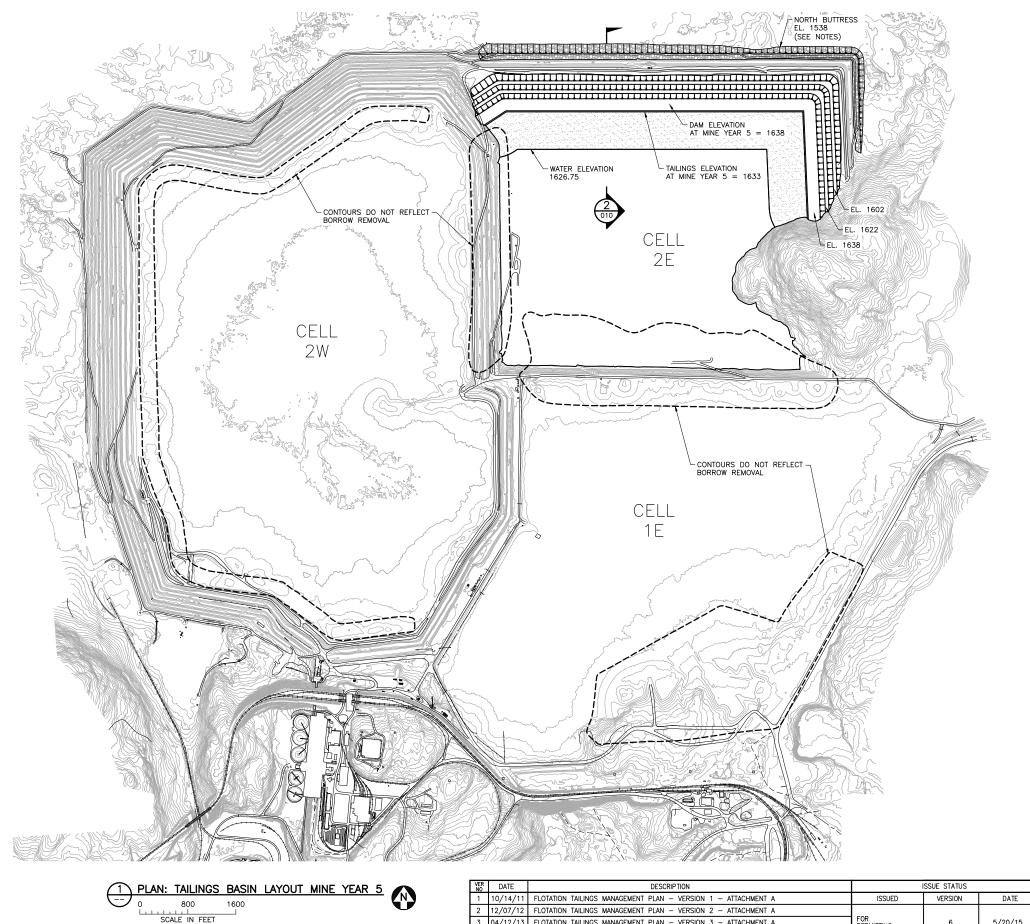
2. CDSM TO BE CONSTRUCTED PRIOR TO TAILINGS PLACEMENT.






INCHES

I MINE YEAR 5 🍂 🚺	NO	DATE	DESCRIPTION	I	ISSUE STATUS		
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U	2	12/07/12	FLOTATION TAILINGS MANAGEMENT PLAN - VERSION 2 - ATTACHMENT A				SPECIFICATION, OR REPORT WAS PREPARED BY ME OR UNDER MY DI
	3	04/12/13	FLOTATION TAILINGS MANAGEMENT PLAN - VERSION 3 - ATTACHMENT A	FOR PERMITTING	6	5/20/15	SUPERVISION AND THAT I AM A DUL LICENSED PROFESSIONAL ENGINEER
	4	11/25/14	FLOTATION TAILINGS MANAGEMENT PLAN - VERSION 4 - ATTACHMENT A	-			UNDER THE LAWS OF THE STATE OF MINNESOTA.
	5	03/03/15	FLOTATION TAILINGS MANAGEMENT PLAN - VERSION 5 - ATTACHMENT A				
	6	5/20/15	ISSUED FOR INCLUSION IN PERMIT APPLICATIONS	FOR CONSTRUCTION	-		PRINTED NAME THOMAS J. RADU
							SIGNATURE
				NOT APPROVED FOR	CONSTRUCTION		DATE <u>5/20/15</u> LICENSE# 20951

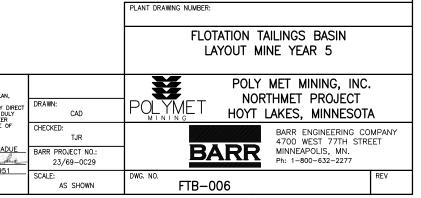


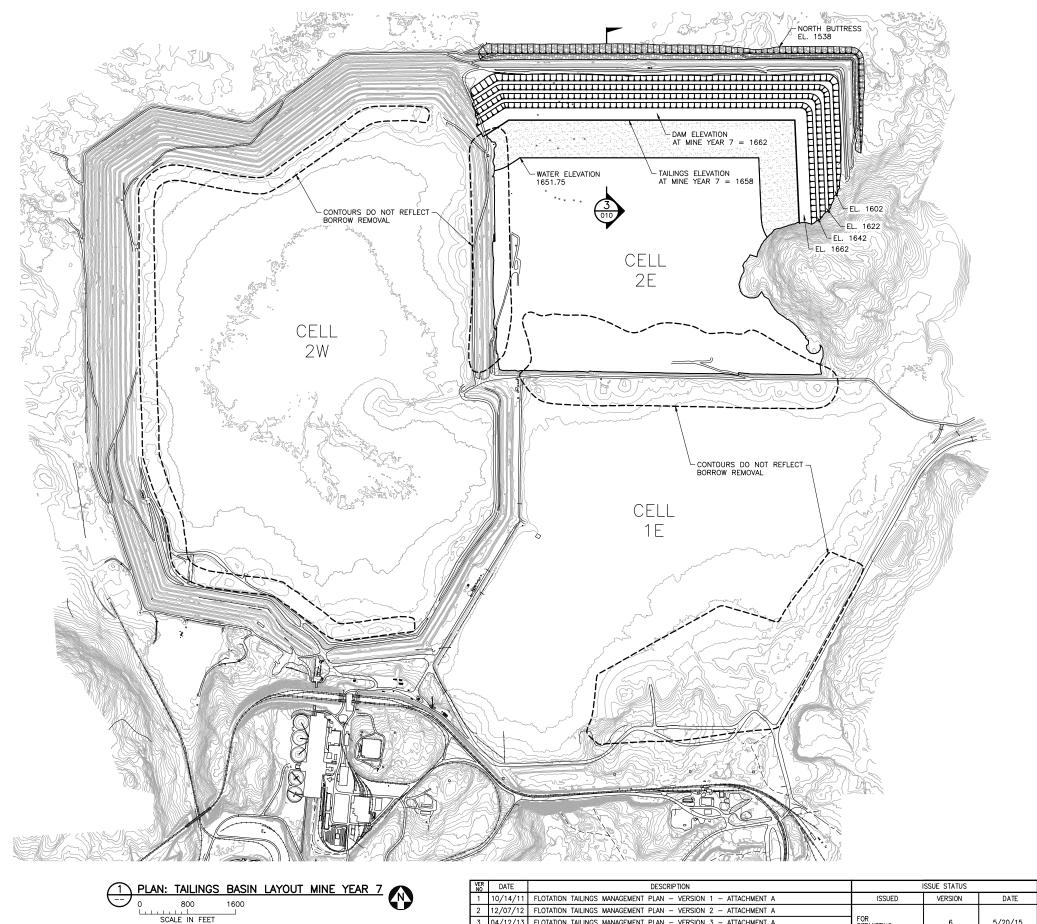NOTES: 1. SEE SHEET FTB-015 FOR OPERATIONS-PHASE EMERGENCY OVERFLOW CHANNEL. 2. CDSM ZONE NOT SHOWN. SEE SHEETS FTB-003 AND FTB-009.



INCHES


VER NO	DATE	DESCRIPTION	I	SSUE STATUS		
1	10/14/11	FLOTATION TAILINGS MANAGEMENT PLAN - VERSION 1 - ATTACHMENT A	ISSUED	VERSION	DATE	I HEREBY CERTIFY THAT THIS PLAN.
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						SIGNATURE
			NOT APPROVED FOR	CONSTRUCTION		DATE 5/20/15 LICENSE# 20951

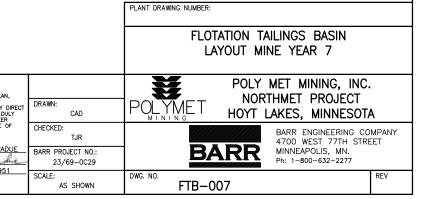

3. CDSM ZONE NOT SHOWN. SEE SHEETS FTB-003 AND FTB-009.

1. LAST YEAR BEFORE COMBINING CELLS 2E AND 1E FOR TAILINGS. 2. SEE SHEET FTB-015 FOR OPERATIONS-PHASE EMERGENCY OVERFLOW CHANNEL.

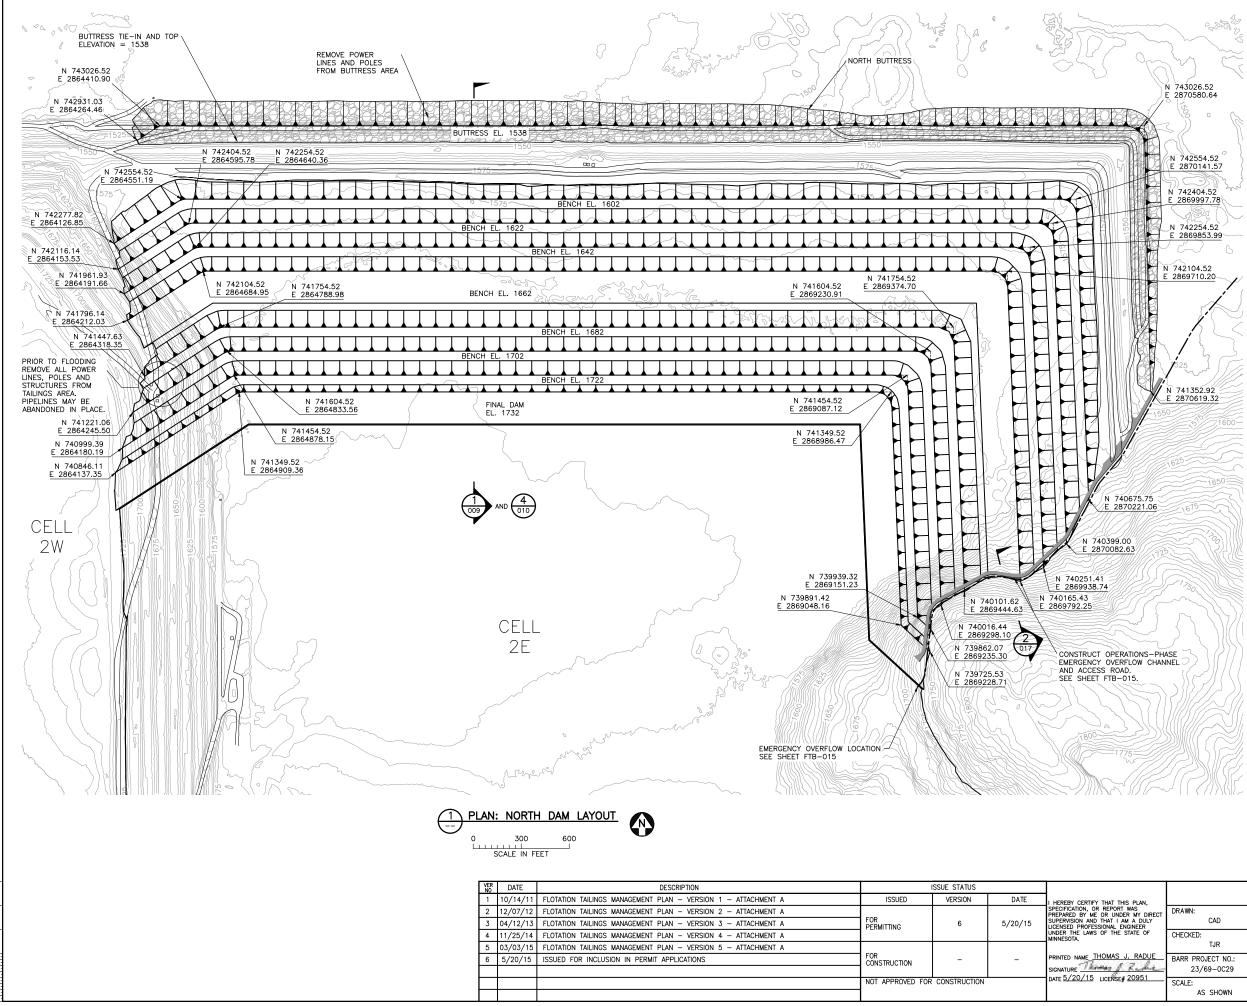NOTES:



NCHES


NOTES:

1. DAM ACCESS ROAD LOCATION IS APPROXIMATE. FIELD LOCATE TO PROVIDE PREFERRED SLOPE AND DRAINAGE.


2. EXTEND ACCESS ROAD TO AREA 5 STOCKPILES AND TO PLANT (NOT SHOWN).


3. CDSM ZONE NOT SHOWN. SEE SHEETS FTB-003 AND FTB-009.


		PLANT DRAWING NUMBER:				
	FLOTATION TAILINGS BASIN NORTH DAM MINE YEAR 20 LAYOUT					
AN, 1 DIRECT DULY ER	DRAWN: CAD	POLY MET MINING, INC. NORTHMET PROJECT HOYT LAKES, MINNESOTA				
ADUE	CHECKED: TJR BARR PROJECT NO.: 23/69-0C29	BARR ENGINEERING COMI 4700 WEST 77TH STREE MINNEAPOLIS, MN. Ph: 1-800-632-2277				
51	SCALE: AS SHOWN	FTB-008	REV			

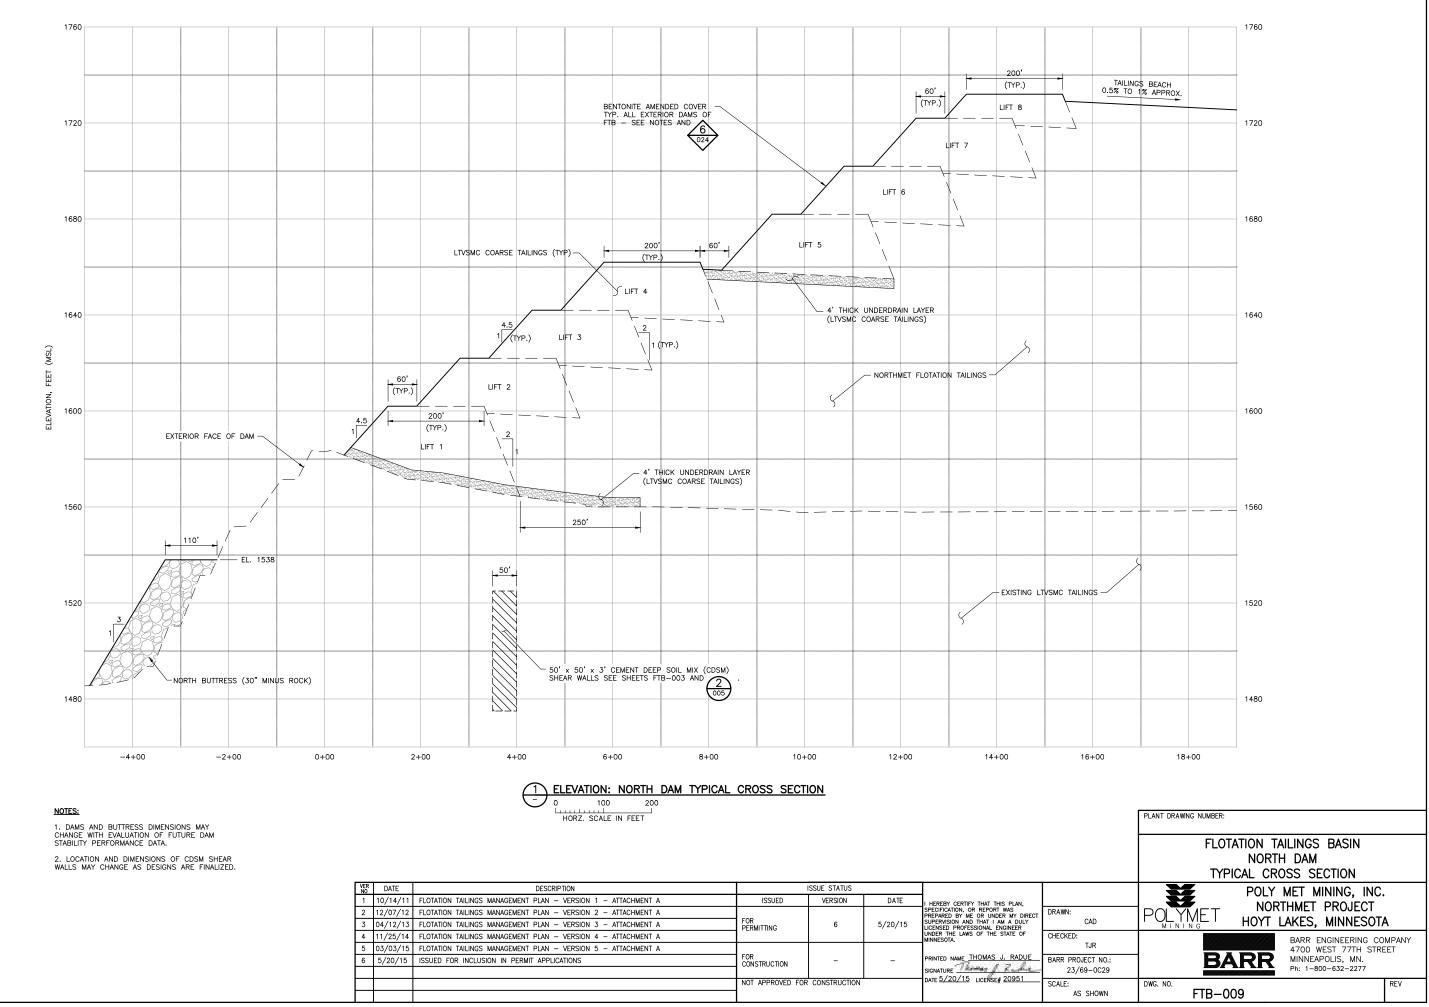

VER NO	DATE	DESCRIPTION		ISSUE STATUS			
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5	03/03/15	FLOTATION TAILINGS MANAGEMENT PLAN - VERSION 5 - ATTACHMENT A					
6	5/20/15	ISSUED FOR INCLUSION IN PERMIT APPLICATIONS	FOR CONSTRUCTION	-	_	PRINTED NAME THOMAS J. RADUE	
						SIGNATURE	
			NOT APPROVED FOR	CONSTRUCTION		DATE <u>5/20/15</u> LICENSE# <u>20951</u>	

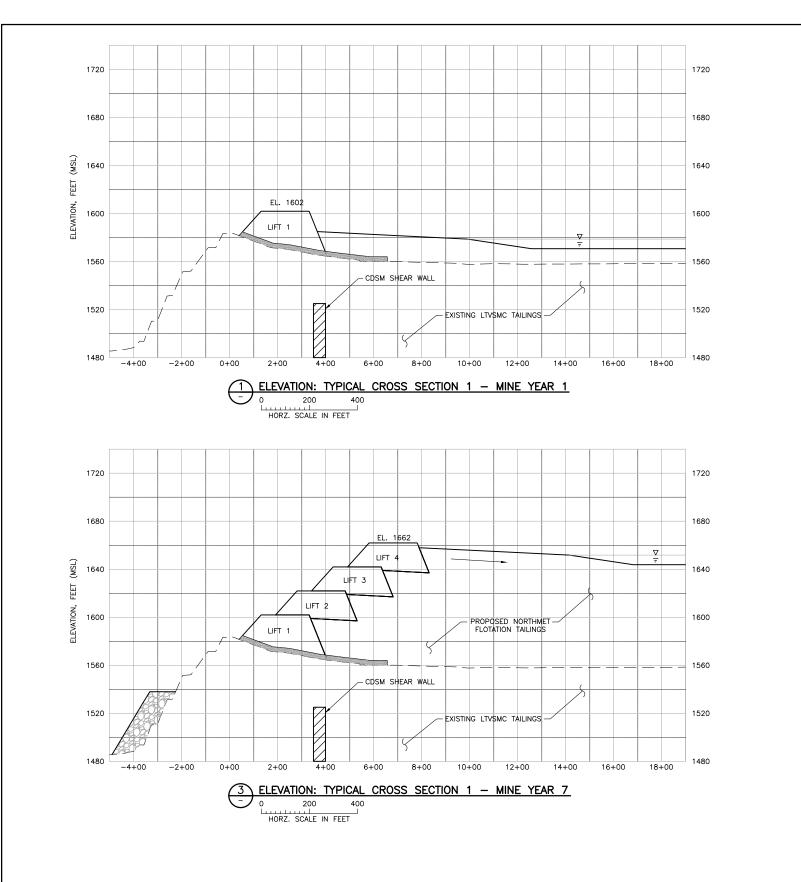

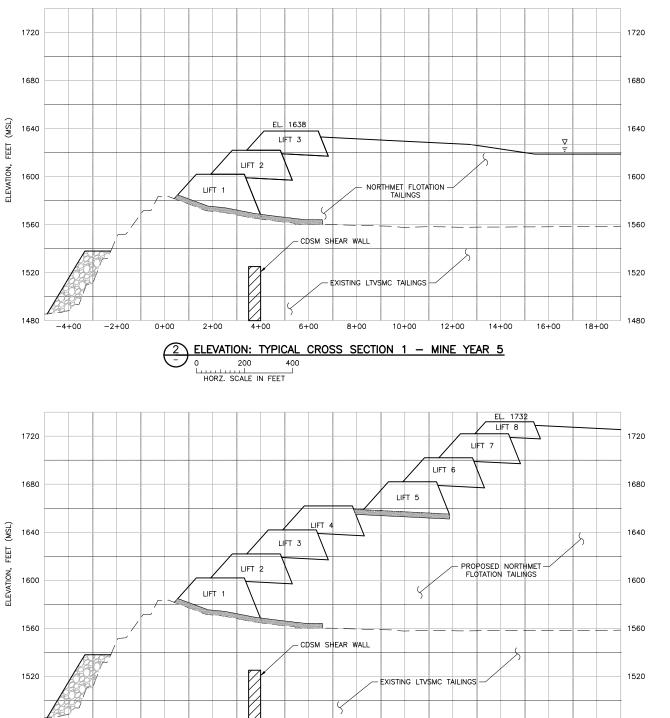

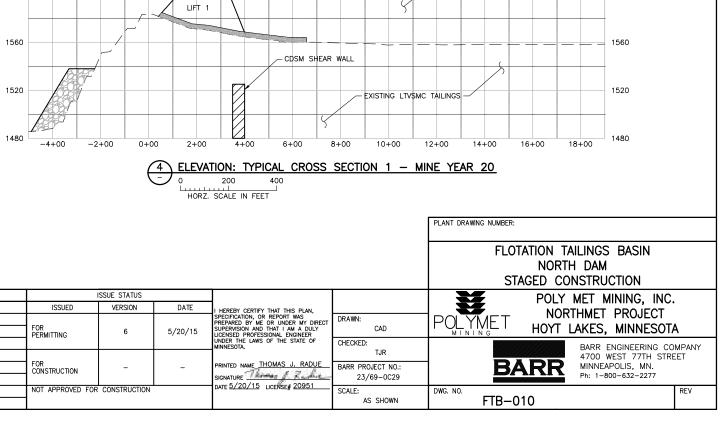


NOTE:


1. DAM AND BUTTRESS DIMENSIONS MAY CHANGE WITH EVALUATION OF FUTURE DAM STABILITY PERFORMANCE DATA.


2. PLACE BENTONITE AMENDED SOIL COVER ON OUTSIDE FACE OF NEW DAMS.


VER NO	DATE	DESCRIPTION		ISSUE STATUS		
1	10/14/11	FLOTATION TAILINGS MANAGEMENT PLAN - VERSION 1 - ATTACHMENT A	ISSUED	VERSION	DATE	I HEREBY CERTIFY THAT THIS PLAN.
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3	04/12/13	FLOTATION TAILINGS MANAGEMENT PLAN - VERSION 3 - ATTACHMENT A	FOR PERMITTING	6	5/20/15	SUPERVISION AND THAT I AM A DULY LICENSED PROFESSIONAL ENGINEER
4	11/25/14	FLOTATION TAILINGS MANAGEMENT PLAN - VERSION 4 - ATTACHMENT A				UNDER THE LAWS OF THE STATE OF MINNESOTA.
5	03/03/15	FLOTATION TAILINGS MANAGEMENT PLAN - VERSION 5 - ATTACHMENT A				
6	5/20/15	ISSUED FOR INCLUSION IN PERMIT APPLICATIONS	FOR CONSTRUCTION	-	-	PRINTED NAME THOMAS J. RADUE
						SIGNATURE
			NOT APPROVED FOR	CONSTRUCTION		DATE 5/20/15 LICENSE# 20951

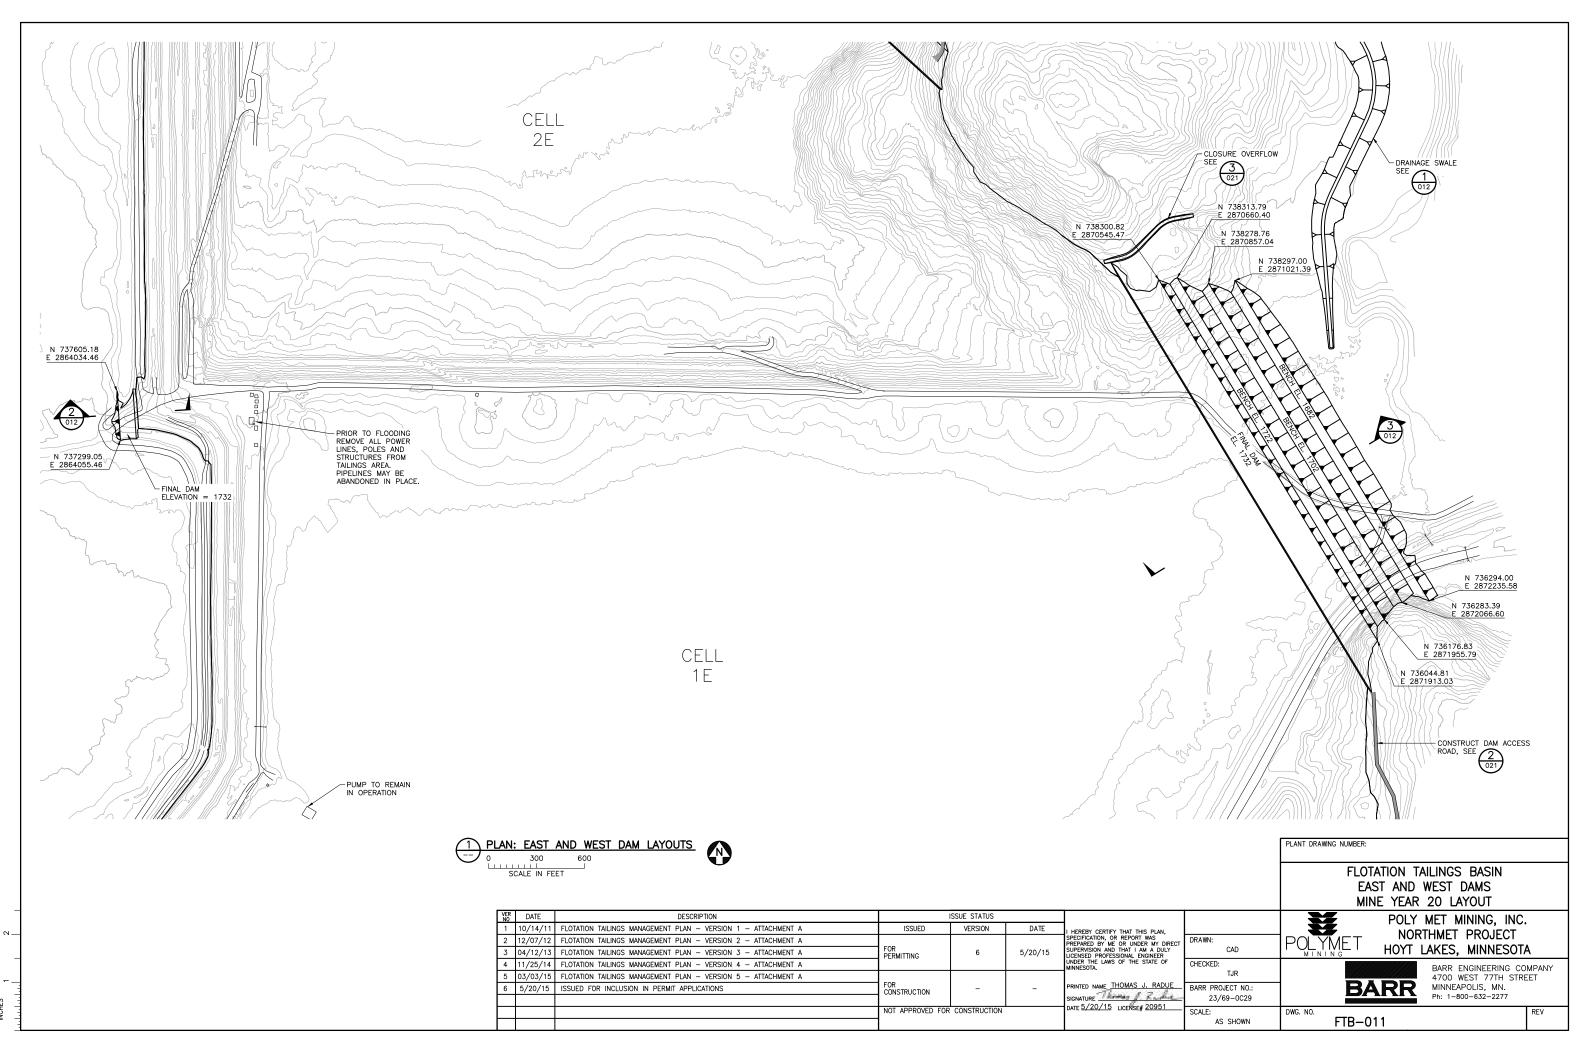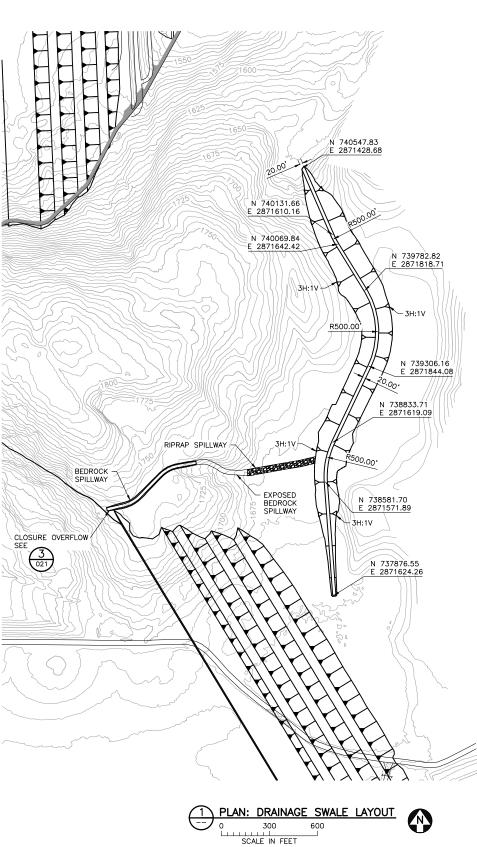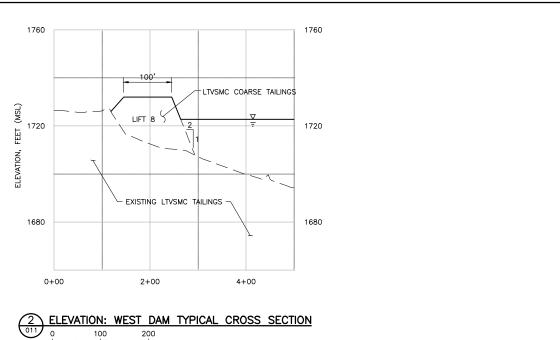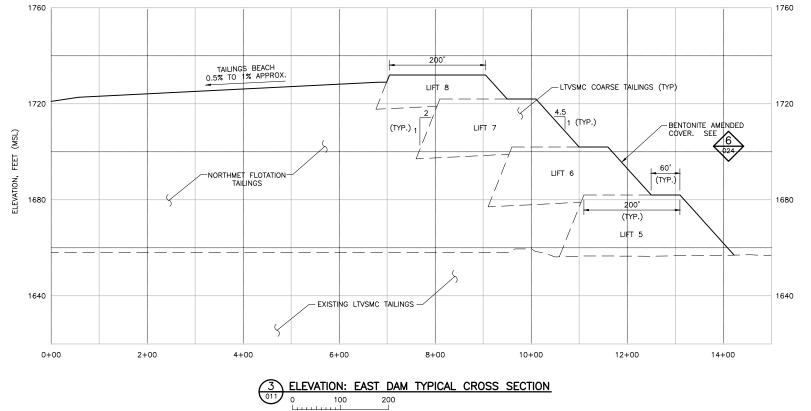INCHES










	18					CALE IN FEET				
								PLANT DRAWING NUMBER:		
								EAST AND WE	ION TAILINGS BASIN EST DAMS TYPICAL CRC AND DRAINAGE SWALE	
/ER NO	DATE	DESCRIPTION		ISSUE STATUS				×	POLY MET MINING, INC	
1	10/14/11	FLOTATION TAILINGS MANAGEMENT PLAN - VERSION 1 - ATTACHMENT A	ISSUED VERSION	VERSION	DATE	I HEREBY CERTIFY THAT THIS PLAN,			NORTHMET PROJECT	·•
2	12/07/12	FLOTATION TAILINGS MANAGEMENT PLAN - VERSION 2 - ATTACHMENT A				SPECIFICATION, OR REPORT WAS PREPARED BY ME OR UNDER MY DIRECT	DRAWN:	POLYMET ,		- .
3	04/12/13	FLOTATION TAILINGS MANAGEMENT PLAN - VERSION 3 - ATTACHMENT A	FOR PERMITTING	6	5/20/15	SUPERVISION AND THAT I AM A DULY LICENSED PROFESSIONAL ENGINEER	CAD		HOYT LAKES, MINNESOT	IA
ŀ	11/25/14	FLOTATION TAILINGS MANAGEMENT PLAN - VERSION 4 - ATTACHMENT A				UNDER THE LAWS OF THE STATE OF MINNESOTA.	CHECKED:		BARR ENGINEERING CO	
5	03/03/15	FLOTATION TAILINGS MANAGEMENT PLAN - VERSION 5 - ATTACHMENT A					TJR		4700 WEST 77TH STR	
6	5/20/15	ISSUED FOR INCLUSION IN PERMIT APPLICATIONS		-	-	PRINTED NAME THOMAS J. RADUE	BARR PROJECT NO.: 23/69-0C29		MINNEAPOLIS, MN. Ph: 1-800-632-2277	
				NOT APPROVED FOR CONSTRUCTION		DATE <u>5/20/15</u> LICENSE# <u>20951</u>	SCALE: AS SHOWN	DWG. NO. FTB-012		REV

HORZ. SCALE IN FEET

NOTES:


1.CLOSURE OVERFLOW IS FOR EMERGENCY OVERFLOW ONLY UNTIL POND WATER QUALITY MEETS DISCHARGE WATER QUALITY REQUIREMENTS.

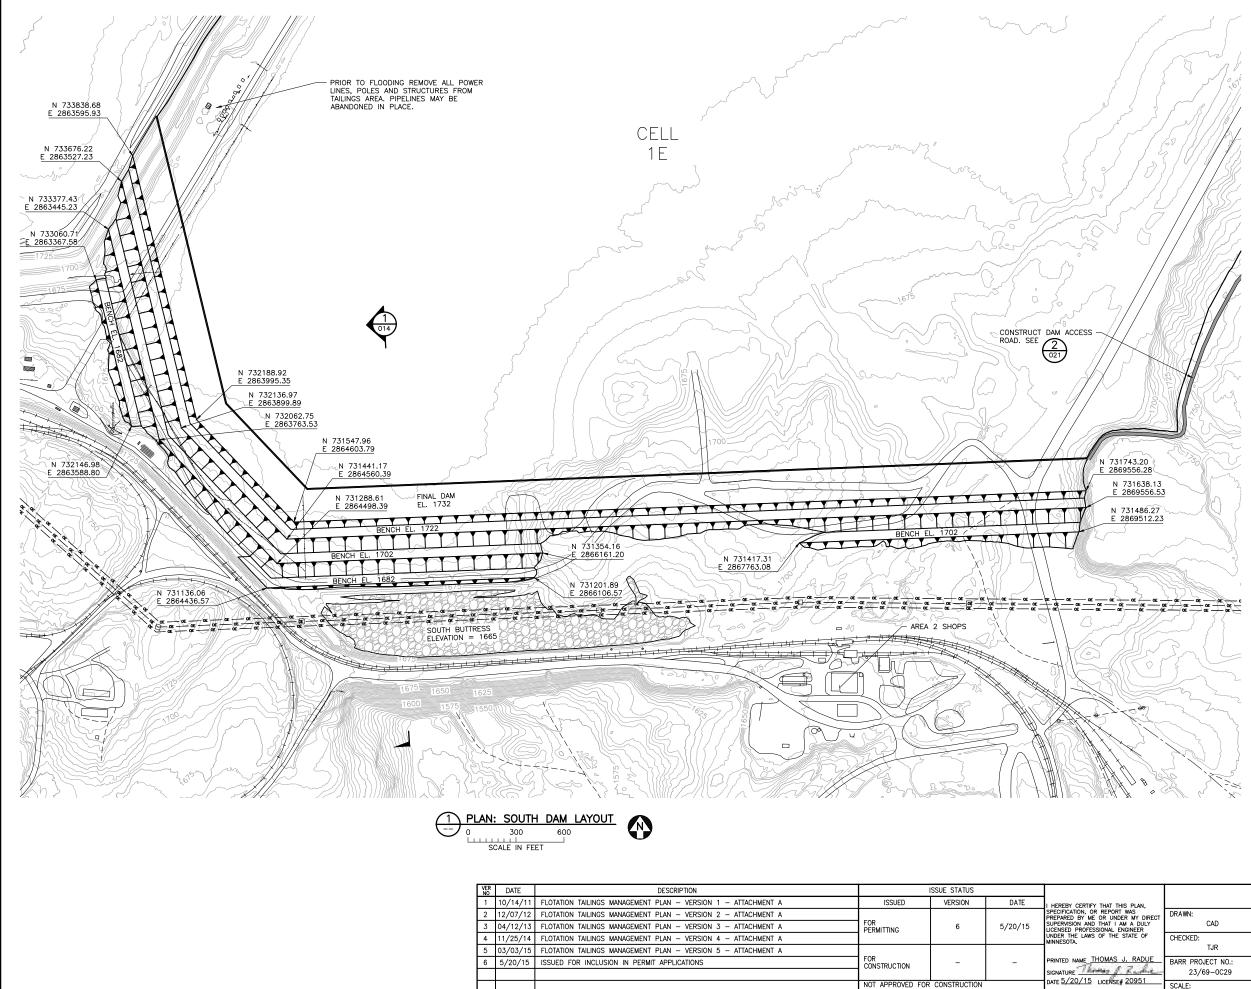2. DAM DIMENSIONS MAY CHANGE WITH EVALUATION OF FUTURE DAM STABILITY PERFORMANCE DATA.



NCHES

		PLANT DRAWING NUMBER:	
		FLOTATION TAILINGS BASIN SOUTH DAM YEAR 20 LAYOUT	
N, DIRECT DULY R OF	DRAWN: CAD	POLY MET MINING, INC. POLYMET HOYT LAKES, MINNESOTA	
DUE	CHECKED: TJR BARR PROJECT NO.: 23/69-0C29	BARR ENGINEERING CO 4700 WEST 77TH STRE MINNEAPOLIS, MN. Ph: 1-800-632-2277	
51	SCALE: AS SHOWN	DWG. NO. FTB-013	REV

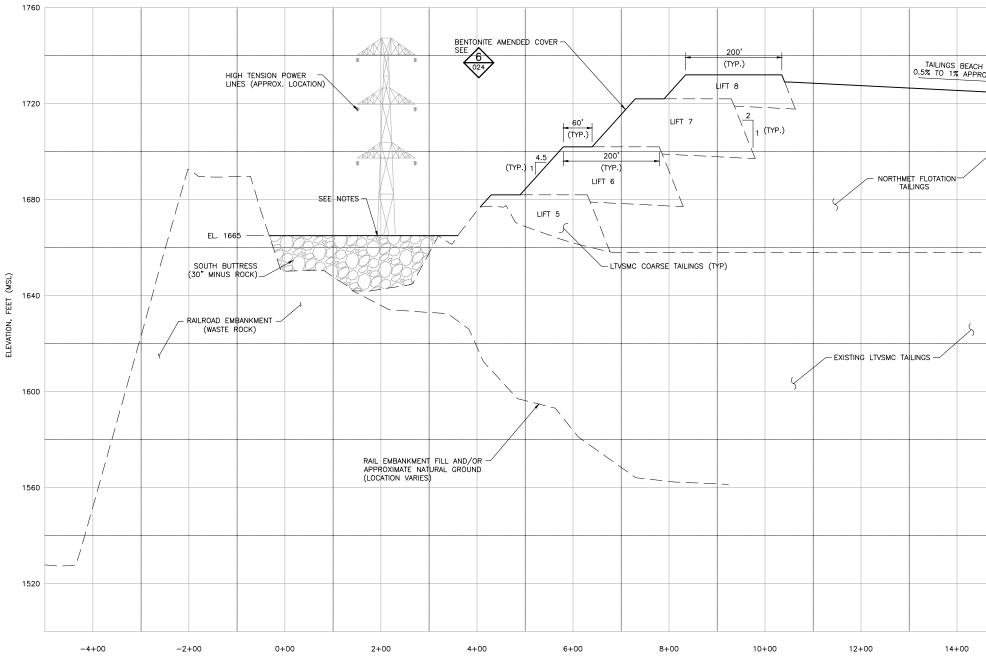


NOTES:

1. DAM DIMENSIONS MAY CHANGE WITH EVALUATION OF FUTURE PERFORMANCE DATA.

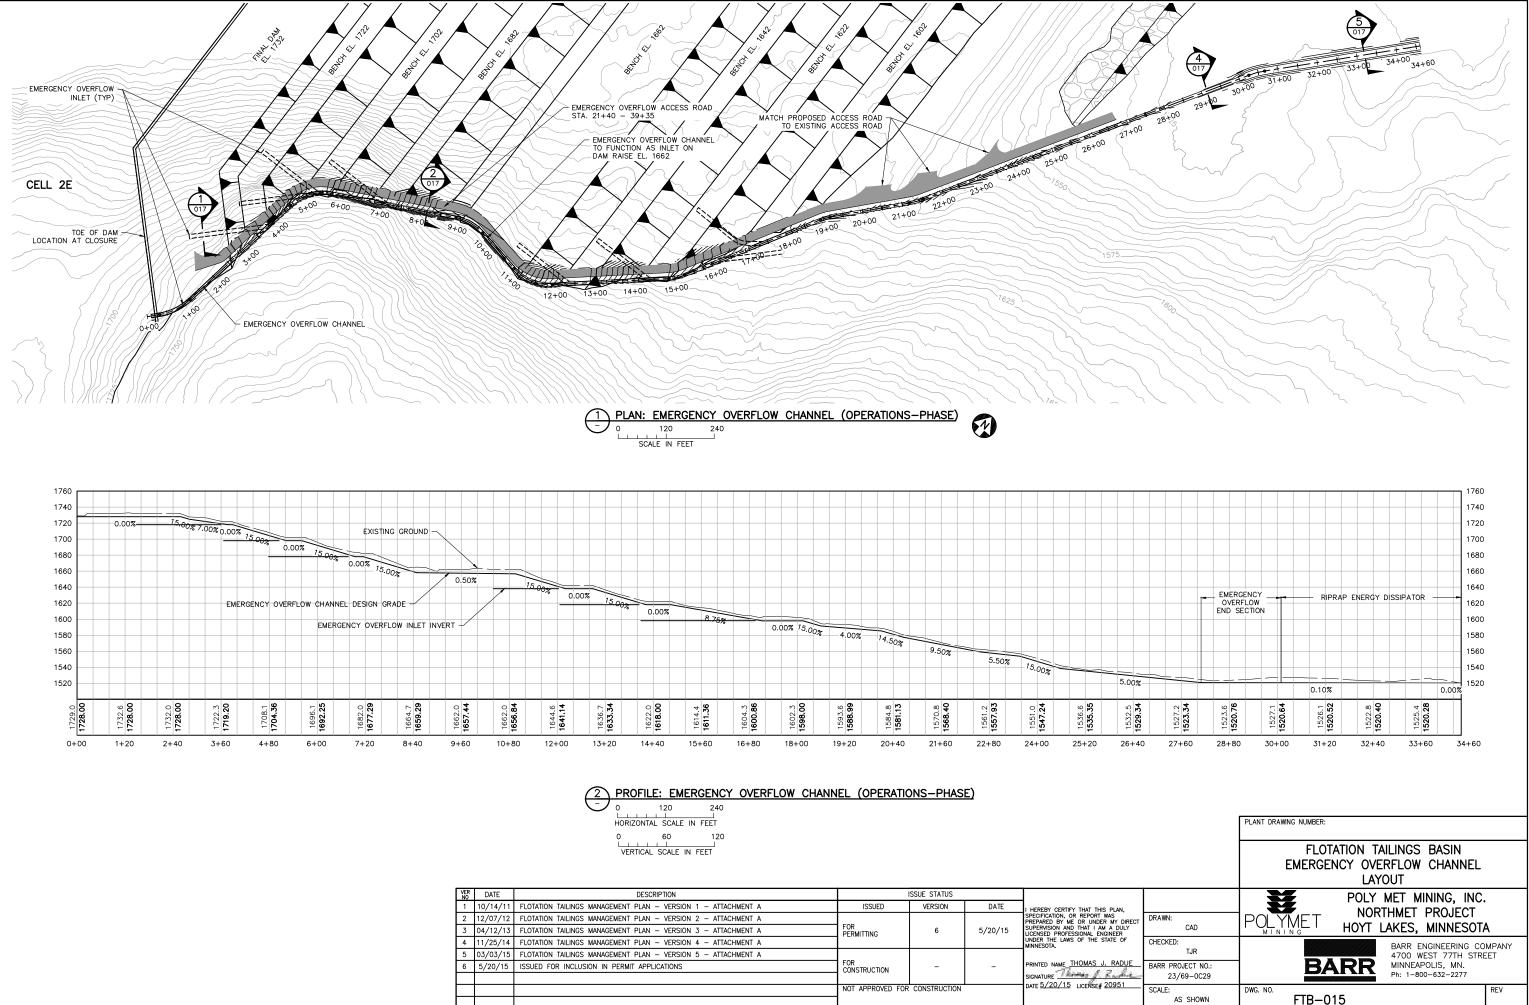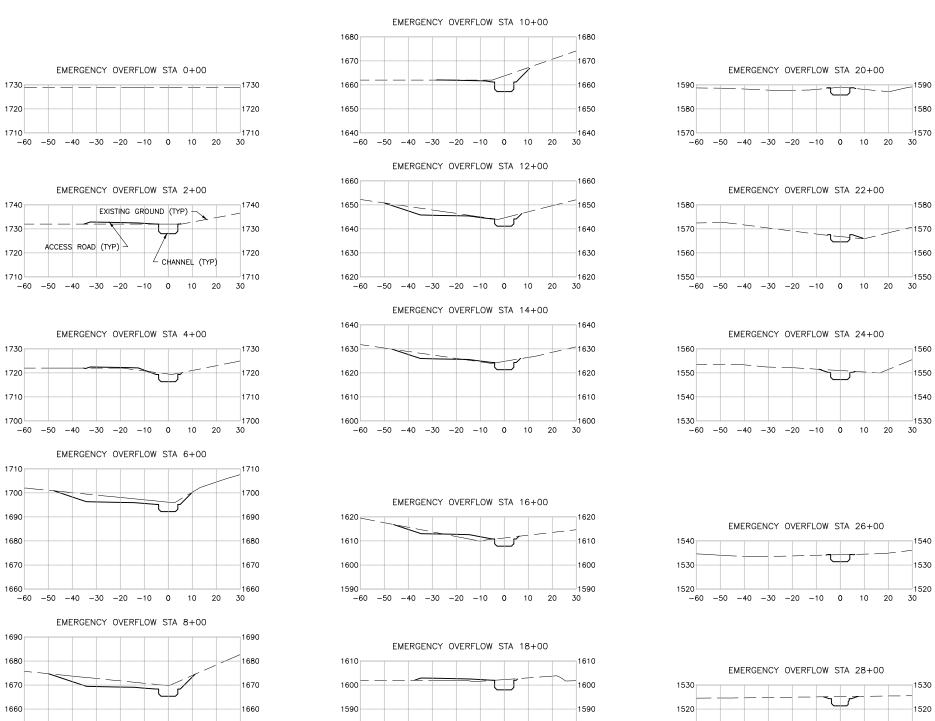
2. HIGH TENSION POWER LINES SHOWN FOR REFERENCE. TOWER FOUNDATIONS ARE LOCATED OUTSIDE OF THE AREA COVERED BY THE BUTTRESS.

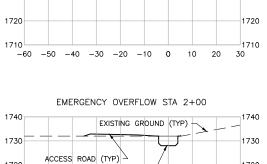
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														TYP	ICAL CRO	SS SECTIO	NS	
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	· ·			– VERSION 2 – ATTACHI		FOR			PREPARED BY ME OF	UNDER MY DIRE	CT DRAWN:	CAD	IPOL`	YMET		LAKES, MIN		
	· ·			- VERSION 3 - ATTACHI		PERMITTING	6	5/20/15	SUPERVISION AND TH LICENSED PROFESSION UNDER THE LAWS OF	NAL ENGINEER		UAD				LARES, MIN	INESUTA	
4	, ,			- VERSION 4 - ATTACHI					MINNESOTA.	THE STATE OF	CHECKED:	TJR				BARR ENGINE		
	· ·			- VERSION 5 - ATTACHI	MENT A	FOR			PRINTED NAME THO	MAS I RADUE			4		1 DD	4700 WEST 7		.T
6	5/20/15	ISSUED FOR INC	LUSION IN PERMIT APP	LICATIONS		CONSTRUCTION	-	-		And C. MADOL	BARR PROJ	ECT NO.: 9-0C29		B /	ARR	MINNEAPOLIS, Ph: 1-800-632	MIN. -2277	
						NOT APPROVED	FOR CONSTRUC	TION	DATE 5/20/15 LIC	ENSE# 20951	SCALE:		DWG. NO.					REV
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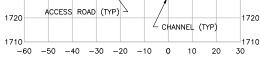
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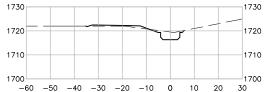
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2 12/	/07/12	FLOTATION TAILINGS MANAGEMENT PLAN - VERSION 2 - ATTACHMENT A				SPECIFICATION, OR REPORT WAS PREPARED BY ME OR UNDER MY DIR
3 04/	/12/13	FLOTATION TAILINGS MANAGEMENT PLAN - VERSION 3 - ATTACHMENT A	FOR PERMITTING	6		SUPERVISION AND THAT I AM A DULY LICENSED PROFESSIONAL ENGINEER
4 11/3	/25/14	FLOTATION TAILINGS MANAGEMENT PLAN - VERSION 4 - ATTACHMENT A	-			UNDER THE LAWS OF THE STATE OF MINNESOTA.
5 03/	/03/15	FLOTATION TAILINGS MANAGEMENT PLAN - VERSION 5 - ATTACHMENT A				
6 5/2	/20/15	ISSUED FOR INCLUSION IN PERMIT APPLICATIONS	FOR CONSTRUCTION	-	_	PRINTED NAME THOMAS J. RADU
						SIGNATURE
			NOT APPROVED FOR	CONSTRUCTION		DATE 5/20/15 LICENSE# 20951



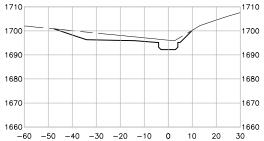




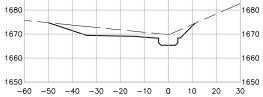


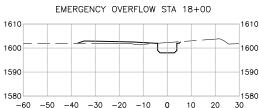




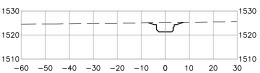


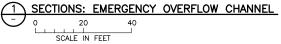

















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VER NO	DATE	DESCRIPTION		SSUE STATUS				POLY MET MININ	
		FLOTATION TAILINGS MANAGEMENT PLAN - VERSION 1 - ATTACHMENT A	ISSUED	VERSION	DATE	I HEREBY CERTIFY THAT THIS PLAN,			
2	12/07/12	FLOTATION TAILINGS MANAGEMENT PLAN - VERSION 2 - ATTACHMENT A				SPECIFICATION, OR REPORT WAS PREPARED BY ME OR UNDER MY DIRECT SUPERVISION AND THAT I AM A DULY	DRAWN:	POLYMET NORTHMET PR	
3	04/12/13	FLOTATION TAILINGS MANAGEMENT PLAN - VERSION 3 - ATTACHMENT A	FOR PERMITTING	6	5/20/15	LICENSED PROFESSIONAL ENGINEER	CAD	HOYT LAKES, MI	NNESUIA
4	11/25/14	FLOTATION TAILINGS MANAGEMENT PLAN - VERSION 4 - ATTACHMENT A				UNDER THE LAWS OF THE STATE OF MINNESOTA.	CHECKED:	BARR ENGIN	EERING COMPANY
5	03/03/15	FLOTATION TAILINGS MANAGEMENT PLAN - VERSION 5 - ATTACHMENT A					TJR	4700 WEST	77TH STREET
6	5/20/15	ISSUED FOR INCLUSION IN PERMIT APPLICATIONS		-	-	PRINTED NAME THOMAS J. RADUE	BARR PROJECT NO.: 23/69-0C29	BARR MINNEAPOLIS Ph: 1-800-63	
			NOT APPROVED FOR	CONSTRUCTION		DATE 5/20/15 LICENSE# 20951	SCALE: AS SHOWN	DWG. NO. FTB-016	REV

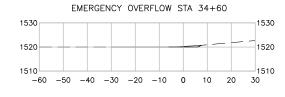

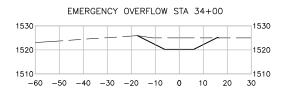

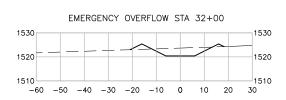


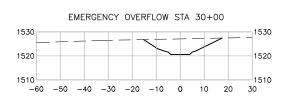


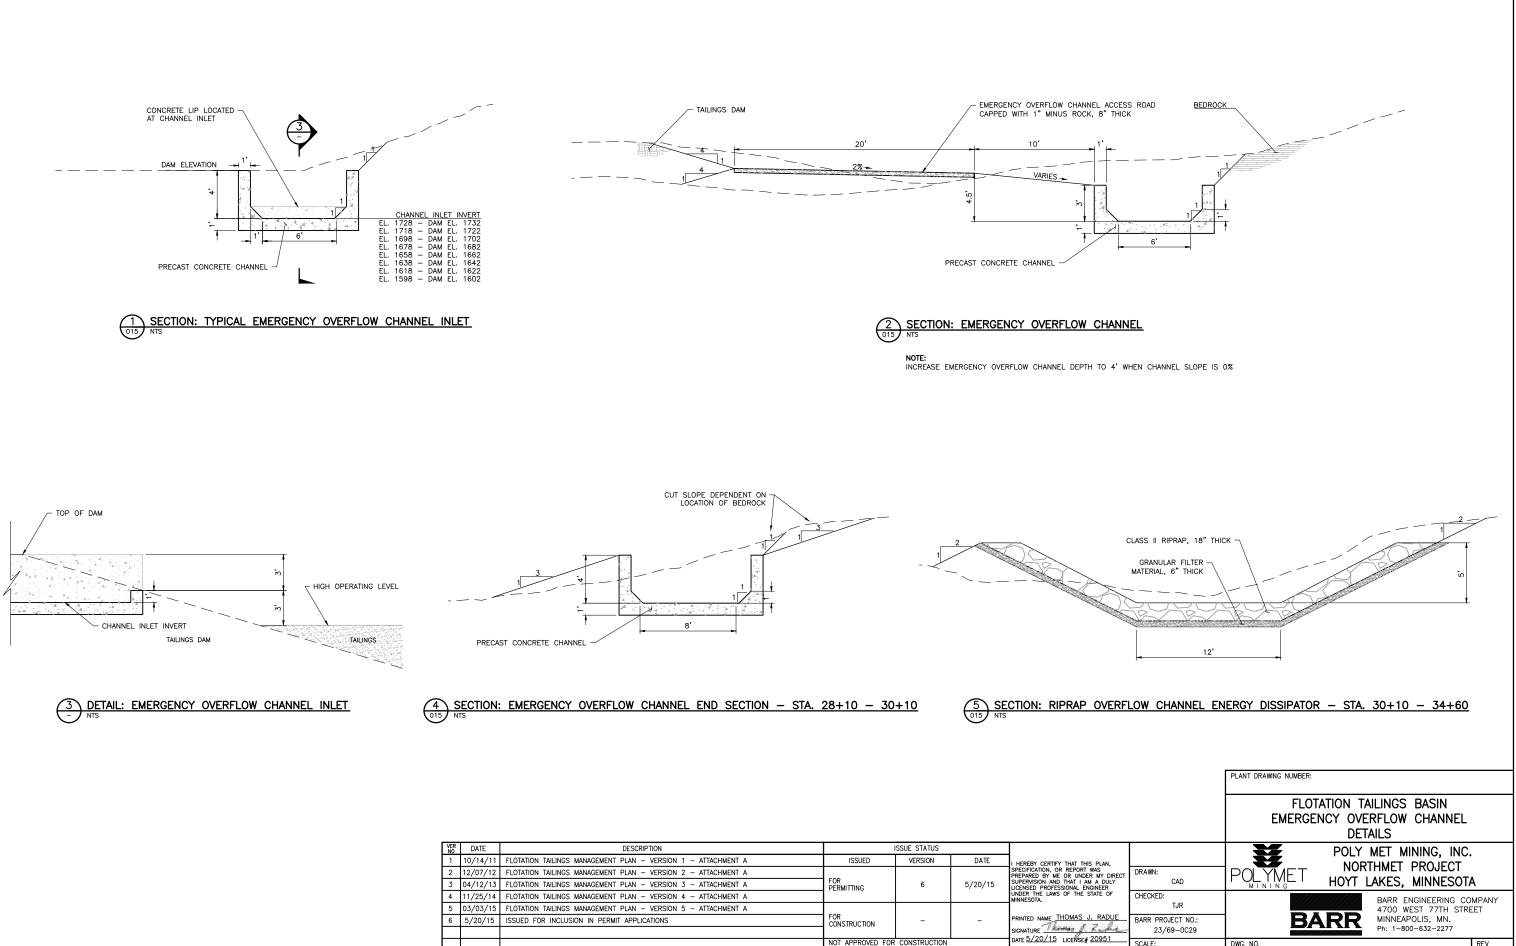

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AN, ' DIRECT DULY ER	DRAWN: CAD	POLY MET MINING, INC. NORTHMET PROJECT HOYT LAKES, MINNESOTA	
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51	SCALE: AS SHOWN	DWG. NO. FTB-017	REV



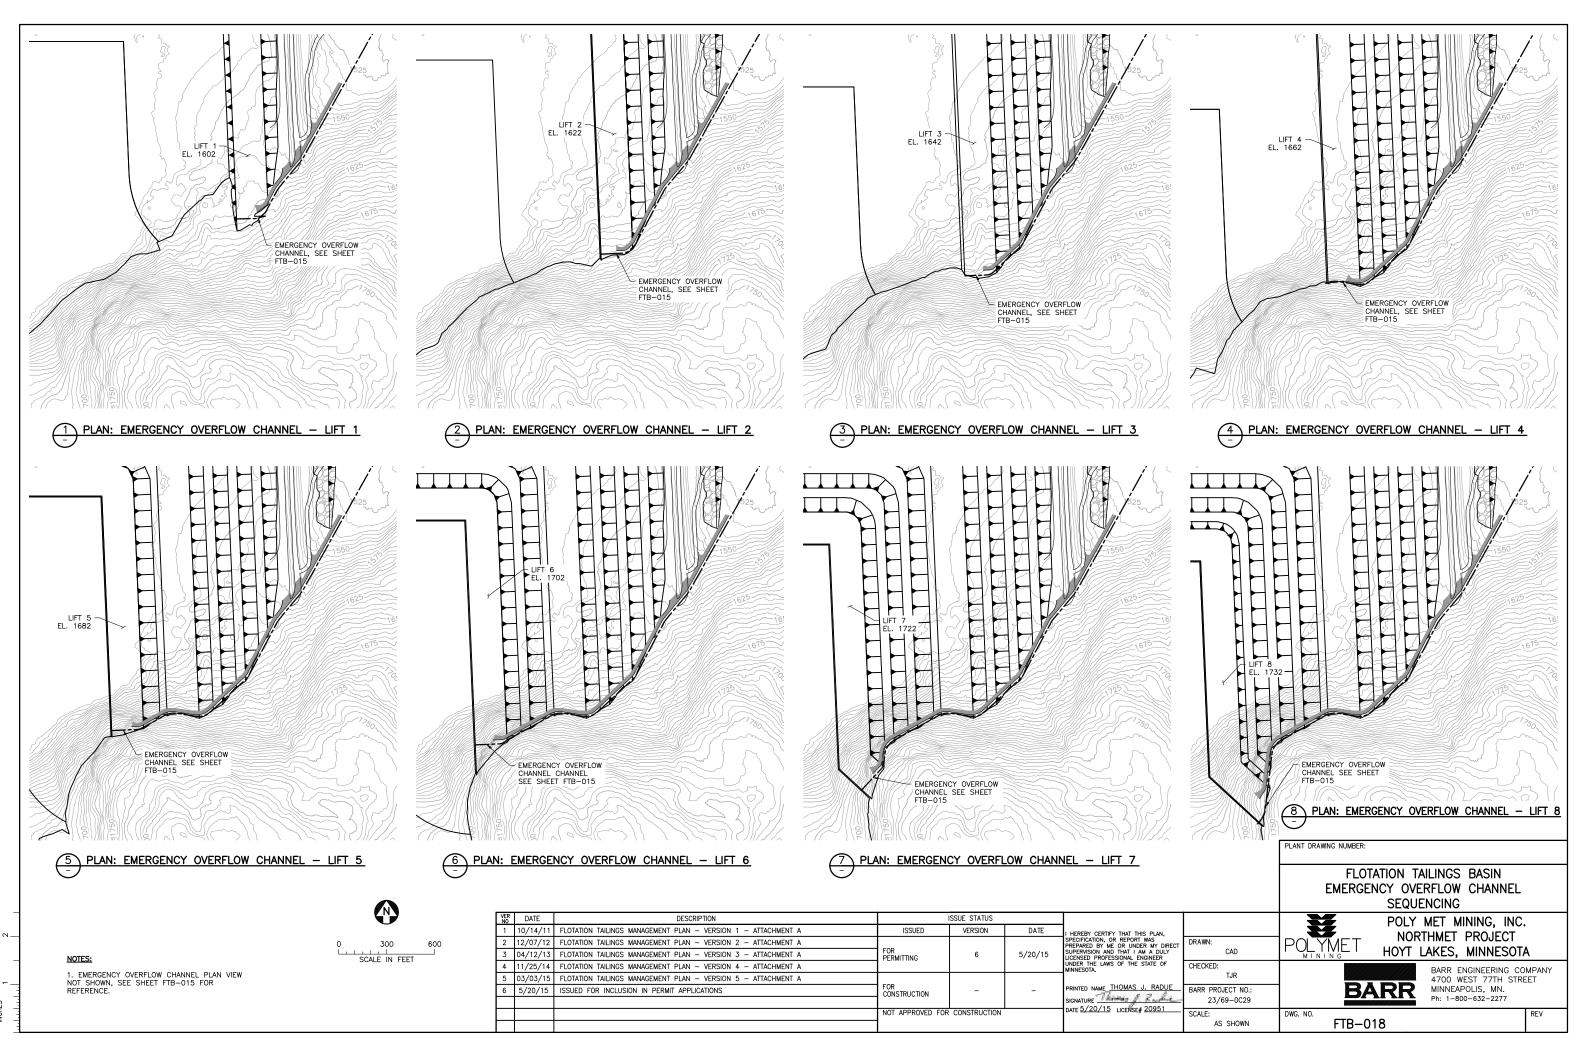

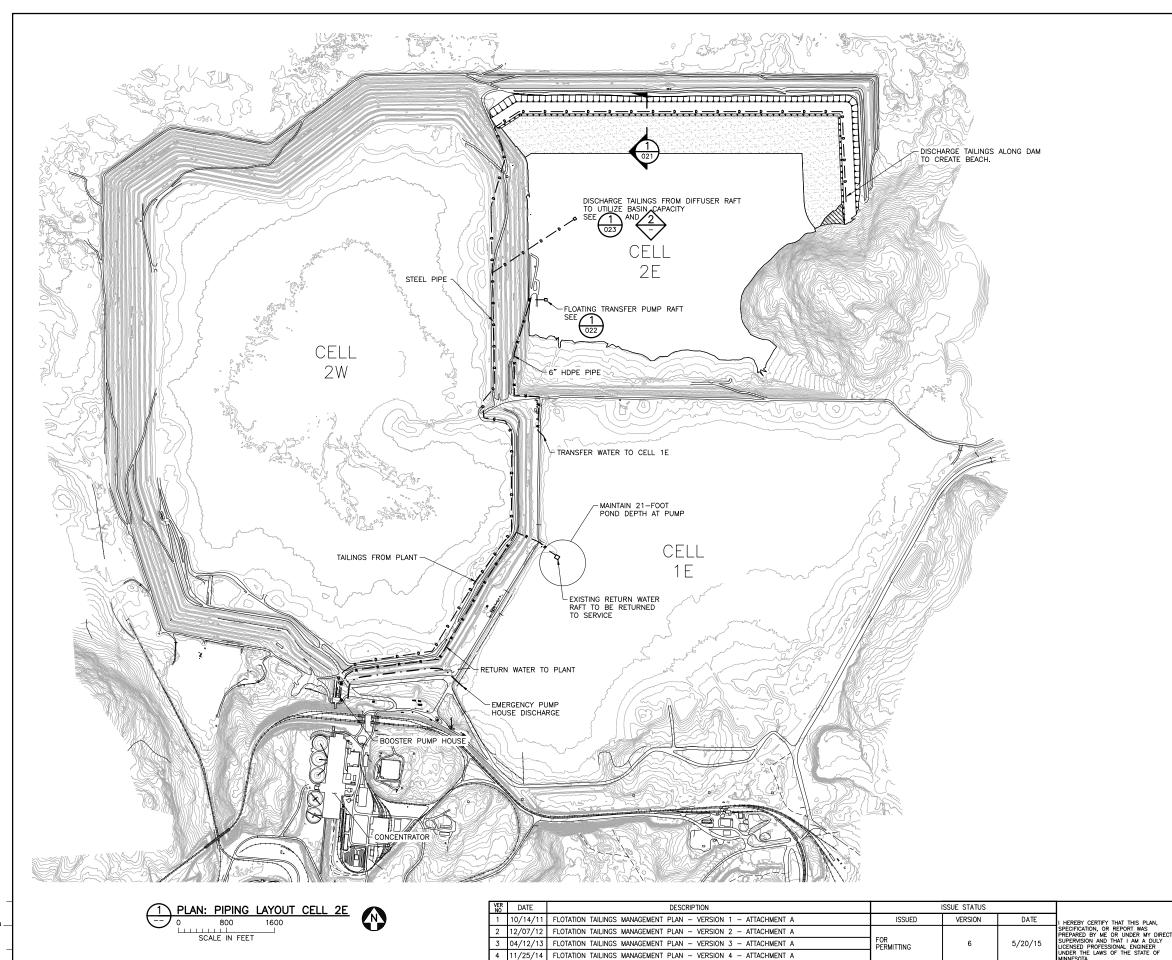
5 03/03/15 FLOTATION TAILINGS MANAGEMENT PLAN - VERSION 5 - ATTACHMENT A

FOR CONSTRUCTION

NOT APPROVED FOR CONSTRUCTION

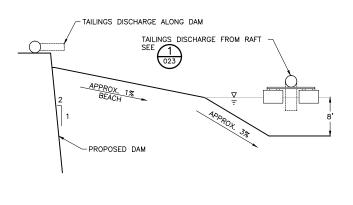6 5/20/15 ISSUED FOR INCLUSION IN PERMIT APPLICATIONS

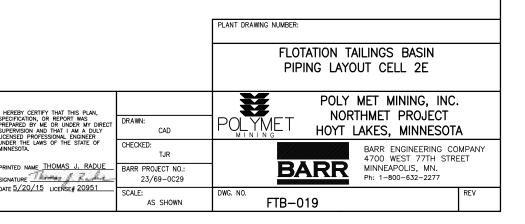
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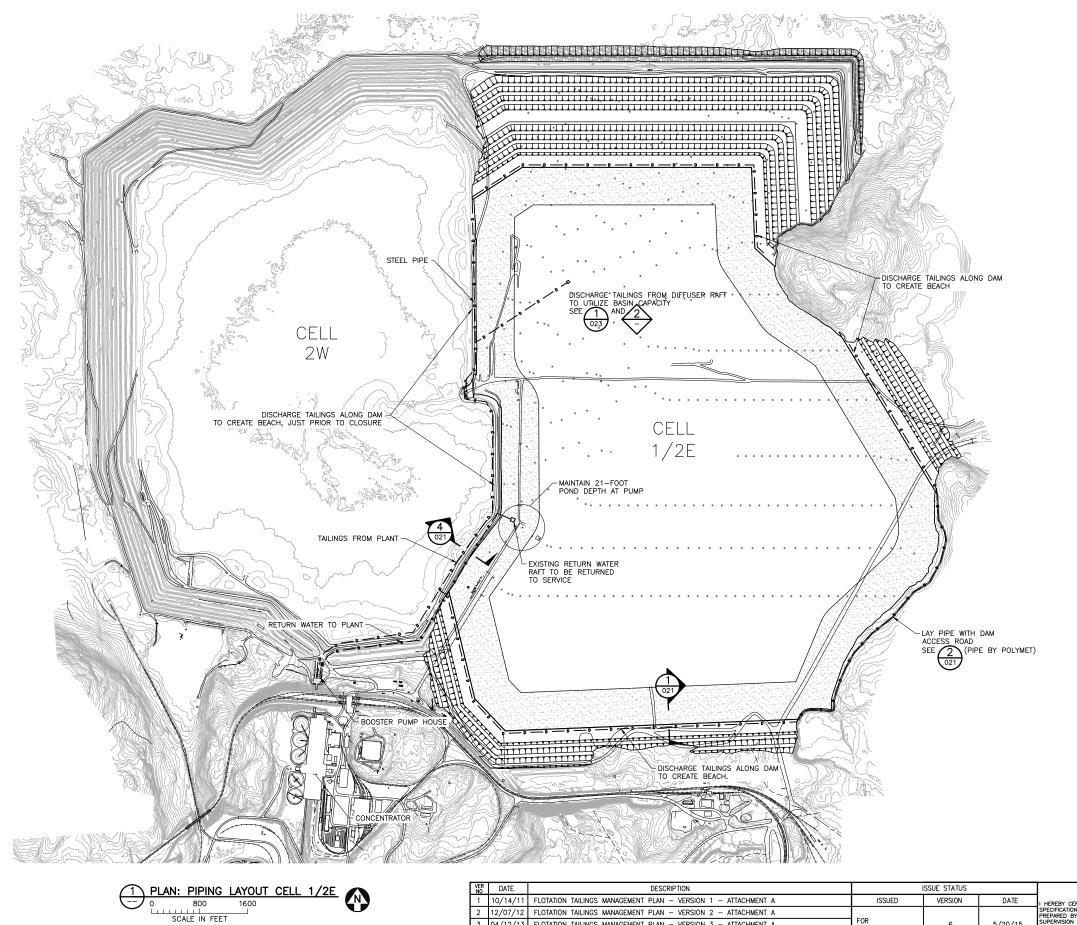




NOTES:

- 1. CONTOURS DO NOT REFLECT BORROW REMOVAL.
- 2. PIPELINE LOCATIONS ARE PRELIMINARY.






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2	12/07/12	FLOTATION TAILINGS MANAGEMENT PLAN - VERSION 2 - ATTACHMENT A				SPECIFICATION, OR REPORT WAS PREPARED BY ME OR UNDER MY DIRECT
3	04/12/13	FLOTATION TAILINGS MANAGEMENT PLAN - VERSION 3 - ATTACHMENT A	FOR	6		SUPERVISION AND THAT I AM A DULY LICENSED PROFESSIONAL ENGINEER
4	11/25/14	FLOTATION TAILINGS MANAGEMENT PLAN - VERSION 4 - ATTACHMENT A	-			UNDER THE LAWS OF THE STATE OF MINNESOTA.
5	03/03/15	FLOTATION TAILINGS MANAGEMENT PLAN - VERSION 5 - ATTACHMENT A				
6	5/20/15	ISSUED FOR INCLUSION IN PERMIT APPLICATIONS	FOR CONSTRUCTION	-		PRINTED NAME THOMAS J. RADUE
						SIGNATURE
			NOT APPROVED FOR	CONSTRUCTION		DATE 57 207 15 LICENSE# 20951


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AN, 7 DIRECT DULY ER 3 OF	DRAWN: CAD	POLY MET MINING, INC. NORTHMET PROJECT HOYT LAKES, MINNESOTA	
ADUE	CHECKED: TJR BARR PROJECT NO.: 23/69-0C29	BARR ENGINEERING COM 4700 WEST 77TH STRE MINNEAPOLIS, MN. Ph: 1-800-632-2277	
51	SCALE: AS SHOWN	DWG. NO. FTB-020	REV


1. PIPELINE LOCATIONS ARE PRELIMINARY.

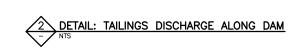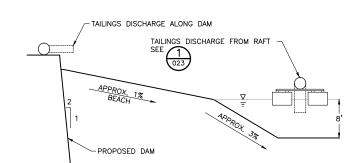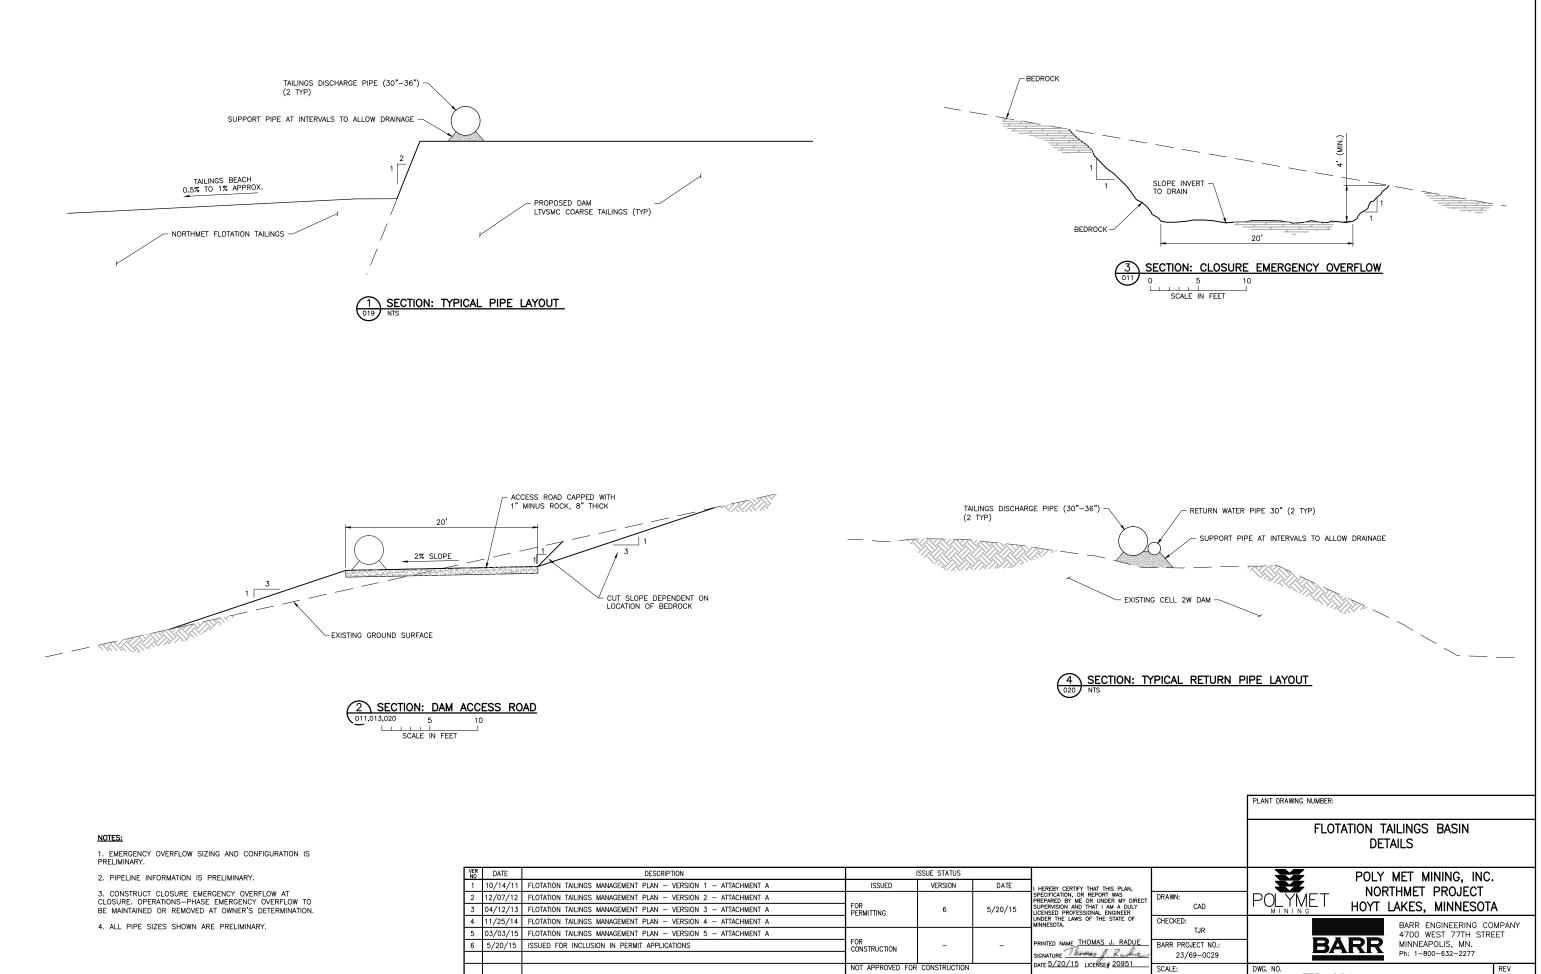NOTES:










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	2	12/07/12	FLOTATION TAILINGS MANAGEMENT PLAN - VERSION 2 - ATTACHMENT A				SPECIFICATION, OR REPORT WAS PREPARED BY ME OR UNDER MY DIRE
	3	04/12/13	FLOTATION TAILINGS MANAGEMENT PLAN - VERSION 3 - ATTACHMENT A	FOR PERMITTING	6		SUPERVISION AND THAT I AM A DULY
	4	11/25/14	FLOTATION TAILINGS MANAGEMENT PLAN - VERSION 4 - ATTACHMENT A				UNDER THE LAWS OF THE STATE OF MINNESOTA.
	5	03/03/15	FLOTATION TAILINGS MANAGEMENT PLAN - VERSION 5 - ATTACHMENT A				
	6	5/20/15	ISSUED FOR INCLUSION IN PERMIT APPLICATIONS	FOR	-		PRINTED NAME THOMAS J. RADUE
				NOT APPROVED FOR	CONSTRUCTION		DATE <u>5/20/15</u> LICENSE# <u>20951</u>

FTB-021

AS SHOWN

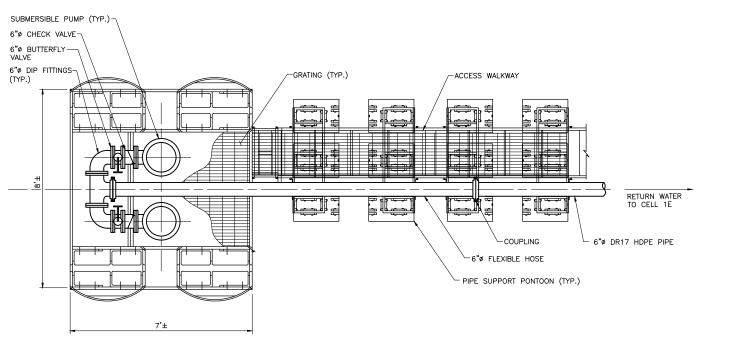FOR PIPE ALIGNMENT, SEE TO CELL 1E 2-12"ø FLEXIBLE HOSE-12"ø DR17 HDPE RETURN WATER PIPE-ANCHOR BLOCK FLOATING PUMP STATION ACCESS WALKWAY -SUBMERSIBLE PUMP (TYP. OF 2) $\begin{pmatrix} 2 \\ - \end{pmatrix}$ **C111** - EXISTING CELL 2W DAM ∇ $\underbrace{1}_{0} \underbrace{\text{ELEVATION: TRANSFER PUMP RAFT}}_{0}$ ANCHOR BLOCK 0 2 4 6 8 SCALE IN FEET






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3	04/12/13	FLOTATION TAILINGS MANAGEMENT PLAN - VERSION 3 - ATTACHMENT A	FOR	6	5/20/15	SUPERVISION AND THAT I AM A DULY
4	11/25/14	FLOTATION TAILINGS MANAGEMENT PLAN - VERSION 4 - ATTACHMENT A				UNDER THE LAWS OF THE STATE OF MINNESOTA.
5	03/03/15	FLOTATION TAILINGS MANAGEMENT PLAN - VERSION 5 - ATTACHMENT A				
6	5/20/15	ISSUED FOR INCLUSION IN PERMIT APPLICATIONS		-		PRINTED NAME THOMAS J. RADU
						SIGNATURE
			NOT APPROVED FOR	CONSTRUCTION		DATE 3/20/13 LICENSE# 20931


		FLOTATION TAILINGS BASIN TRANSFER PUMP VENT				
AN, DIRECT DULY ER OF	DRAWN: CAD	POLY MET MINING, INC. NORTHMET PROJECT HOYT LAKES, MINNESOT/				
ADUE	CHECKED: TJR BARR PROJECT NO.: 23/69-0C29	BARR ENGINEERING CC 4700 WEST 77TH STRE MINNEAPOLIS, MN. Ph: 1-800-632-2277				
51	SCALE: AS SHOWN	DWG. NO. FTB-022	REV			

PLANT DRAWING NUMBER:

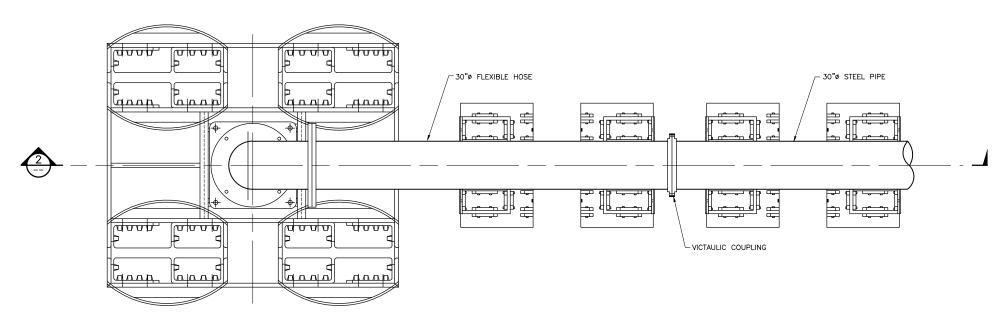
NOTES: 1. ALL PIPE SIZES SHOWN ARE PRELIMINARY.




1 PLAN: TAILINGS DISPOSAL DIFFUSER RAFT

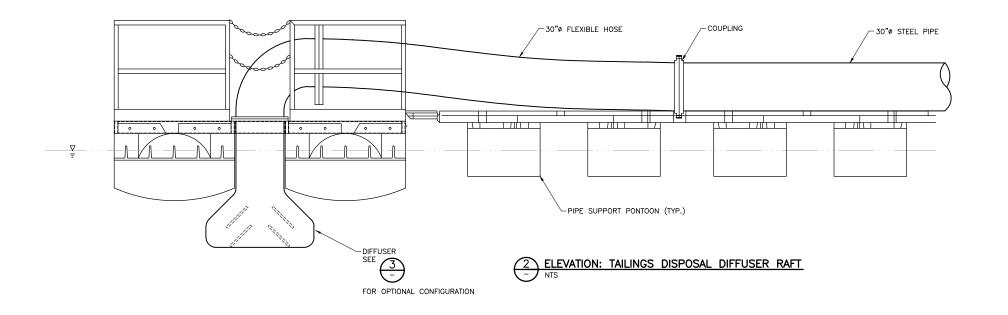

VER NO	DATE	DESCRIPTION		ISSUE STATUS		
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3	04/12/13	FLOTATION TAILINGS MANAGEMENT PLAN - VERSION 3 - ATTACHMENT A	FOR PERMITTING	6		SUPERVISION AND THAT I AM A DU LICENSED PROFESSIONAL ENGINEER
4	11/25/14	FLOTATION TAILINGS MANAGEMENT PLAN - VERSION 4 - ATTACHMENT A				UNDER THE LAWS OF THE STATE C MINNESOTA.
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			NOT APPROVED FOR	CONSTRUCTION		DATE 5/20/15 LICENSE# 20951

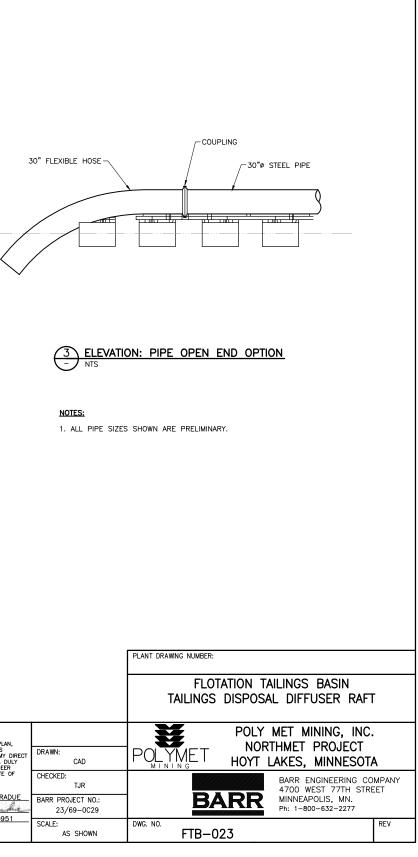

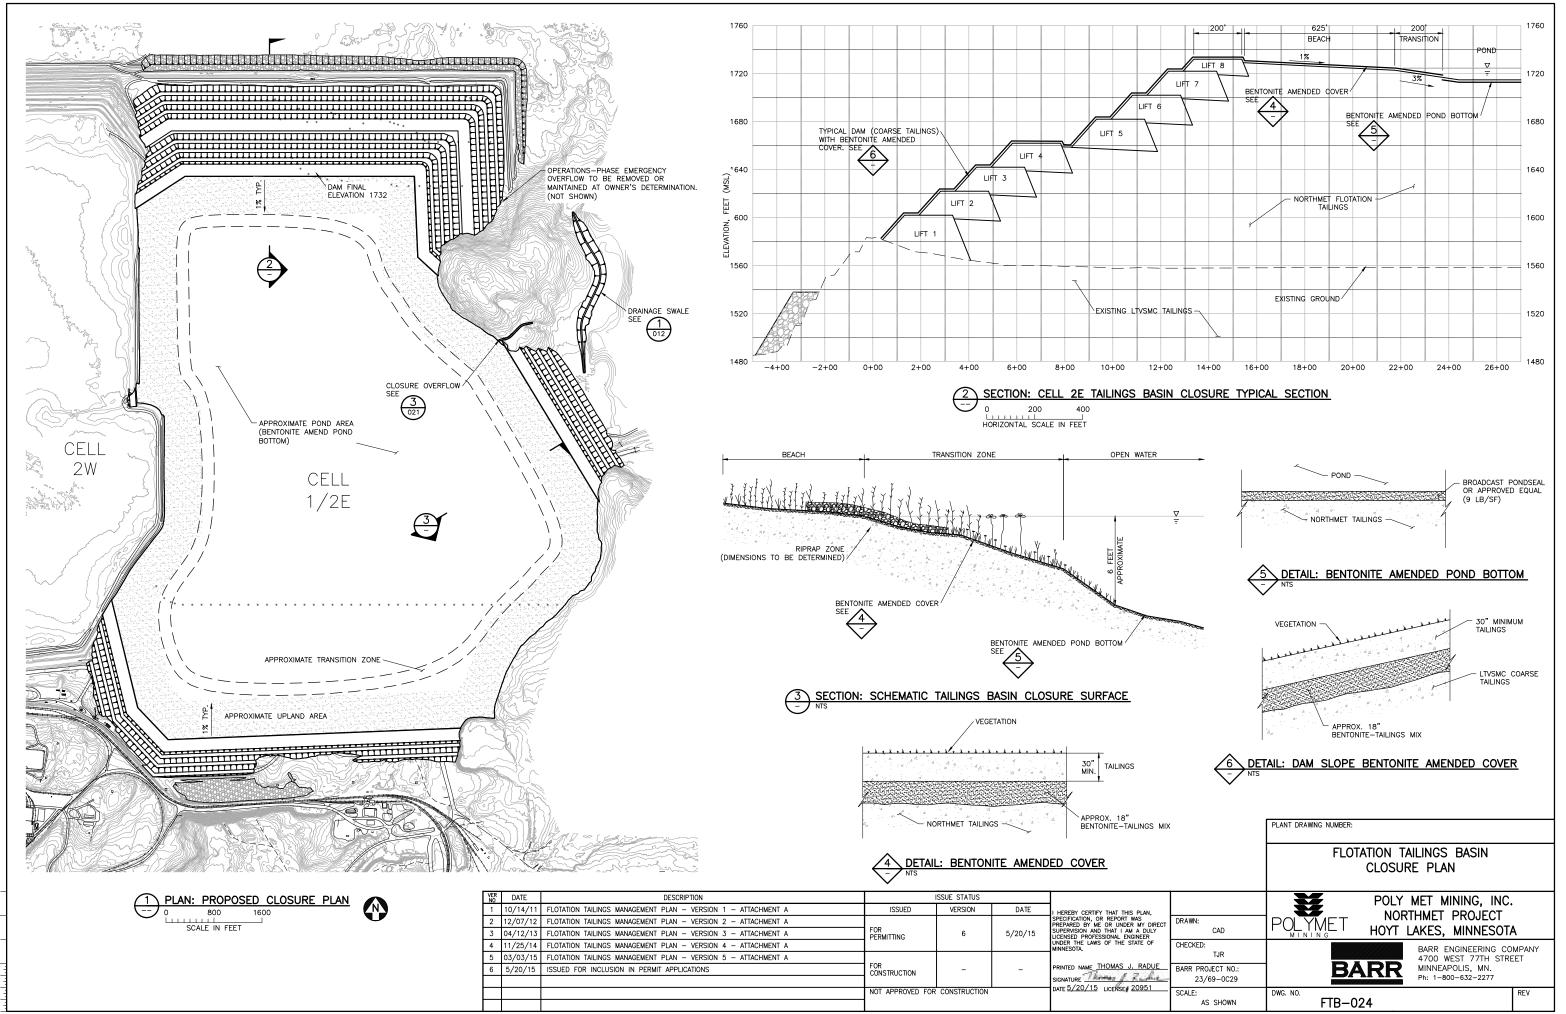

Errata Sheet

Poly Met Mining, Inc. NorthMet Project


Permit Application Support Drawings: FTB Seepage Containment and Stream Augmentation Systems

July 2016 (version 2)

Engineering design is currently in progress. The table below lists changes that have been identified todate and have not yet been incorporated in the attached permit application support drawings within this set. Final design will incorporate these changes along with additional site-specific information (e.g., supplementary geotechnical data); therefore, additional adjustments may be made during final design that will be incorporated into the final design drawing set.

Drawing Sheet(s)	Change
FTBCA-002	A note 5 will be added to say: The term "stream augmentation" in this drawing set is synonymous with "surface water discharge"; these terms are used in the Water Appropriations Consolidated Permit Application and the NPDES/SDS Permit Application, respectively.
FTBCA-013, FTBCA-015	The cross slope on the perimeter access road surface will be revised so that it slopes entirely towards the FTB, instead of being crowned in the center.
FTBCA-013, FTBCA-015	To eliminate additional fill in wetlands, the monitoring wells located outside of the perimeter access road will be moved to within the road embankment.
FTBCA-004 through FTBCA-010	The final location and number of discharge locations to Unnamed Creek and Trimble Creek will be determined in permitting and final design.

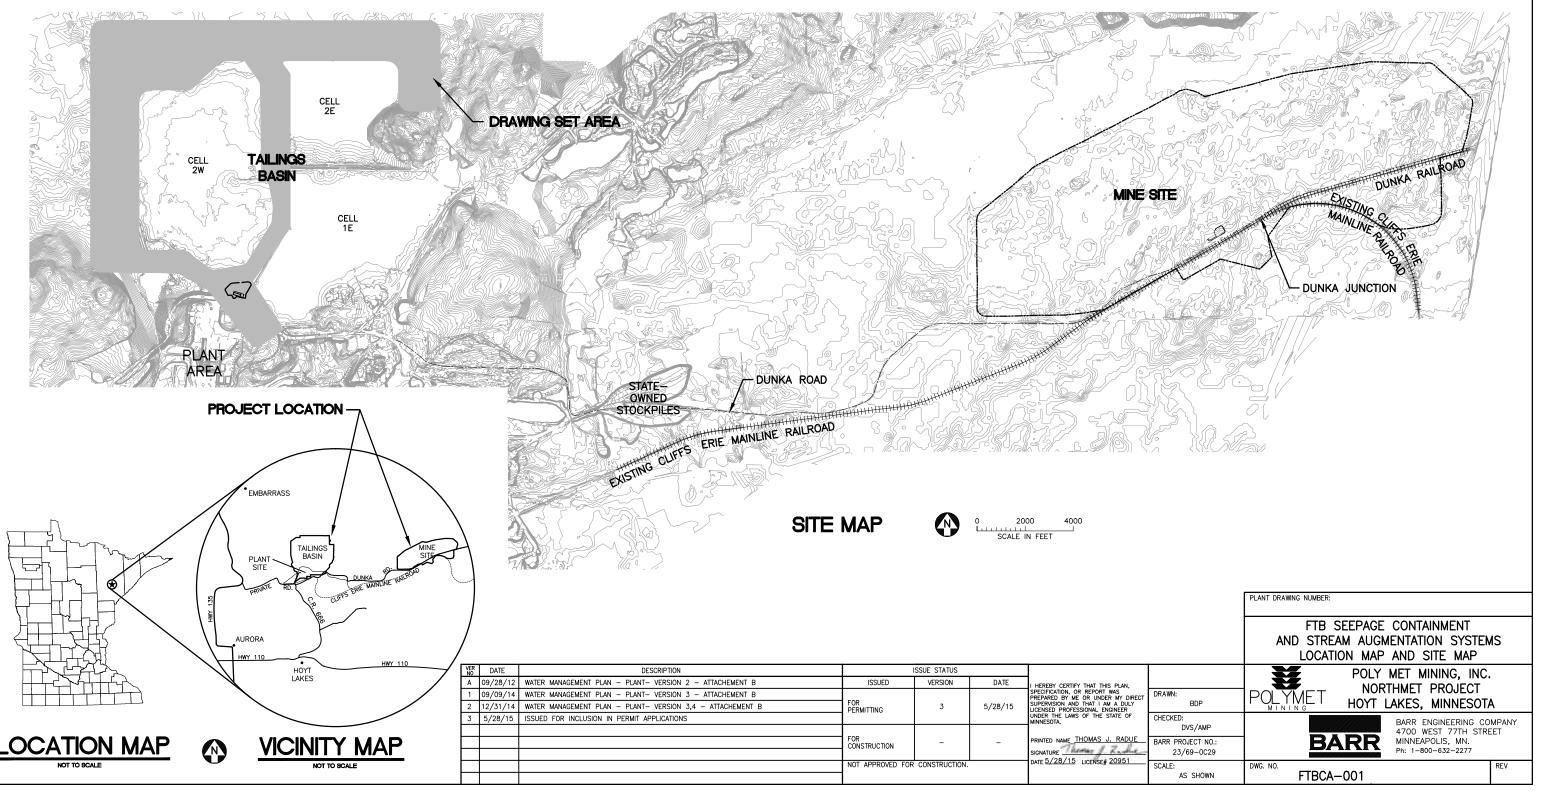POLY MET MINING, INC. NORTHMET PROJECT FTB SEEPAGE CONTAINMENT AND STREAM AUGMENTATION SYSTEMS HOYT LAKES, MINNESOTA



GENERAL LEGEND

	EXISTING CONTOUR - MAJOR
	EXISTING CONTOUR - MINOR
1000	PROPOSED CONTOUR - MAJOR
	PROPOSED CONTOUR - MINOR
8	EXISTING POWER POLE
+++++++++++++++++++++++++++++++++++++++	EXISTING RAILROAD
	EXISTING ROAD
	EXISTING TRAIL
= $=$ $=$ $=$	EXISTING UNIMPROVED TRAIL
	EXISTING STRUCTURES
	TREE LINE
	WETLAND BOUNDARY
\rightarrow	EXISTING CULVERT
P	EXISTING PIPELINE
+ +-	CUTOFF WALL ALIGNMENT
	OVERHEAD ELECTRIC
	SURFACE DRAINAGE
	PROPOSED DEWATERING PIPE
	PROPOSED DISCHARGE PIPELINE
	PROPOSED RETURN PIPELINE
\succ	PROPOSED CULVERT (NON-MINE DRAINAGE)
	PROPOSED SEEPAGE COLLECTION DRAIN
	PROPOSED STORMWATER DRAIN
0	PROPOSED MANHOLE
	PROPOSED RIP RAP
•	ROTASONIC BORING
۲	ROTASONIC BORING WITH PIEZOMETER
۵	SPT BORING
۲	SPT BORING WITH PACKER
M	FLOW METER

ABBREVIATIONS


APPROX.	-	APPROXIMATE
CDSM	-	CEMENT DEEP SOIL MIX
CMP	-	CORRUGATED METAL PIPE
CPEP	-	CORRUGATED POLYETHYLENE PIPE
CY	-	CUBIC YARD
DR	-	DIMENSION RATIO
DWG	-	DRAWING
EL.	-	ELEVATION
ø	-	DIAMETER
FTB	-	FLOTATION TAILINGS BASIN
GCL	-	GEOSYNTHETIC CLAY LINER
HDPE	-	HIGH DENSITY POLYETHYLENE
HRF	-	HYDROMETALLURGICAL RESIDUE FACILITY
LDPE	-	LOW DENSITY POLYETHYLENE
LF	-	LINER FEET
LTVSMC	-	LTV STEEL MINING COMPANY
MCY	-	MILLION CUBIC YARDS
mil	-	one thousandth of an inch
MIN	-	MINIMUM
MSL	-	MEAN SEA LEVEL
NTS	-	NOT TO SCALE
SCH.	-	SCHEDULE
DR	-	DIMENSION RATIO
TYP	-	TYPICAL
N-MH-XX	-	NORTH SECTION MANHOLE
NW-MH-XX	-	NORTHWEST SECTION MANHOLE
W-MH-XX	-	WEST SECTION MANHOLE
N-MH/PS-XX	-	NORTH SECTION MANHOLE/PUMP STATION
NW-MH/PS-XX	-	NORTHWEST SECTION MANHOLE
W-MH/PS-XX	-	WEST SECTION MANHOLE/PUMP STATION

SHEET INDEX

SHEET NO. TITLE

FTBCA-001 FTBCA-002	LOCATION MAP AND SITE MAP LEGEND AND SHEET INDEX
FTBCA-003	PLAN SHEET LAYOUT
FTBCA-004	PLAN AND PROFILE- STATION (
FTBCA-005	PLAN AND PROFILE- STATION 3
FTBCA-006	PLAN AND PROFILE- STATION 6
FTBCA-007	PLAN AND PROFILE- STATION S
FTBCA-008	PLAN AND PROFILE- STATION 1
FTBCA-009	PLAN AND PROFILE- STATION 1
FTBCA-010	PLAN AND PROFILE- STATION 1
FTBCA-011	PLAN AND PROFILE- STATION 2
FTBCA-012	EAST SECTION PLAN & PROFILE
FTBCA-013	DETAILS
FTBCA-014	DETAILS
FTBCA-015	DETAILS

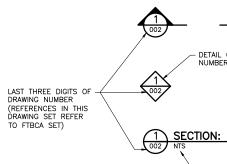DRAWING NUMBERING



<u>NOTES</u>

- 1. COORDINATE SYSTEM IS MINNESOTA STATE PLANE NORTH ZONE, NAD83.
- 2. ELEVATIONS ARE MEAN SEA LEVEL (MSL), NAVD88.


- 3. EXISTING TOPOGRAPHIC INFORMATION SHOWN ON THE DRAWINGS WAS PREPARED BY AEROMETRIC, INC. FROM LIDAR DATA COLLECTED ON MARCH 17, 2010.
- 4. EXISTING TOPOGRAPHIC INFORMATION WAS UPDATED FOR AREAS SOUTH EAST OF COAL ASH LANDFILL AND EAST OF OUTCROP BETWEEN CELLS 1E AND 2E USING CONTOURS FROM DATA COLLECTED IN 1999.


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2	12/31/14	WATER MANAGEMENT PLAN - PLANT- VERSION 3,4 - ATTACHEMENT B	FOR PERMITTING	3	5/28/15	SUPERVISION AND THAT I AM A DULY LICENSED PROFESSIONAL ENGINEER
3	5/28/15	ISSUED FOR INCLUSION IN PERMIT APPLICATIONS				UNDER THE LAWS OF THE STATE OF MINNESOTA.
			FOR CONSTRUCTION	-	-	PRINTED NAME THOMAS J. RADUE
						SIGNATURE 7
			NOT APPROVED FOR	CONSTRUCTION.		DATE 37 267 13 LICENSE# 20931

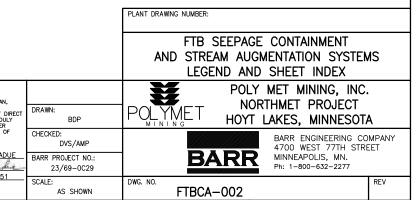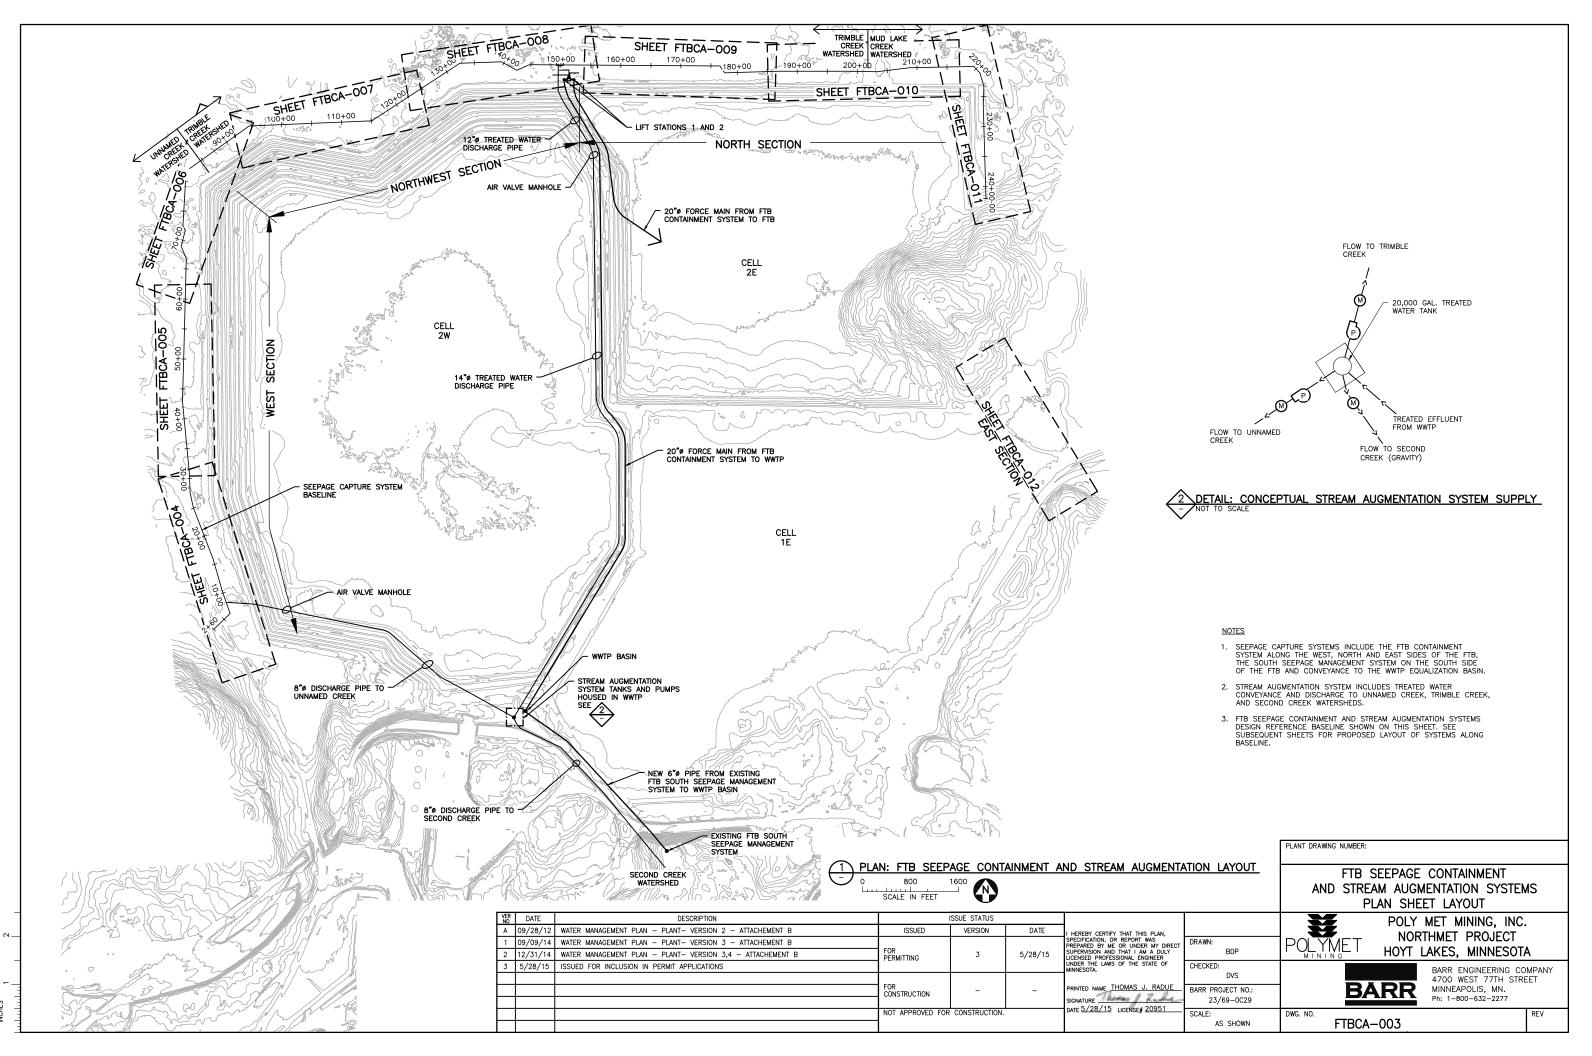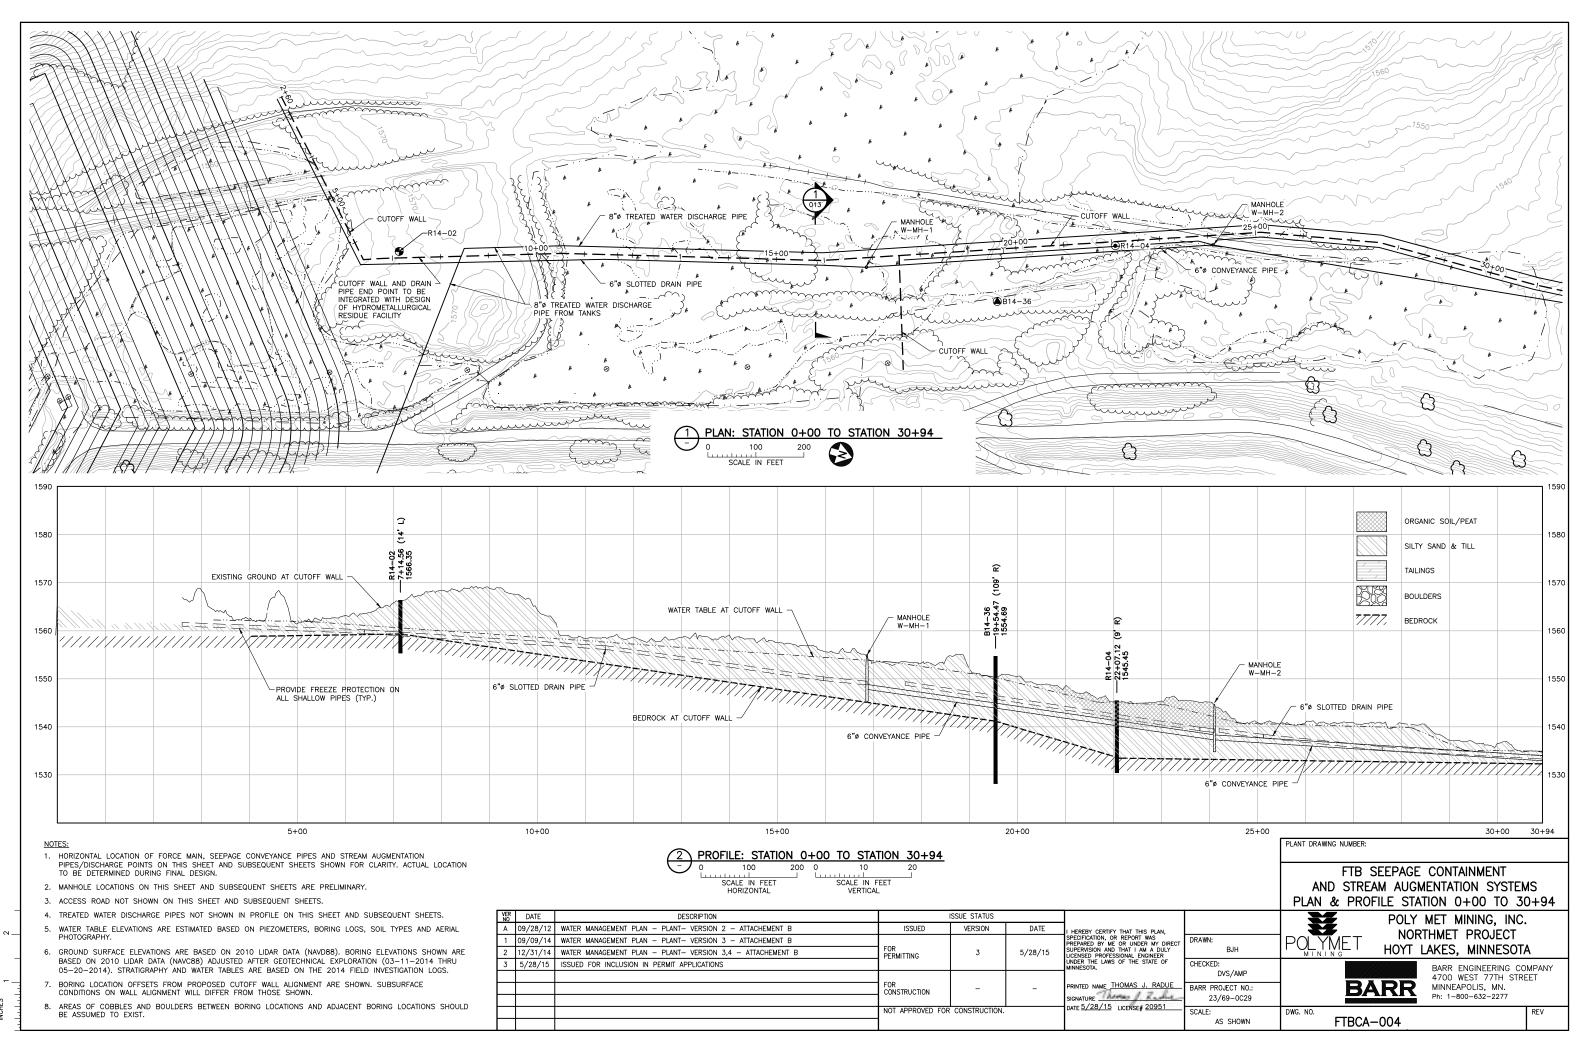
DN 0+00 TO STATION 30+94 DN 30+94 TO STATION 61+88 DN 61+88 TO STATION 92+82 DN 92+82 TO STATION 123+76 DN 123+76 TO STATION 154+70 DN 154+70 TO STATION 154+64 DN 185+64 TO STATION 216+58 DN 216+58 TO STATION 240+17 DFILE STATION 0+00 TO STATION 25+43

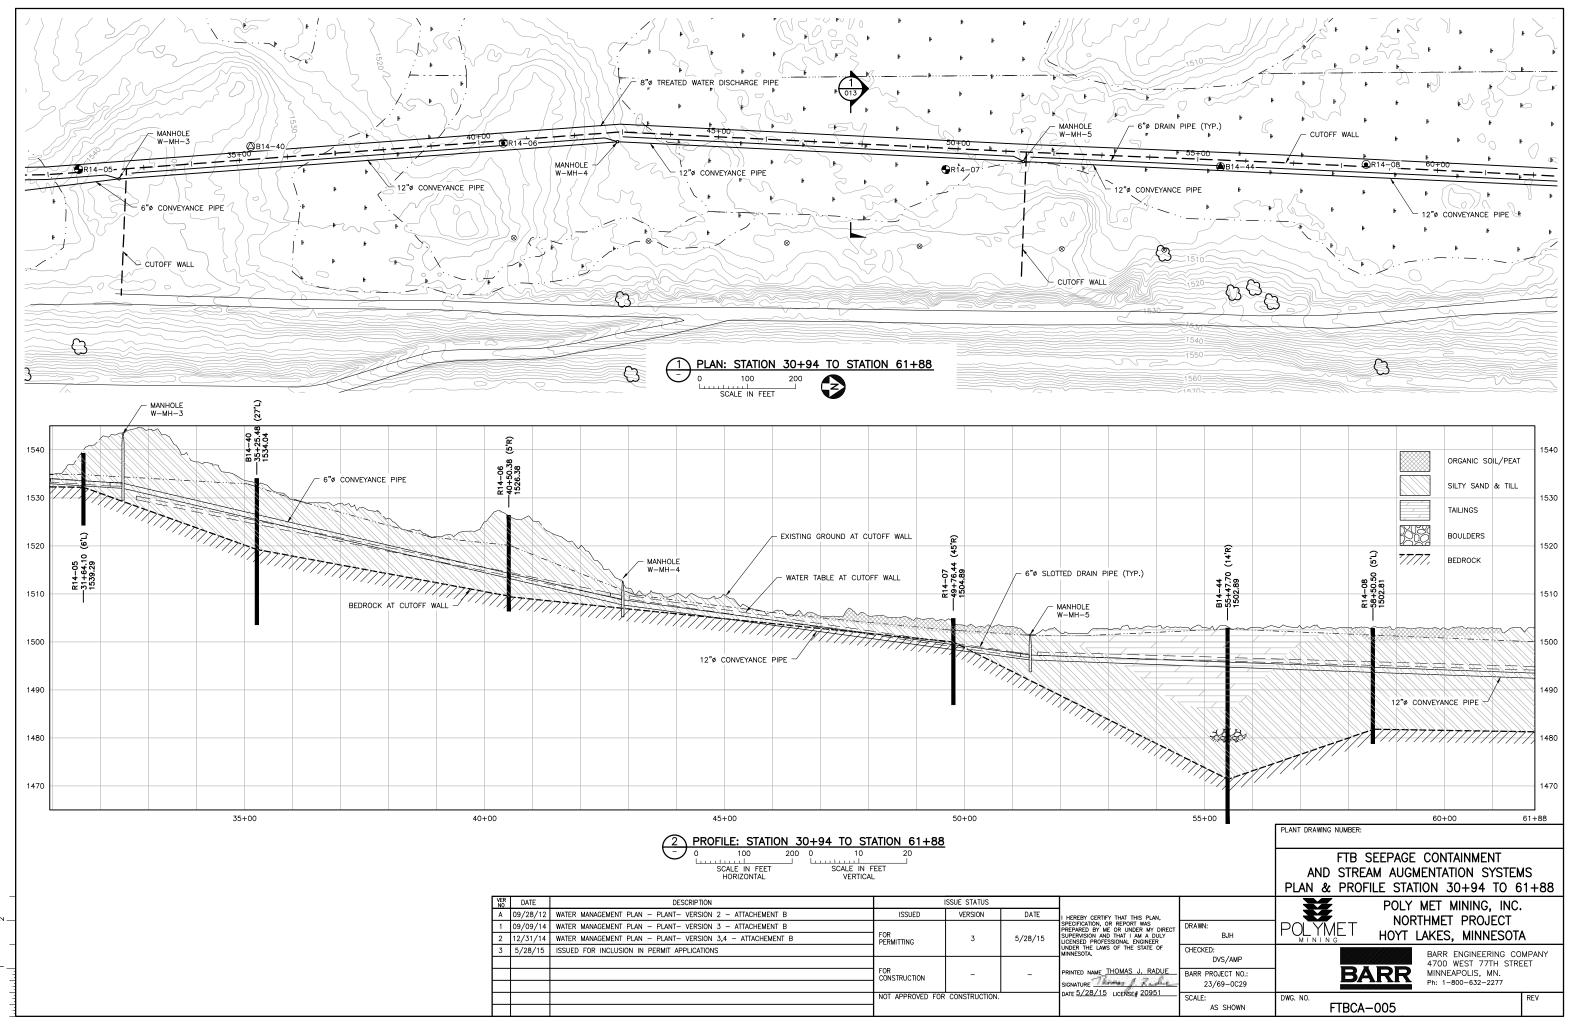
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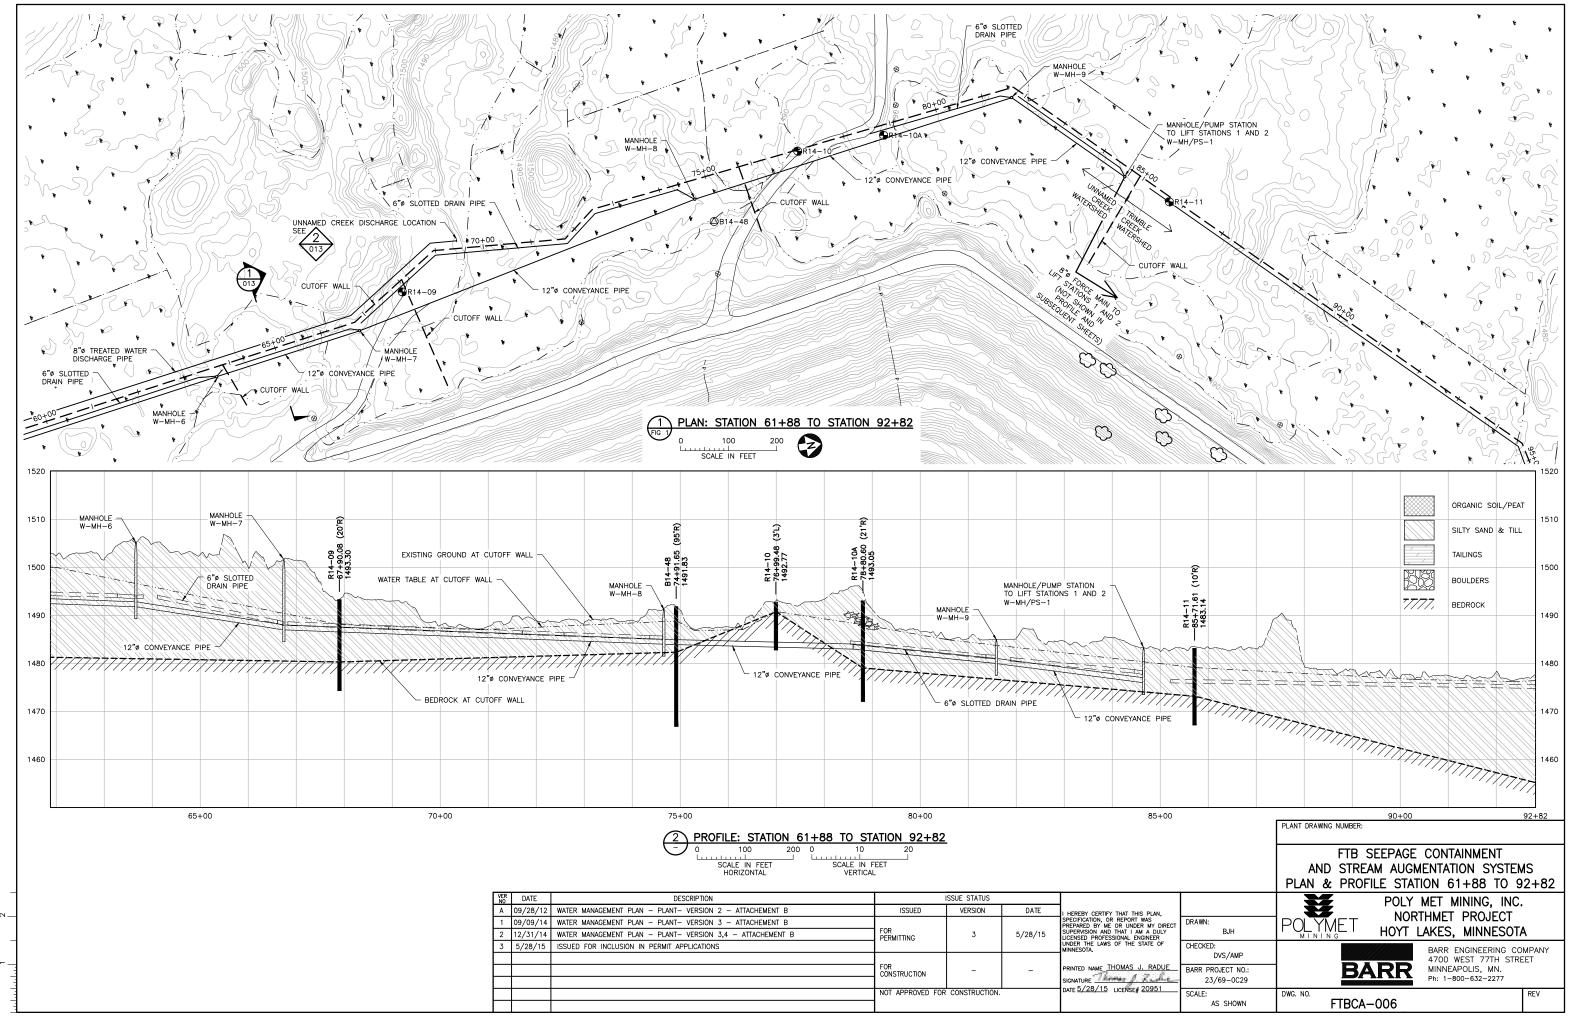
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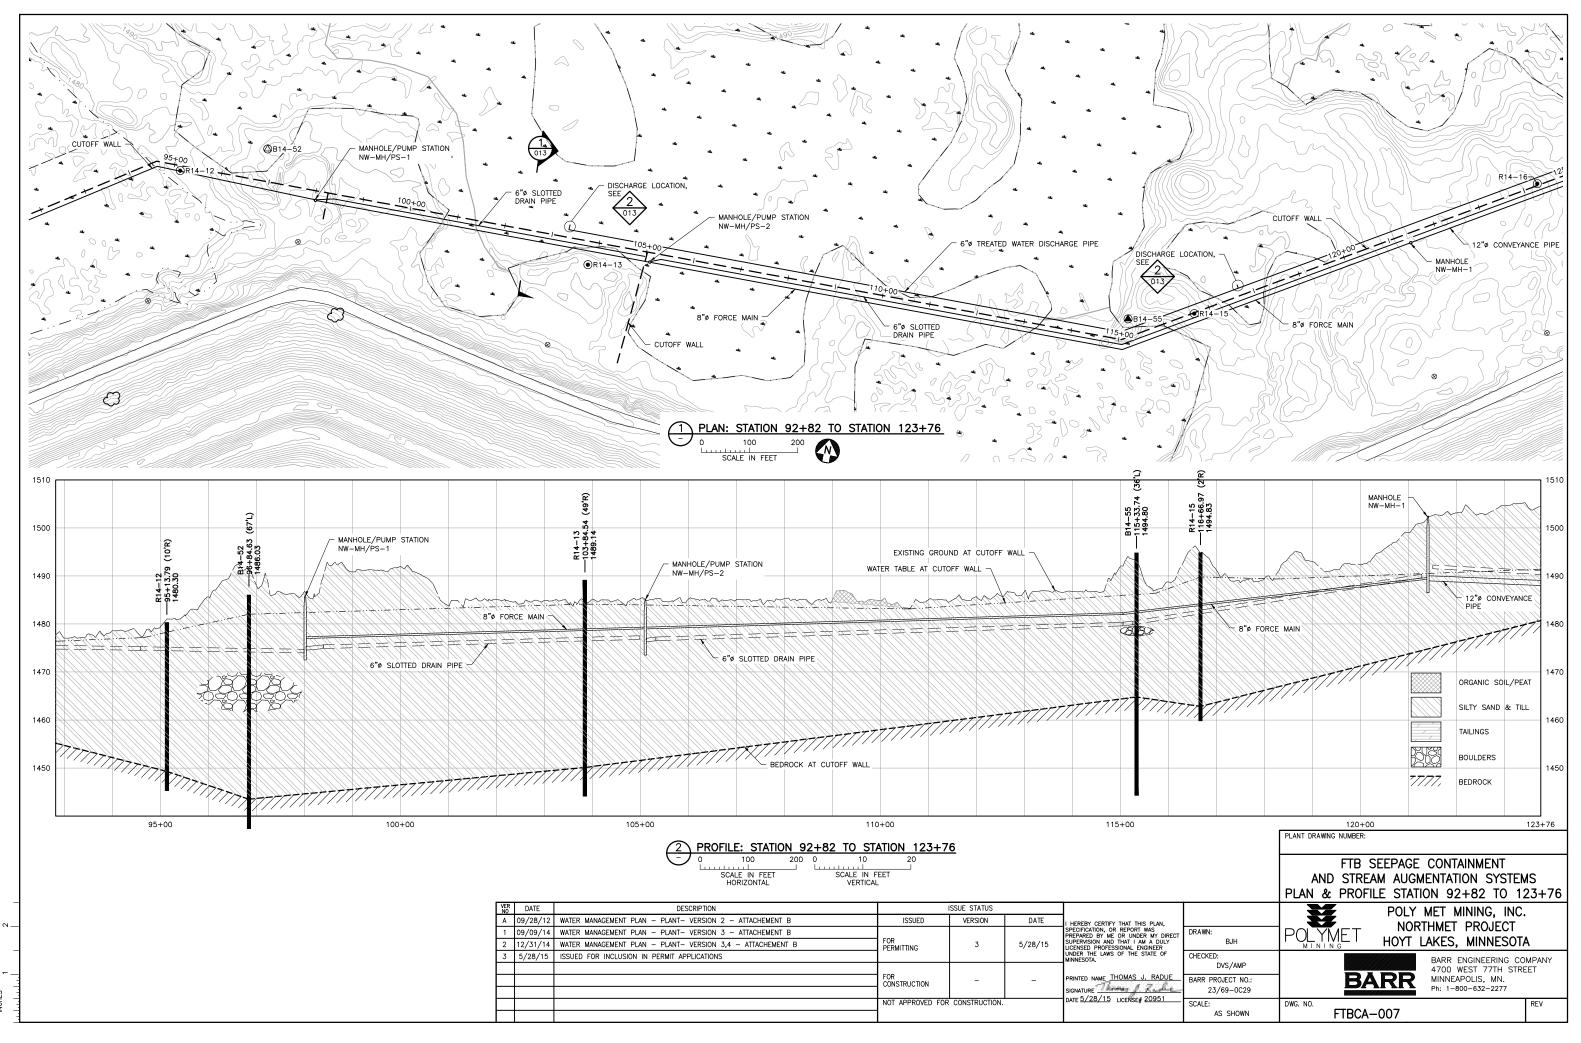


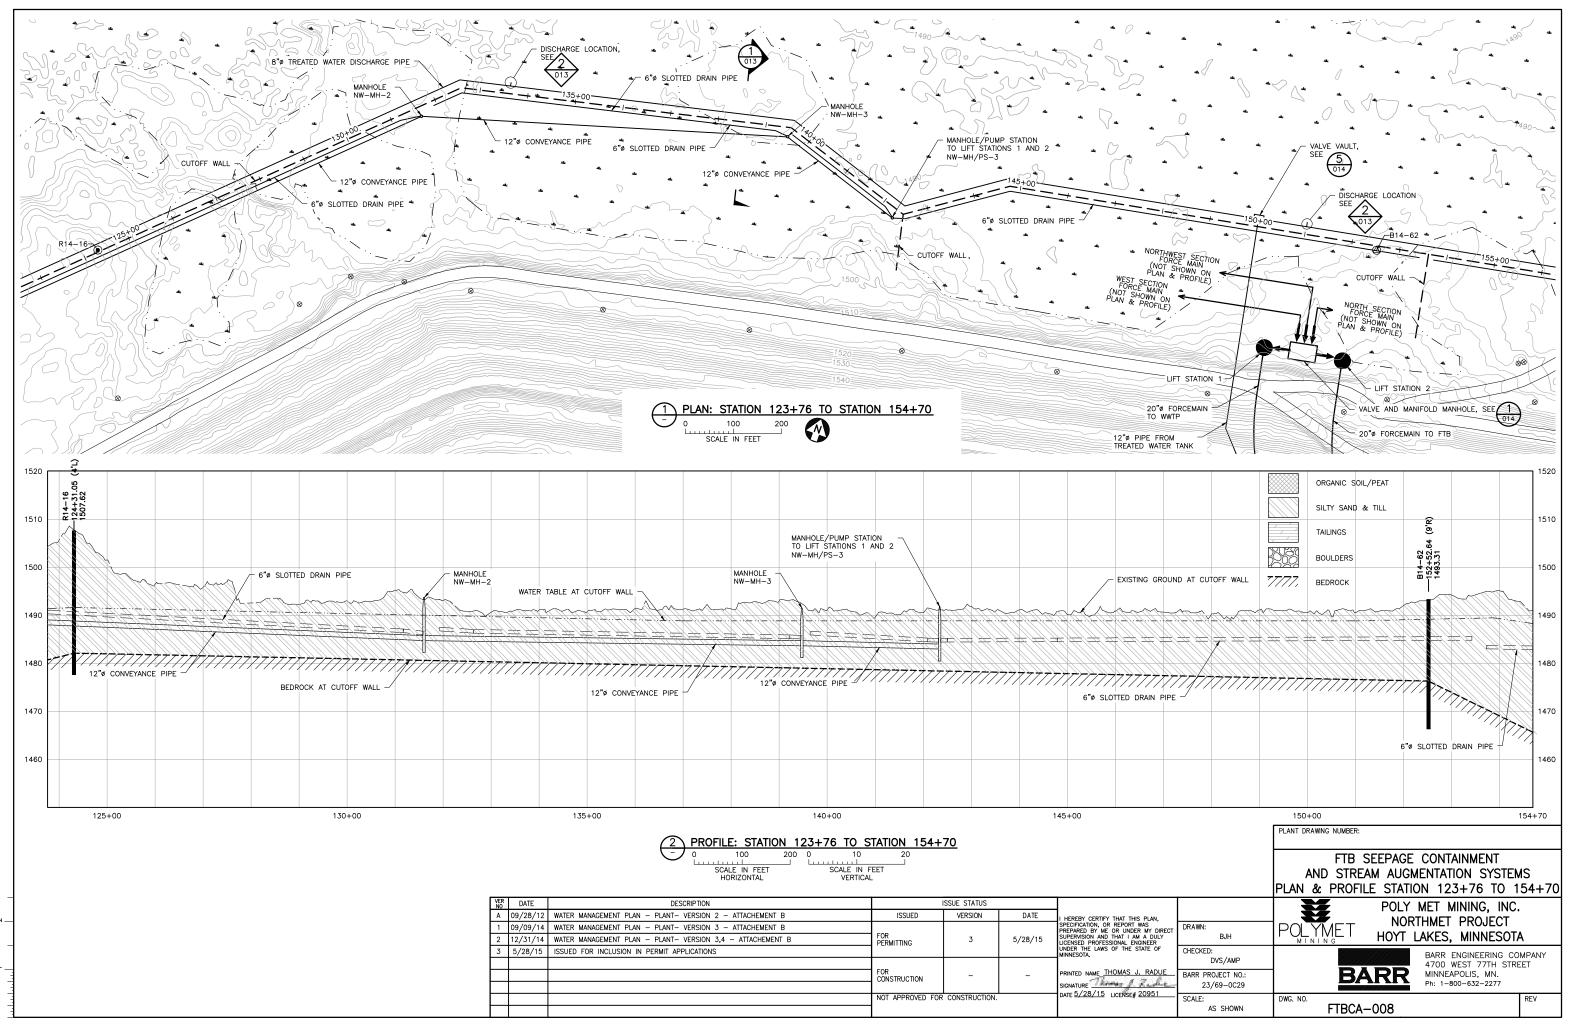


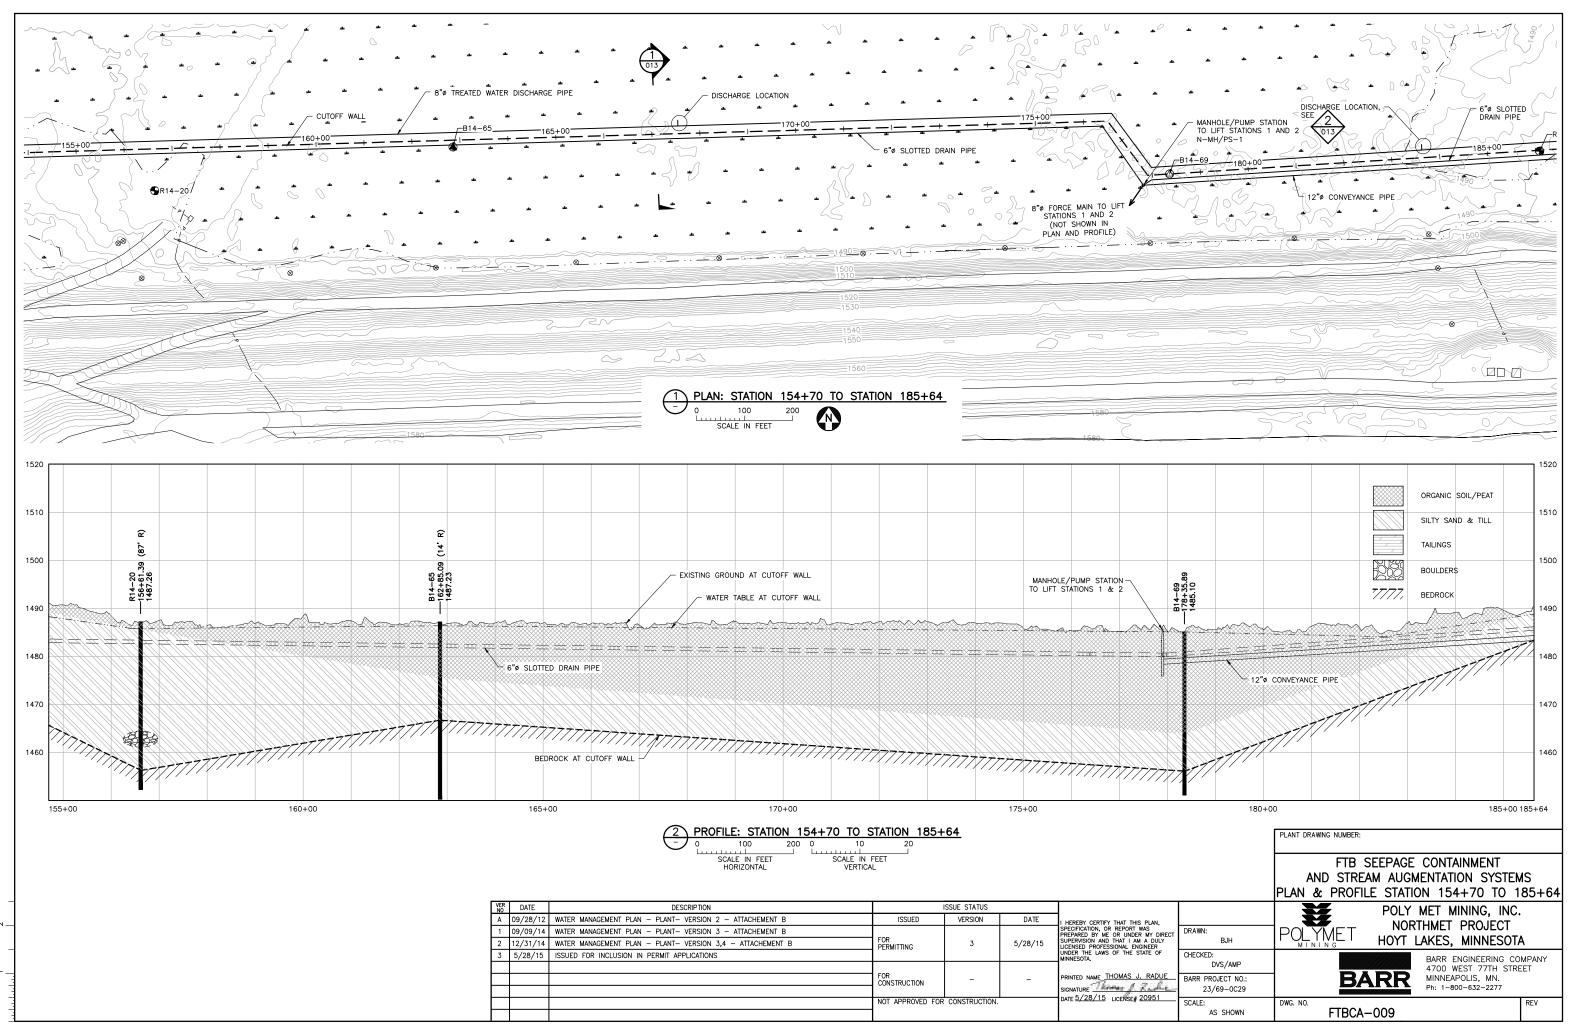




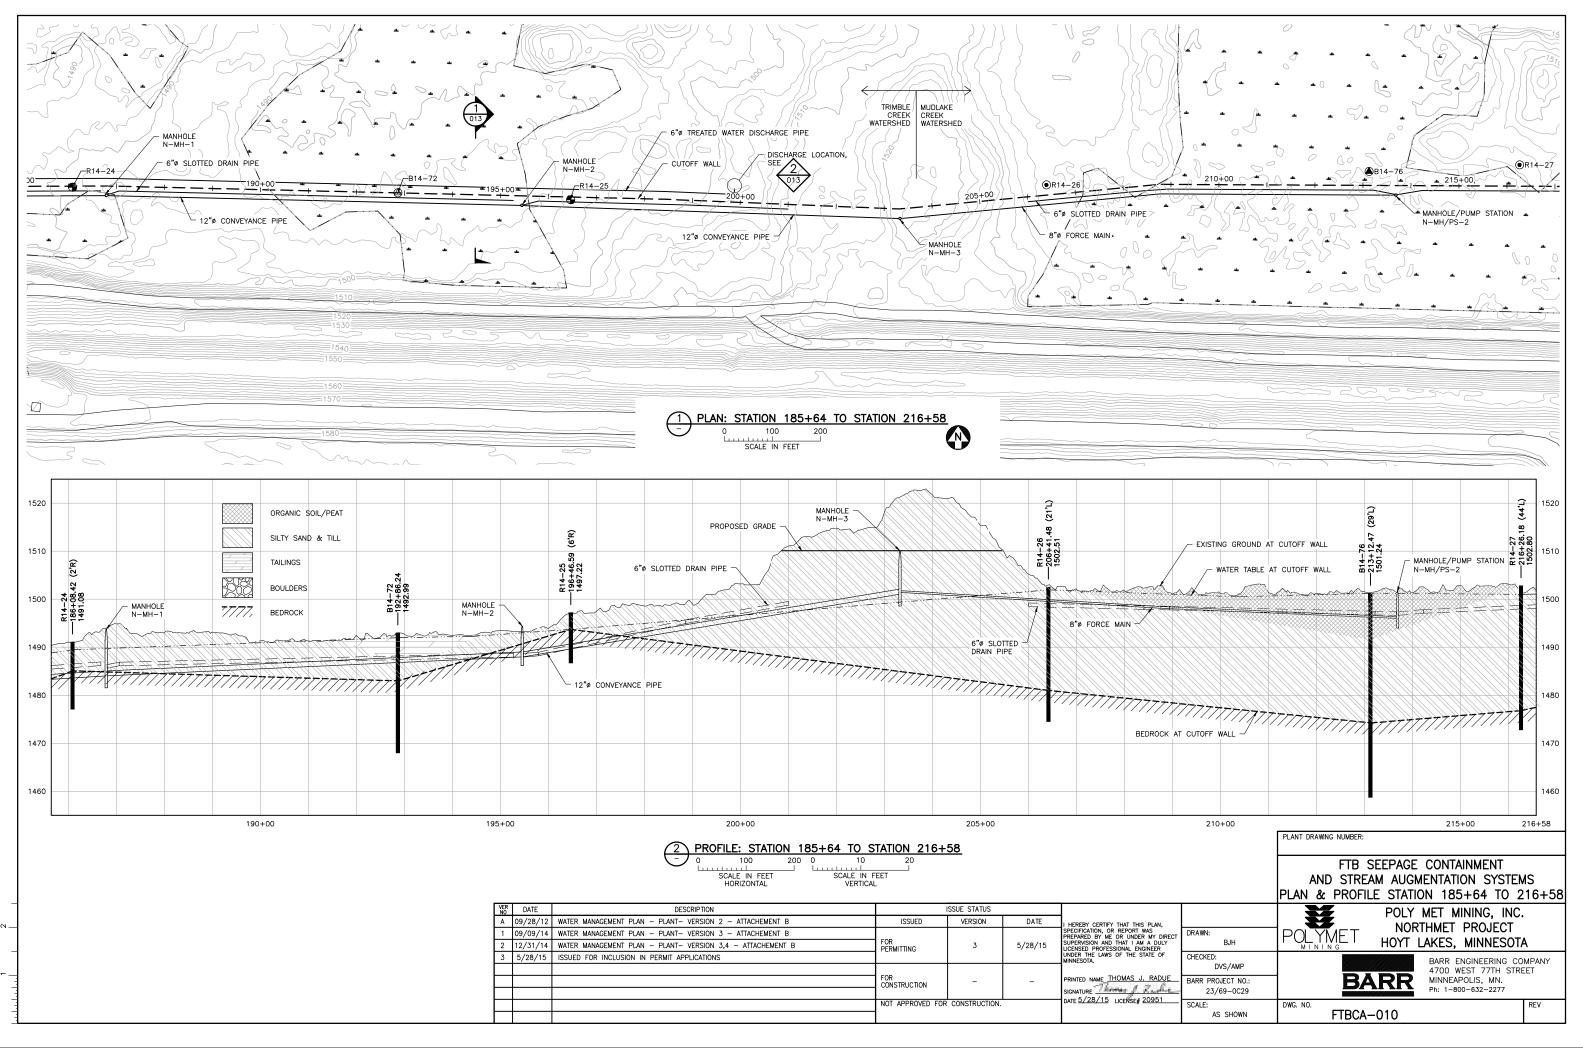


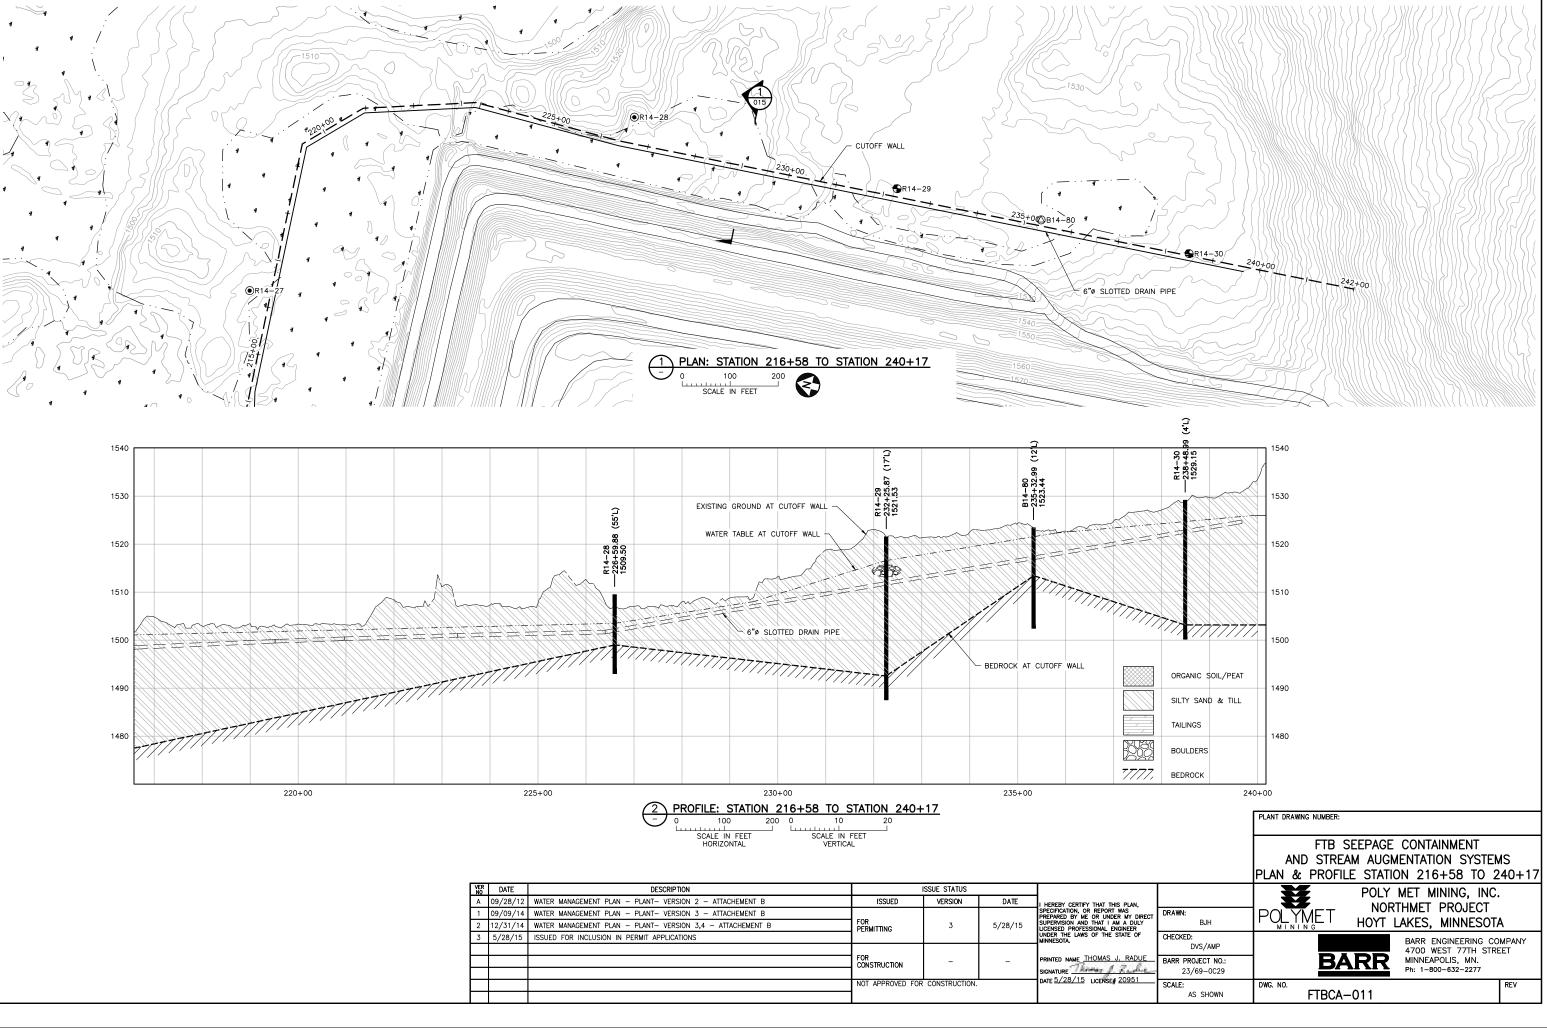






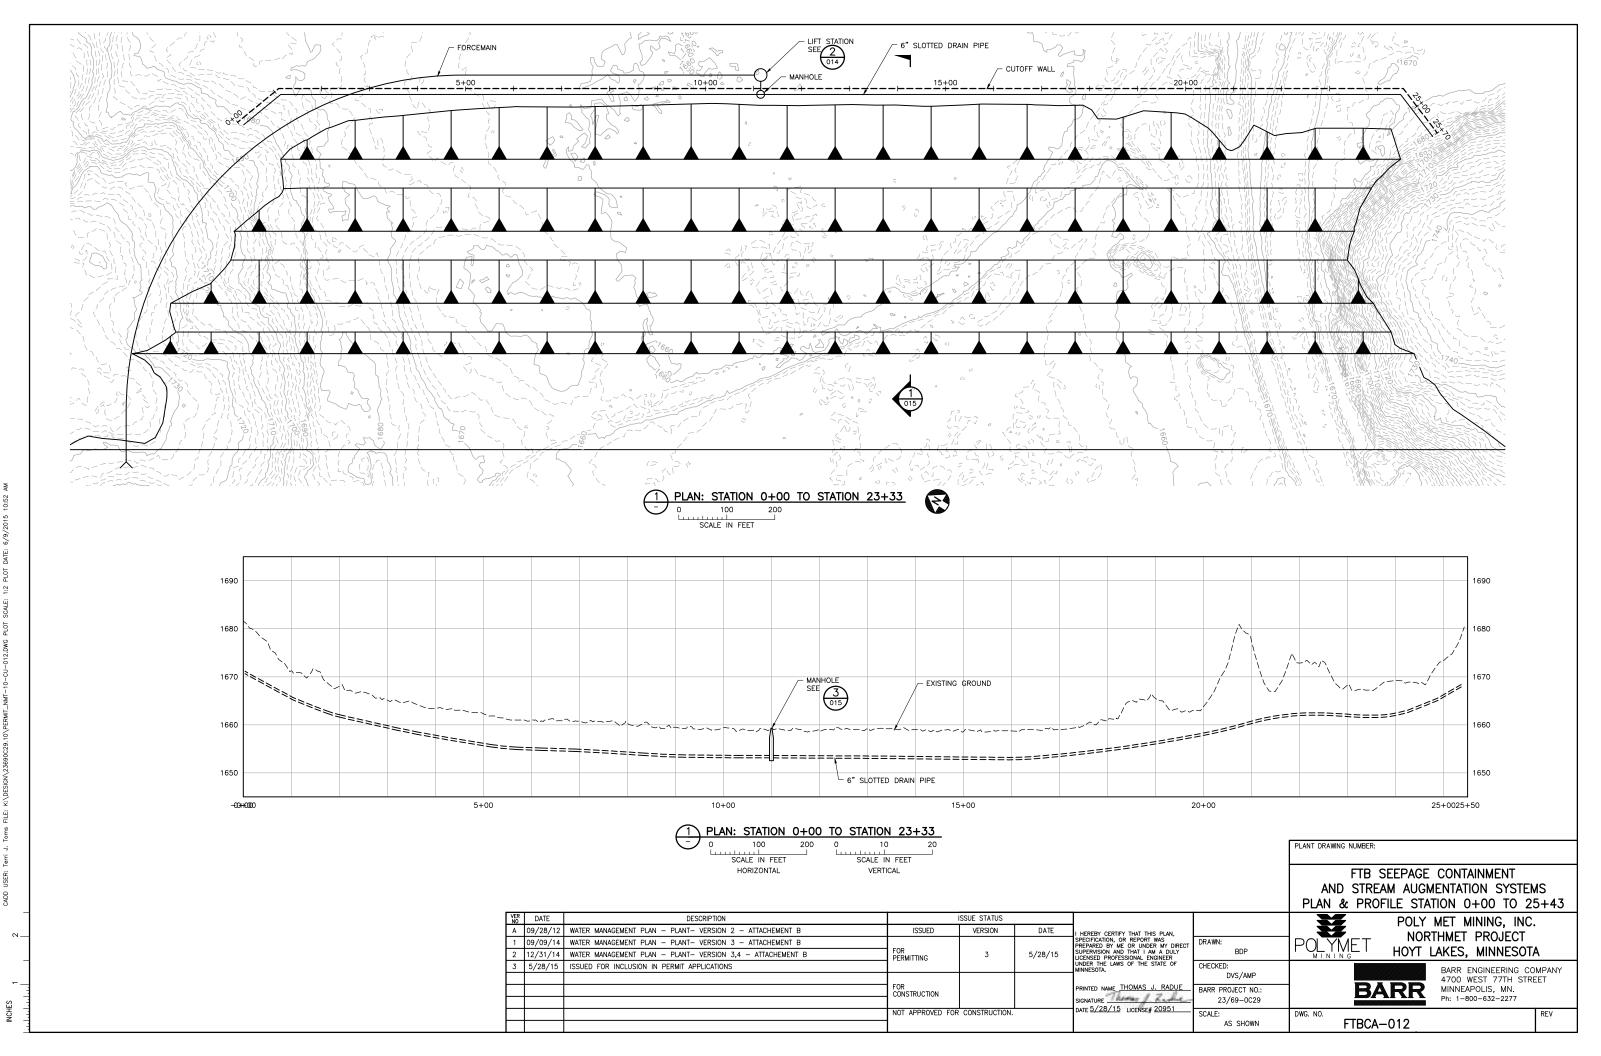
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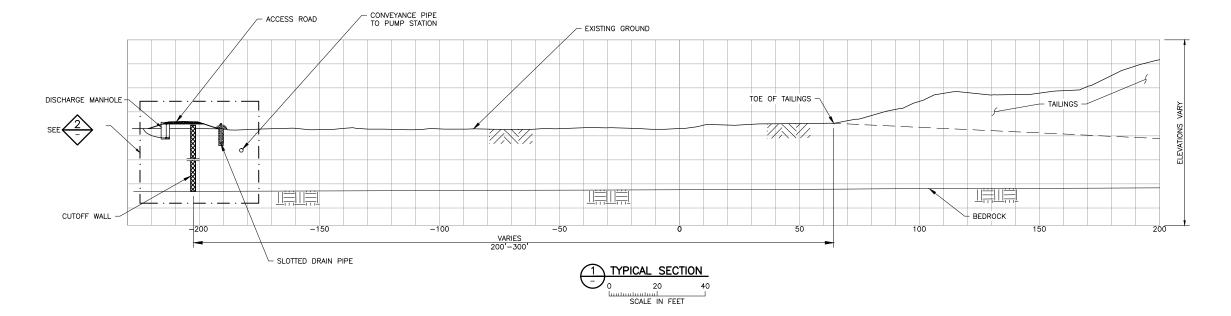





VER NO	DATE	DESCRIPTION		ISSUE STATUS		
Α	09/28/12	WATER MANAGEMENT PLAN - PLANT- VERSION 2 - ATTACHEMENT B	ISSUED	VERSION	DATE	I HEREBY CERTIFY THAT THIS PLAY
1	09/09/14	WATER MANAGEMENT PLAN - PLANT- VERSION 3 - ATTACHEMENT B				SPECIFICATION, OR REPORT WAS PREPARED BY ME OR UNDER MY
2	12/31/14	WATER MANAGEMENT PLAN - PLANT- VERSION 3,4 - ATTACHEMENT B	FOR	3	5/28/15	SUPERVISION AND THAT I AM A DI LICENSED PROFESSIONAL ENGINEER
3	5/28/15	ISSUED FOR INCLUSION IN PERMIT APPLICATIONS				UNDER THE LAWS OF THE STATE
			FOR	-	-	PRINTED NAME THOMAS J. RA
			NOT APPROVED FOR	CONSTRUCTION.		DATE 5/28/15 LICENSE# 2095

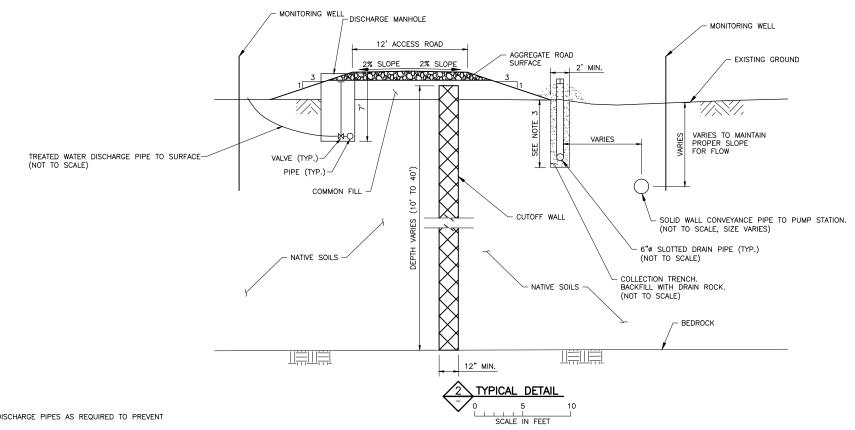INCHES








NOTES:


1. DIFFUSER TO BE INSTALLED ON DISCHARGE PIPES AS REQUIRED TO PREVENT EROSION.

- 2. CUTOFF WALL MAXIMUM DESIGN HYDRAULIC CONDUCTIVITY = 1×10^{-6} CM/SEC
- 3. 7' TYPICAL BUT MAY BE LESS IN AREAS WITH SHALLOW BEDROCK

Γ	ER DATE	DESCRIPTION		ISSUE STATUS		
	A 09/28/1:	WATER MANAGEMENT PLAN - PLANT- VERSION 2 - ATTACHEMENT B	ISSUED	VERSION	DATE	I HEREBY CERTIFY THAT THIS PLAN.
	1 09/09/14	WATER MANAGEMENT PLAN - PLANT- VERSION 3 - ATTACHEMENT B				SPECIFICATION, OR REPORT WAS PREPARED BY ME OR UNDER MY DIRE
	2 12/31/14	WATER MANAGEMENT PLAN - PLANT- VERSION 3,4 - ATTACHEMENT B	FOR PERMITTING	3	5/28/15	SUPERVISION AND THAT I AM A DULY
	3 5/28/15	ISSUED FOR INCLUSION IN PERMIT APPLICATIONS				UNDER THE LAWS OF THE STATE OF MINNESOTA.
			FOR			PRINTED NAME THOMAS J. RADUE
						SIGNATURE
			NOT APPROVED FOR	CONSTRUCTION.		DATE 5/28/15 LICENSE# 20951

		PLANT DRAWING NUMBER:	
		FTB SEEPAGE CONTAINMENT AND STREAM AUGMENTATION SYSTEMS DETAILS	
N, DIRECT DULY FR OF	DRAWN: BDP	POLY MET MINING, INC. NORTHMET PROJECT HOYT LAKES, MINNESOTA	
ADUE	CHECKED: DVS/AMP BARR PROJECT NO.: 23/69-0C29	BARR ENGINEERING COMPAN 4700 WEST 77TH STREET MINNEAPOLIS, MN. Ph: 1-800-632-2277	Ý
51	SCALE: AS SHOWN	TTBCA-013	

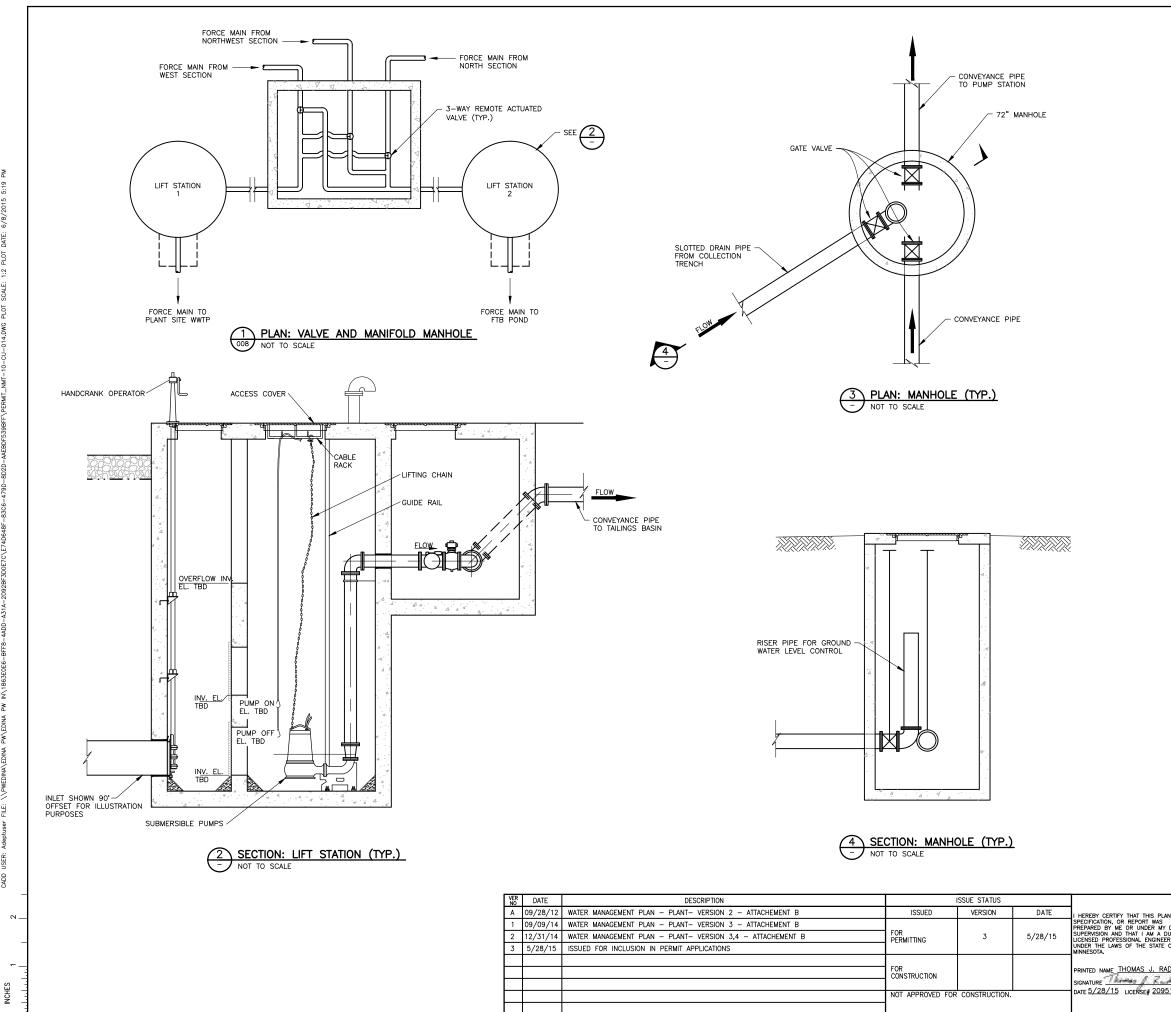


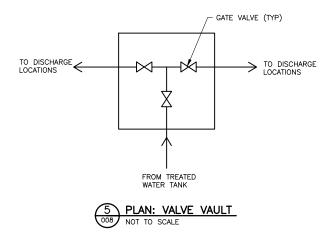



NOTES:

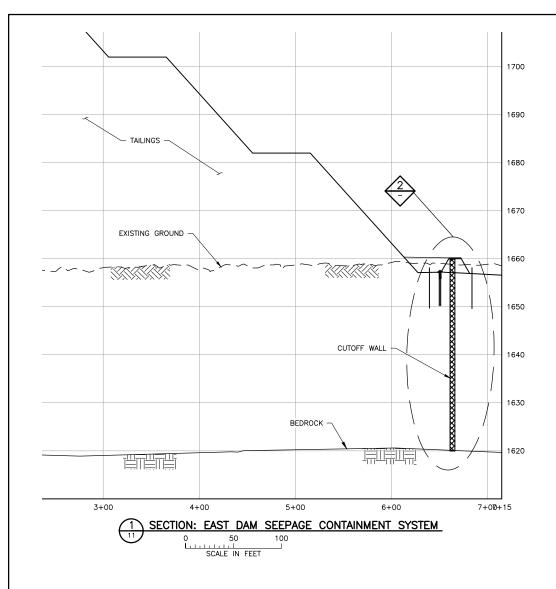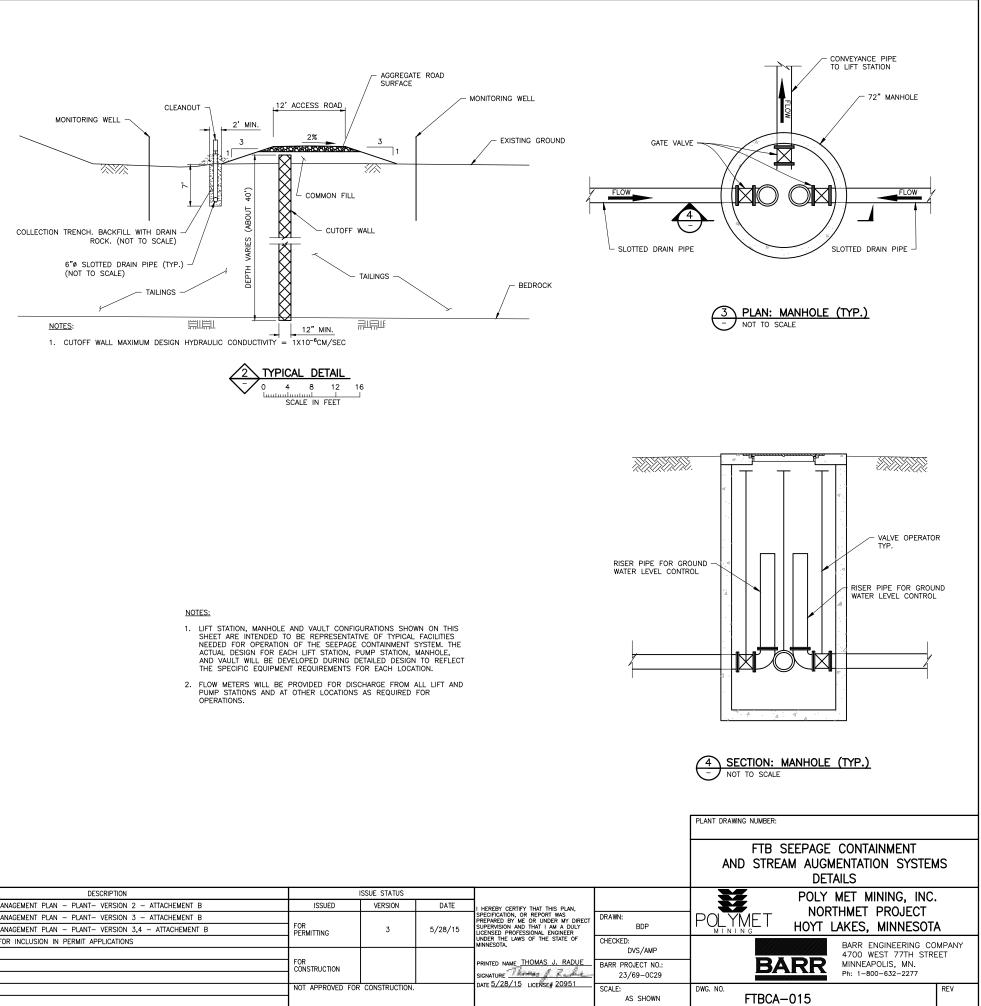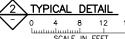- LIFT STATION, MANHOLE AND VAULT CONFIGURATIONS SHOWN ON THIS SHEET ARE INTENDED TO BE REPRESENTATIVE OF TYPICAL FACILITIES NEEDED FOR OPERATION OF THE SEEPAGE CONTAINMENT AND STREAM AUGMENTATION SYSTEMS. THE ACTUAL DESIGN FOR EACH LIFT STATION, PUMP STATION, MANHOLE, AND VAULT WILL BE DEVELOPED DURING DETAILED DESIGN TO REFLECT THE SPECIFIC EQUIPMENT REQUIREMENTS FOR EACH LOCATION FOR EACH LOCATION.
- 2. PUMP STATIONS WILL BE SIMILAR TO MANHOLE SHOWN IN $\overbrace{-}^{3}$ with small submersible pump,
- FLOW METERS WILL BE PROVIDED FOR DISCHARGE FROM ALL LIFT AND PUMP STATIONS AND AT OTHER LOCATIONS AS REQUIRED FOR OPERATIONS.

		PLANT DRAWING NUMBER:				
		FTB SEEPAGE CONTAINMENT AND STREAM AUGMENTATION SYSTEMS DETAILS				
N, DIRECT ULY R OF	DRAWN: BDP	POLY MET MINING, INC. NORTHMET PROJECT HOYT LAKES, MINNESOTA				
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			FOR CONSTRUCTION			PRINTED NAME THOMAS J. RADUE
						SIGNATURE 7
			NOT APPROVED FOR CONSTRUCTION.		DATE <u>5/28/15</u> LICENSE# <u>20951</u>	