Appendix 4 Categories 1, 2/3, and 4 Stockpiles and Ore Surge Pile Design and Category 1 Stockpile Groundwater Containment System Permit Application Support Drawings

#### **Errata Sheet**

Poly Met Mining, Inc. NorthMet Project

Permit Application Support Drawings: Categories 1, 2/3, and 4 Stockpiles and Ore Surge Pile Design

July 2016 (version 2)


Engineering design is currently in progress. The table below lists changes that have been identified to-date and have not yet been incorporated in the attached permit application support drawings within this set. Final design will incorporate these changes along with additional site-specific information (e.g., supplementary geotechnical data); therefore, additional adjustments may be made during final design that will be incorporated into the final design drawing set.

Drawing Sheet(s)	Change
Global change to all sheets, as needed	The terminology "mine drainage" as noted in these drawings will be changed to "mine water".

# POLY MET MINING, INC. NORTHMET PROJECT PERMIT APPLICATION SUPPORT DRAWINGS CATEGORIES 1, 2/3, AND 4 STOCKPILES

# AND ORE SURGE PILE DESIGN HOYT LAKES, MINNESOTA

		DRAWING LIST				
SHEET NUMBER	REVISION	SHEET TITLE				
SKP-001	E	TITLE SHEET AND LOCATION MAP				
SKP-002	E	LEGEND, GENERAL NOTES AND SPECIFICATIONS				
SKP-003	E	STOCKPILE LAYOUTS - MINE YEAR 1 LIMITS				
SKP-004	E	STOCKPILE LAYOUTS - MINE YEAR 2 LIMITS				
SKP-005	E	STOCKPILE LAYOUTS - MINE YEAR 11 LIMITS				
SKP-006	E	STOCKPILE LAYOUTS - MINE YEAR 21 LIMITS CLOSURE CONFIGURATION				
SKP-007	E	EXISTING SITE CONDITIONS				
SKP-008	E	SITE LAYOUT AND LOCATION OF FIELD INVESTIGATIONS				
SKP-009	E	DEPTH TO BEDROCK ISOPACH MAP				
SKP-010	E	CATEGORY 1 STOCKPILE SUBGRADE EXCAVATION PLAN				
SKP-011	E	CATEGORY 1 STOCKPILE MINE YEAR 1 CONTINGENCY CLOSURE CONFIGURATION				
SKP-012	E	CATEGORY 1 STOCKPILE FINAL GRADES AND SUB-BASIN DELINEATION				
SKP-013	E	CATEGORY 1 STOCKPILE DESIGN SECTIONS				
SKP-014	E	CATEGORY 2/3 STOCKPILE SUBGRADE EXCAVATION PLAN				
SKP-015	E	CATEGORY 2/3 STOCKPILE FOUNDATION GRADING PLAN - MINE YEAR 1 AND MAXIMUM				
SKP-016	E	CATEGORY 2/3 STOCKPILE UNDERDRAIN PIPING PLAN - MINE YEAR 1 AND MAXIMUM				
SKP-017	E	CATEGORY 2/3 STOCKPILE OVERLINER DRAINAGE PIPING PLAN - MINE YEAR 1 AND MAXIMUM				
SKP-018	E	CATEGORY 2/3 STOCKPILE MAXIMUM CAPACITY CONFIGURATION				
SKP-019	E	CATEGORY 2/3 STOCKPILE DESIGN SECTIONS				
SKP-020	E	CATEGORY 4 STOCKPILE SUBGRADE EXCAVATION PLAN				
SKP-021	E	CATEGORY 4 STOCKPILE FOUNDATION GRADING PLAN - MINE YEAR 1 AND MAXIMUM				
SKP-022	E	CATEGORY 4 STOCKPILE UNDERDRAIN PIPING PLAN - MINE YEAR 1 AND MAXIMUM				
SKP-023	E	CATEGORY 4 STOCKPILE OVERLINER DRAINAGE PIPING PLAN - MINE YEAR 1 AND MAXIMUM				
SKP-024	E	CATEGORY 4 STOCKPILE MAXIMUM CAPACITY CONFIGURATION				
SKP-025	E	CATEGORY 4 STOCKPILE DESIGN SECTIONS				
SKP-026	E	ORE SURGE PILE SUBGRADE EXCAVATION PLAN				
SKP-027	E	ORE SURGE PILE FOUNDATION GRADING PLAN				
SKP-028	E	ORE SURGE PILE UNDERDRAIN PIPING PLAN				
SKP-029	E	ORE SURGE PILE OVERLINER DRAINAGE PIPING PLAN				
SKP-030	E	ORE SURGE PILE TYPICAL CONFIGURATION				
SKP-031	E	ORE SURGE PILE DESIGN SECTIONS				
SKP-032	E	CATEGORY 1 STOCKPILE RECLAMATION AND OPERATIONS SURFACE WATER - MANAGEMENT DETAILS - SHEET 1 OF				
SKP-033	E	CATEGORY 1 STOCKPILE RECLAMATION AND OPERATIONS SURFACE WATER - MANAGEMENT DETAILS - SHEET 2 OF				
SKP-034	E	CATEGORY 1 STOCKPILE PHASED COVER DESIGN				
SKP-035	E	CONSTRUCTION DETAILS				

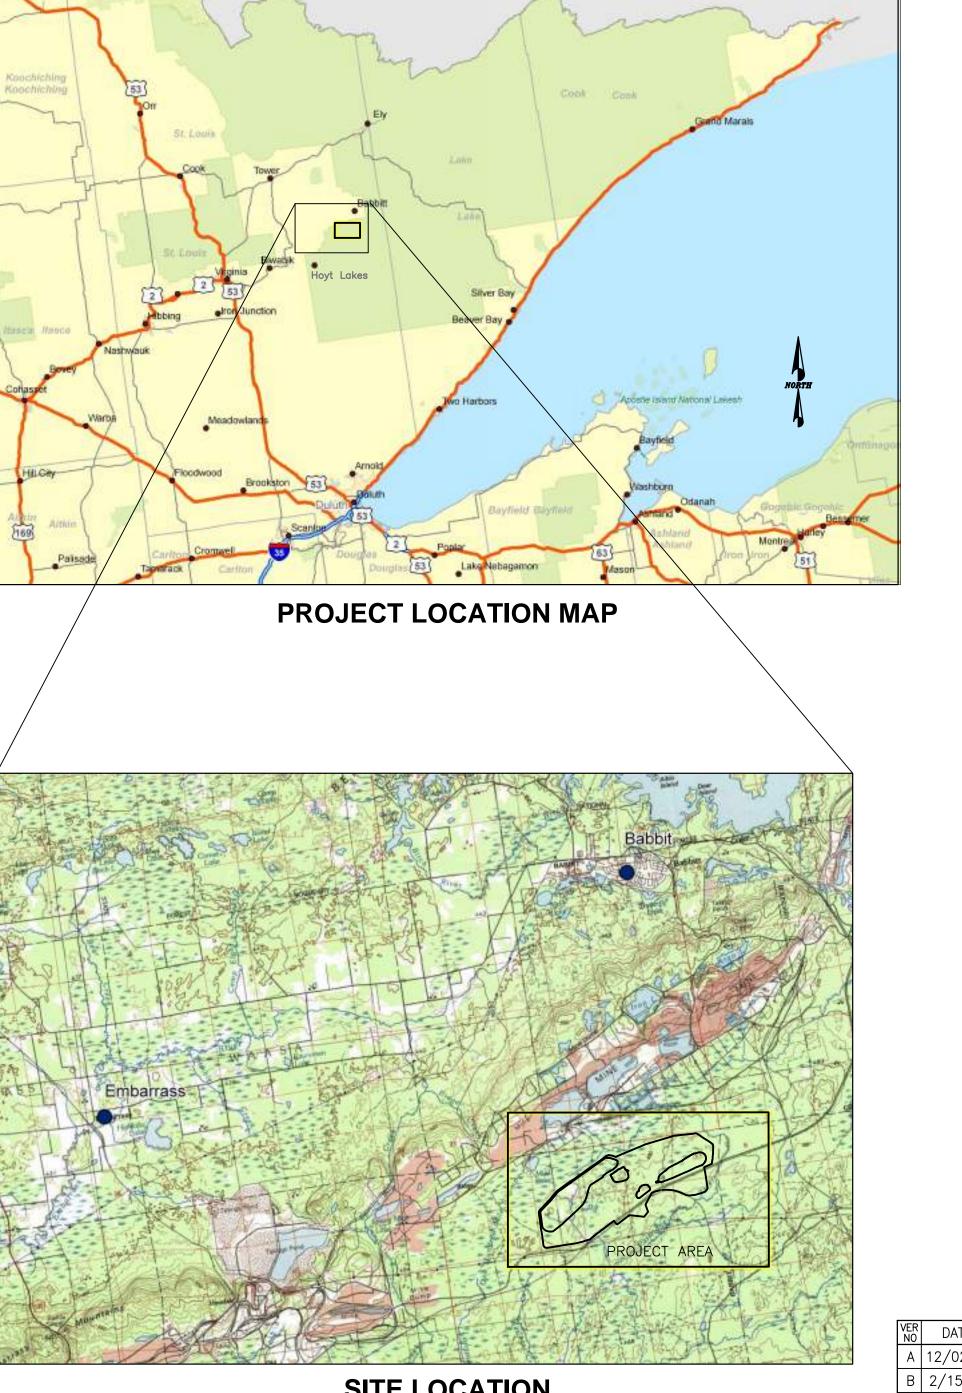

**SITE LOCATION** 

							IIILE SHI	EET AND LOCATION MAP
VER DATE	DESCRIPTION	I	SSUE STATUS				*	POLY MET MINING, INC.
A 12/02/11 ISSU	UED FOR REVIEW FOR INCLUSION IN ROCK AND OVERBURDEN MANAGEMENT PLAN (ROMP)	ISSUED	VERSION	DATE	I HEREBY CERTIFY THAT THIS PLAN,			NORTHMET PROJECT
B 2/15/13 ISSU	UED FOR REVIEW FOR INCLUSION IN ROMP				SPECIFICATION, OR REPORT WAS PREPARED BY ME OR UNDER MY DIRECT	DRAWN:		
C 5/29/13 ISSU	UED FOR REVIEW FOR INCLUSION IN ROMP	☐ FOR ☐ PERMITTING	F	5-22-15	SUPERVISION AND THAT I AM A DULY LICENSED PROFESSIONAL ENGINEER	MTM	MINING	HOYT LAKES, MINNESOTA
D 1/14/14 ISSU	UED FOR AGENCY REVIEW	TERMITTING			UNDER THE LAWS OF THE STATE OF MINNESOTA.	CHECKED:		GOLDER ASSOCIATES INC.
E 4/10/15 ISSU	UED FOR INCLUSION IN PERMIT APPLICATIONS				11	77		44 UNION BOULEVARD, SUITE 300 LAKEWOOD, CO USA 80233
F 5/22/15 ISSU	UED FOR INCLUSION IN PERMIT APPLICATIONS	FOR CONSTRUCTION			SIGNATURE	- GOLDER PROJECT NO.:	Golde	Ph: (303) 980-0540
					PRINTED NAME BRENT R. BRONSON	113-2209	Associa	Fax: (303) 985-2080 www.golder.com
		NOT APPROVED FOR	CONSTRUCTION.	1	DATE <u>5/22/15</u> LICENSE # 46492	SCALE:	DWG. NO.	REV

PLANT DRAWING NUMBER:

MAJOR FEATURE

EXISTING GROUND TOPOGRAPHY (SEE NOTE 2)

PROPOSED FINISHED GRADE TOPOGRAPHY

SLOPE DIRECTION

- CROSS SECTION IDENTIFIER

SHEET WHERE SECTION IS LOCATED SLOPE

HAUL ROADS MINE SITE BOUNDARY

PIT BOUNDARY

 MINE YEAR 1 ORE, WASTE ROCK STOCKPILE LIMITS — — — — MAXIMUM ORE, WASTE ROCK STOCKPILE LIMITS

GEOMEMBRANE BARRIER LAYER

PREPARED SUBGRADE

SOIL LINER 2

SOIL LINER 1

WASTE ROCK OR ORE STRUCTURAL FILL

GRANULAR DRAINAGE MATERIAL 1

DRAIN ROCK

RANDOM FILL

RIPRAP

COMMON FILL 1

OVERBURDEN MATERIAL

VERTICAL PERCOLATION LAYER (USCS - ML)

LATERAL DRAINAGE LAYER (USCS - SP OR SM)

TERTIARY COLLECTION PIPING

4-INCH

10-INCH 12-INCH

PRIMARY AND SECONDARY COLLECTION PIPING

\_\_\_\_\_ 4-INCH 6-INCH \_\_\_\_\_ 8-INCH

GATP-06-7-GOLDER ASSOC. TEST PIT (2006)

BARR ENGINEERING BOREHOLES (2008) RS-11-

BARR ENGINEERING BOREHOLES (2005)

AMERICAN ENGINEERING TESTING, INC. BOREHOLES (2010)

SHALLOW MARSH

CONIFEROUS SWAMP HARDWOOD SWAMP

SB-05-01

CONIFEROUS BOG

SHRUB SWAMP



SEDGE MEADOW

OPEN BOG

#### LIST OF ABBREVIATIONS

ABOVE MEAN SEA LEVEL CUBIC YARD CY DIAMETER DIA. ELEVATION **EVAPOTRANSPIRATION** FEET HIGH DENSITY POLYETHYLENE

INSIDE DIAMETER LINEAR LOW DENSITY POLYETHYLENE LEAK COLLECTION AND RECOVERY SYSTEM LCRS

MAX. MAXIMUM MIN. MINIMUM N.T.S. NOT TO SCALE OUTSIDE DIAMETER OD

SQUARE YARD TYP. **TYPICAL** ROMP ROCK AND OVERBURDEN MANAGEMENT PLAN USCS UNIFIED SOIL CLASSIFICATION SYSTEM PERFORATED CORRUGATED POLYETHYLENE CPEP

#### **GENERAL NOTES:**

- THIS DRAWING SET REPRESENTS THE DESIGN FOR PERMITTING FOR CATEGORY 1 STOCKPILE, CATEGORY 2/3 STOCKPILE. CATEGORY 4 STOCKPILE AND ORE SURGE PILE FOR THE POLYMET NORTHMET PROJECT IN HOYT LAKES, MINNESOTA, PREPARED IN SUPPORT OF A PERMIT TO MINE. THE DRAWING SET ONLY INCLUDES INFRASTRUCTURE ASSOCIATED WITH THE MOVEMENT OF ROCK (STOCKPILES, PITS, HAUL ROADS, AND RAIL TRANSFER HOPPER) AND NOT OTHER SUPPORT FACILITIES.
- 2. BASE TOPOGRAPHY PROVIDED BY BARR ENGINEERING IN AUGUST 2011.
- 3. GOLDER ASSOCIATES INC. (GOLDER) IS RESPONSIBLE FOR STOCKPILE DESIGNS WITH BATTERY LIMITS DEFINED BY THE PERIMETER/LINER BERMS AND THE UNDERDRAIN SUMPS.
- 4. AT THE BASIC ENGINEERING LEVEL, LIMITED GEOTECHNICAL DATA EXISTS, PARTICULARLY IN LOWLAND AREAS. ADDITIONAL DATA WILL BE OBTAINED FROM THESE AREAS AFTER THE PERMIT TO MINE IS APPROVED. SUBGRADE EXCAVATION PLANS WERE DEVELOPED USING AVAILABLE INFORMATION, AND WILL BE UPDATED FOR FINAL DESIGN BASED ON RESULTS OF PHASE II GEOTECHNICAL INVESTIGATION.
- 5. EARTHWORK QUANTITIES BASED ON NEAT LINE (I.E., NET CUT/ FILL SHRINKAGE FACTOR = 1.0).
- PREPARED SUBGRADE, AS DEFINED ON THE DRAWINGS, INCLUDES CLEARING, GRUBBING, TOPSOIL REMOVAL, REMOVAL OF GEOTECHNICALLY-UNSUITABLE MATERIALS, MOISTURE CONDITIONING, AND SUBGRADE COMPACTION AS DEFINED IN THE SPECIFICATIONS.
- 7. FOUNDATION PREPARATION ASSUMES THE FOLLOWING GENERAL CONSTRUCTION SEQUENCE: (I) EXCAVATE TO BEDROCK WITHIN LOWLAND AREAS ASSUMING A MAXIMUM DEPTH OF OVER-EXCAVATION OF 20 FEET, OR UNTIL REACHING GEOTECHNICALLY-SUITABLE FOUNDATION SOILS AS DETERMINED BY THE PHASE II GEOTECHNICAL INVESTIGATION. STOCKPILE ORGANIC SOILS AND TILL MATERIAL SEPARATELY FOR FUTURE USE AS RECLAMATION SOILS AND STRUCTURAL FILL; (II) PLACE STRUCTURAL FILL AS REQUIRED TO MEET THE FOUNDATION GRADE REQUIREMENTS WITH GRANULAR SOILS, E.G., CATEGORY 1 WASTE ROCK MATERIAL; (III) ESTABLISH FOUNDATION DRAINAGE AS REQUIRED TO PREVENT EXCESS PORE PRESSURES DURING OPERATION; AND (IV) CONSTRUCT LINER SYSTEM DEPENDENT UPON THE REACTIVITY CATEGORY OF THE STOCKPILE MATERIAL.
- AREAS WITH UNSUITABLE SOILS (LOWLAND AREAS) ARE ASSUMED TO COINCIDE WITH THE PREVIOUSLY IDENTIFIED WETLAND AREAS. HORIZONTAL AND VERTICAL EXTENTS OF LOWLAND AREAS ARE EXPECTED TO BE REVISED BASED ON RESULTS OF PHASE II GEOTECHNICAL INVESTIGATION.
- 9. POST-CONSOLIDATION STOCKPILE SETTLEMENTS WERE ESTIMATED BASED ON LIMITED INFORMATION ON THE CONSOLIDATION PROPERTIES OF SUBGRADE MATERIALS. HENCE, FOUNDATION EXCAVATION AND GRADING PLANS ARE ANTICIPATED TO UNDERGO MINOR MODIFICATIONS BASED ON THE RESULTS OF THE PHASE II GEOTECHNICAL INVESTIGATION TO ENSURE SUFFICIENT DRAINAGE.
- 10. CATEGORY 1 WASTE ROCK STOCKPILE WILL BE RECLAIMED BY PLACEMENT OF A GEOMEMBRANE COVER AT CLOSURE. PRIOR TO CLOSURE, WASTE ROCK CATEGORY 2, 3 AND 4 WILL BE USED TO BACKFILL EAST PIT.
- 11. LIMITS OF DISTURBANCE (I.E., CLEARING LIMITS) ASSUMED TO BE 40 FEET FROM THE FACILITY

#### **SPECIFICATIONS:**

- 1. FOR EARTHWORKS COMPONENTS OF THE STOCKPILE DESIGN, REFER TO SECTION 2300 OF THE PROJECT SPECIFICATIONS.
- 2. FOR GEOSYNTHETIC AND PIPING COMPONENTS OF THE STOCKPILE DESIGN, REFER TO SECTION 2272 FOR GEOTEXTILE, 2273 FOR POLYETHYLENE GEOMEMBRANE LINERS, AND SECTION 2610

DATE <u>5/22/15</u> LICENSE # 46492

- 3. QUALITY ASSURANCE REQUIREMENTS FOR STOCKPILE CONSTRUCTION ARE DEFINED IN THE CONSTRUCTION QUALITY ASSURANCE PLAN.
- 4. SPECIFICATION SECTION NUMBERING IS PRELIMINARY.

PLANT DRAWING NUMBER:

SKP-002

LEGEND, GENERAL NOTES AND SPECIFICATIONS

ISSUE STATUS DATE DESCRIPTION A 12/02/11 ISSUED FOR REVIEW FOR INCLUSION IN ROCK AND OVERBURDEN MANAGEMENT PLAN (ROMP) ISSUED VERSION DATE HEREBY CERTIFY THAT THIS PLAN, SPECIFICATION, OR REPORT WAS
PREPARED BY ME OR UNDER MY DIRECT B 2/15/13 ISSUED FOR REVIEW FOR INCLUSION IN ROMP SUPERVISION AND THAT I AM A DULY LICENSED PROFESSIONAL ENGINEER C 5/29/13 ISSUED FOR REVIEW FOR INCLUSION IN ROMP PERMITTING JNDER THE LAWS OF THE STATE OF D 1/14/14 ISSUED FOR AGENCY REVIEW MINNESOTA. E 4/10/15 ISSUED FOR INCLUSION IN PERMIT APPLICATIONS SIGNATURE Honson F | 5/22/15 | ISSUED FOR INCLUSION IN PERMIT APPLICATIONS

CONSTRUCTION

NOT APPROVED FOR CONSTRUCTION.

DRAWN: MTM CHECKED: GOLDER PROJECT NO.: PRINTED NAME BRENT R. BRONSON 113-2209

AS SHOWN

SCALE:


POLYMET Golder Associates


DWG. NO.


芸 POLY MET MINING, INC. NORTHMET PROJECT HOYT LAKES, MINNESOTA GOLDER ASSOCIATES INC.


44 UNION BOULEVARD, SUITE 300 LAKEWOOD, CO USA 80233 Ph: (303) 980-0540 Fax: (303) 985-2080


www.golder.com REV

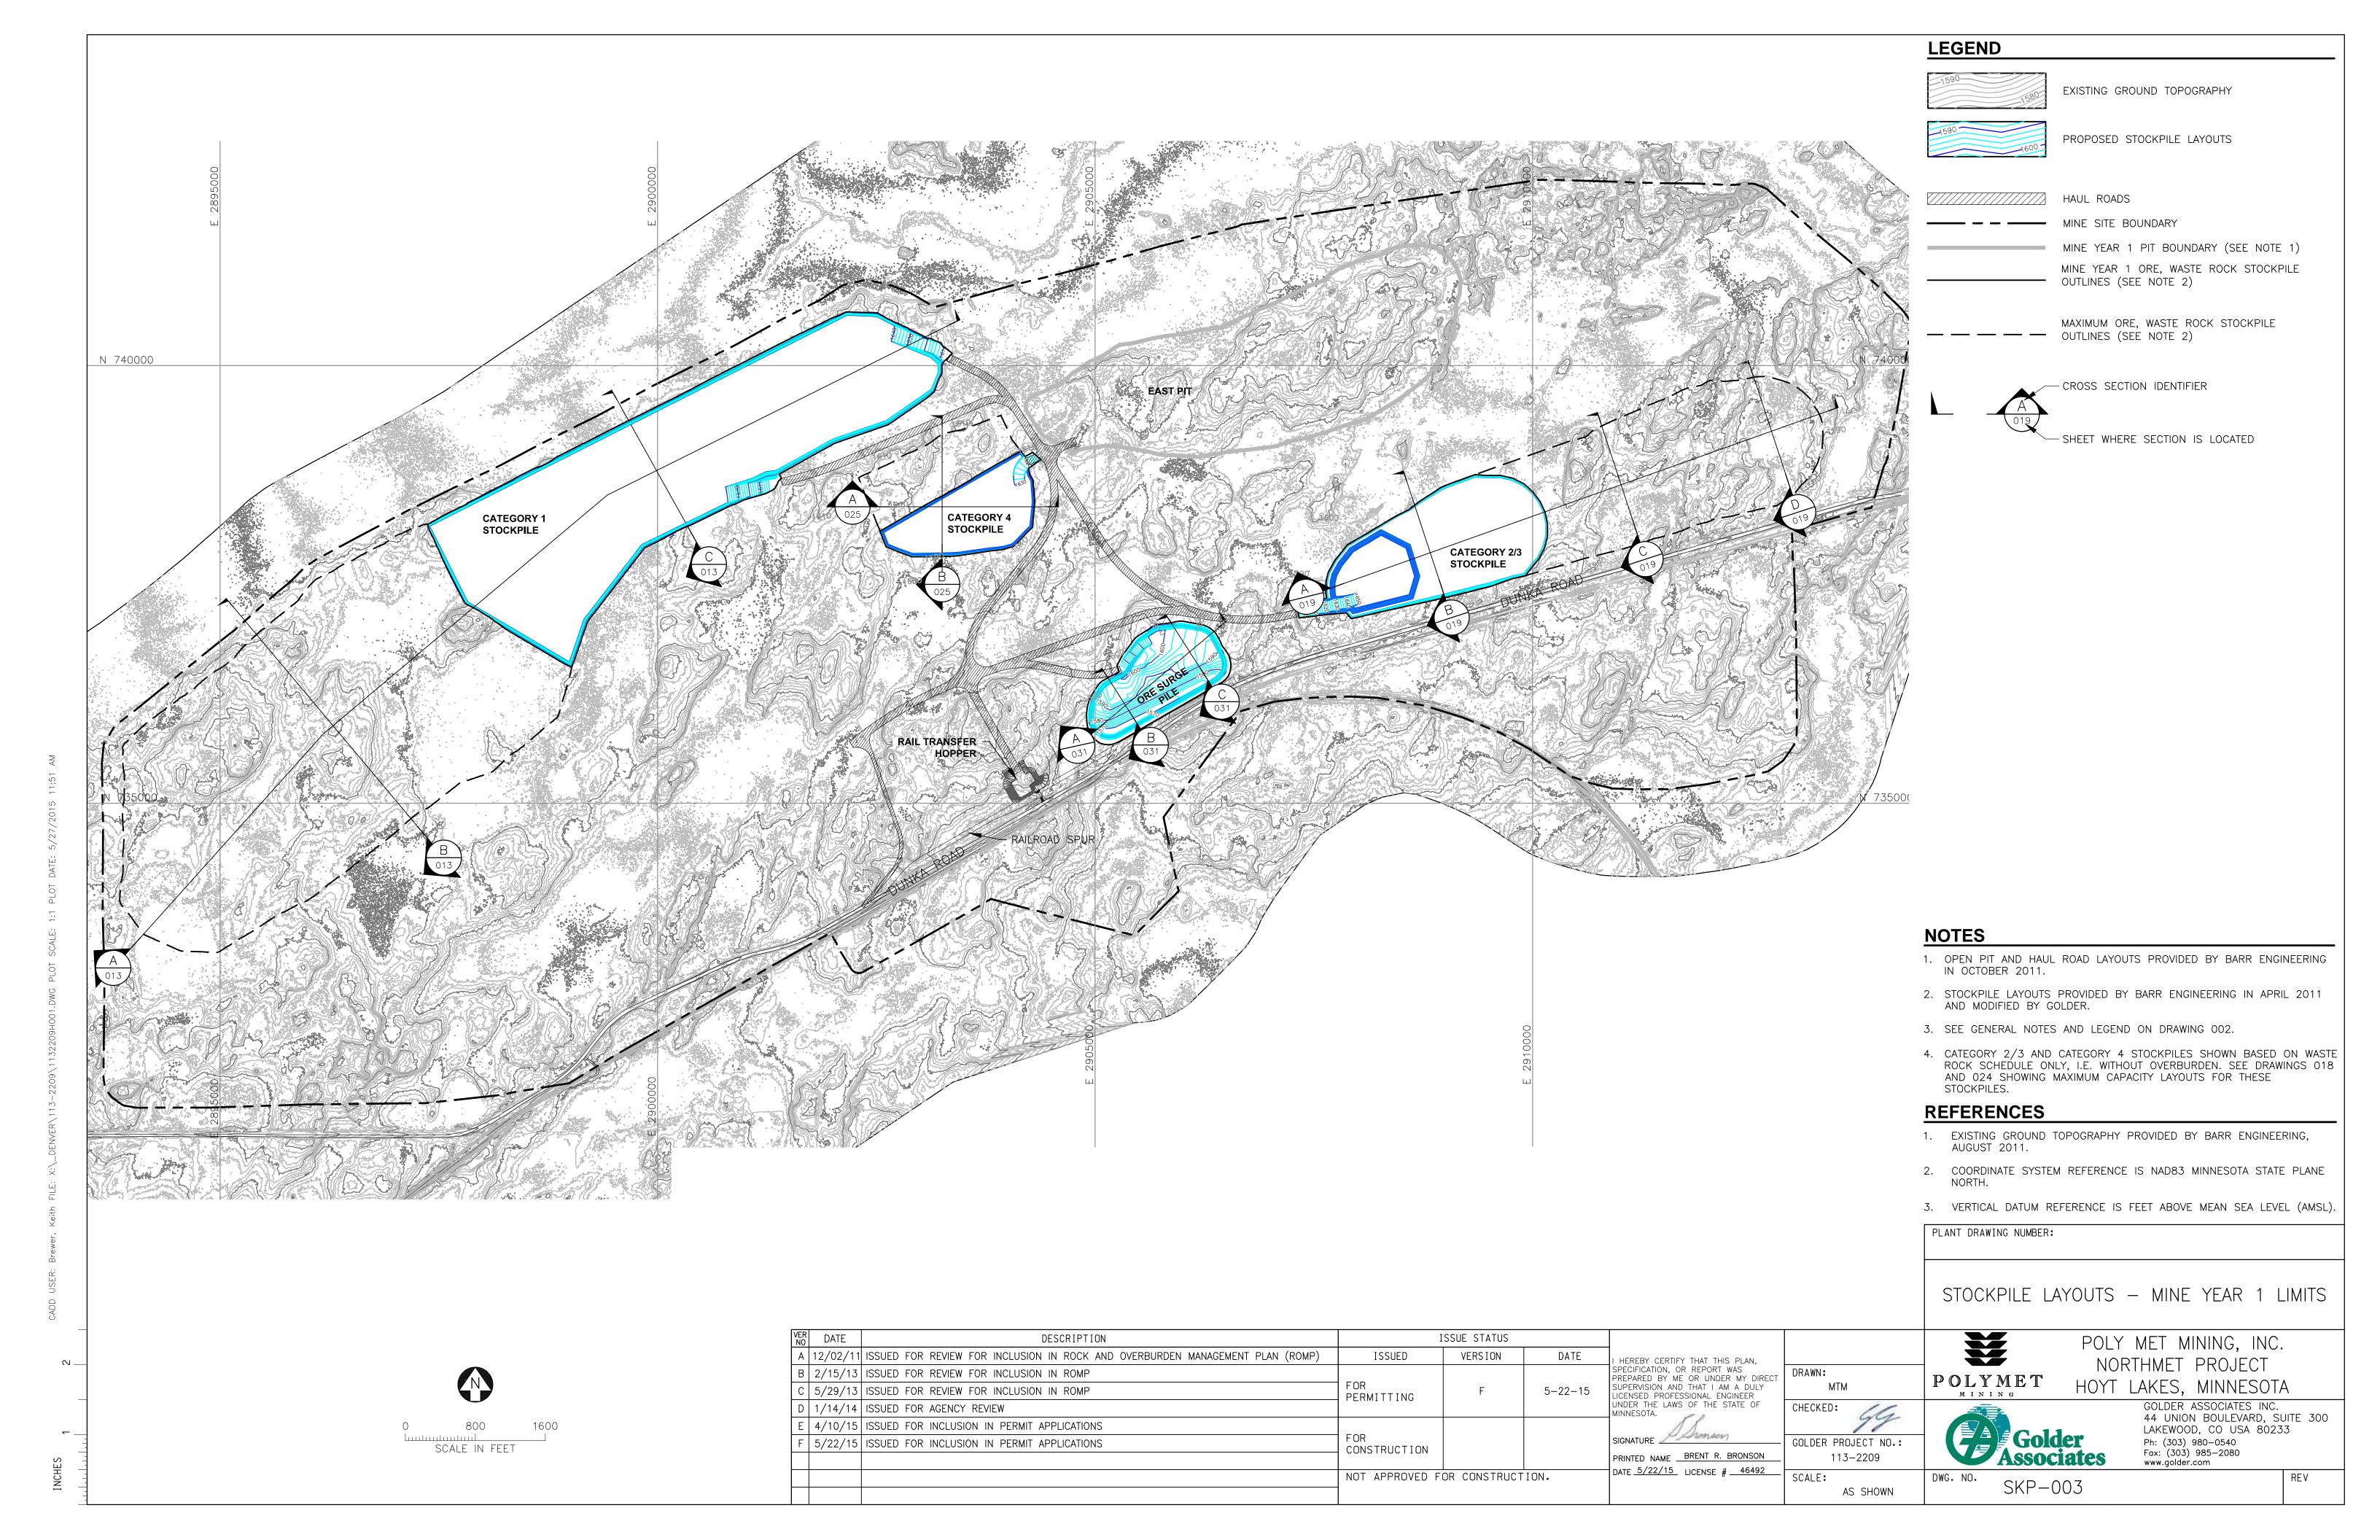


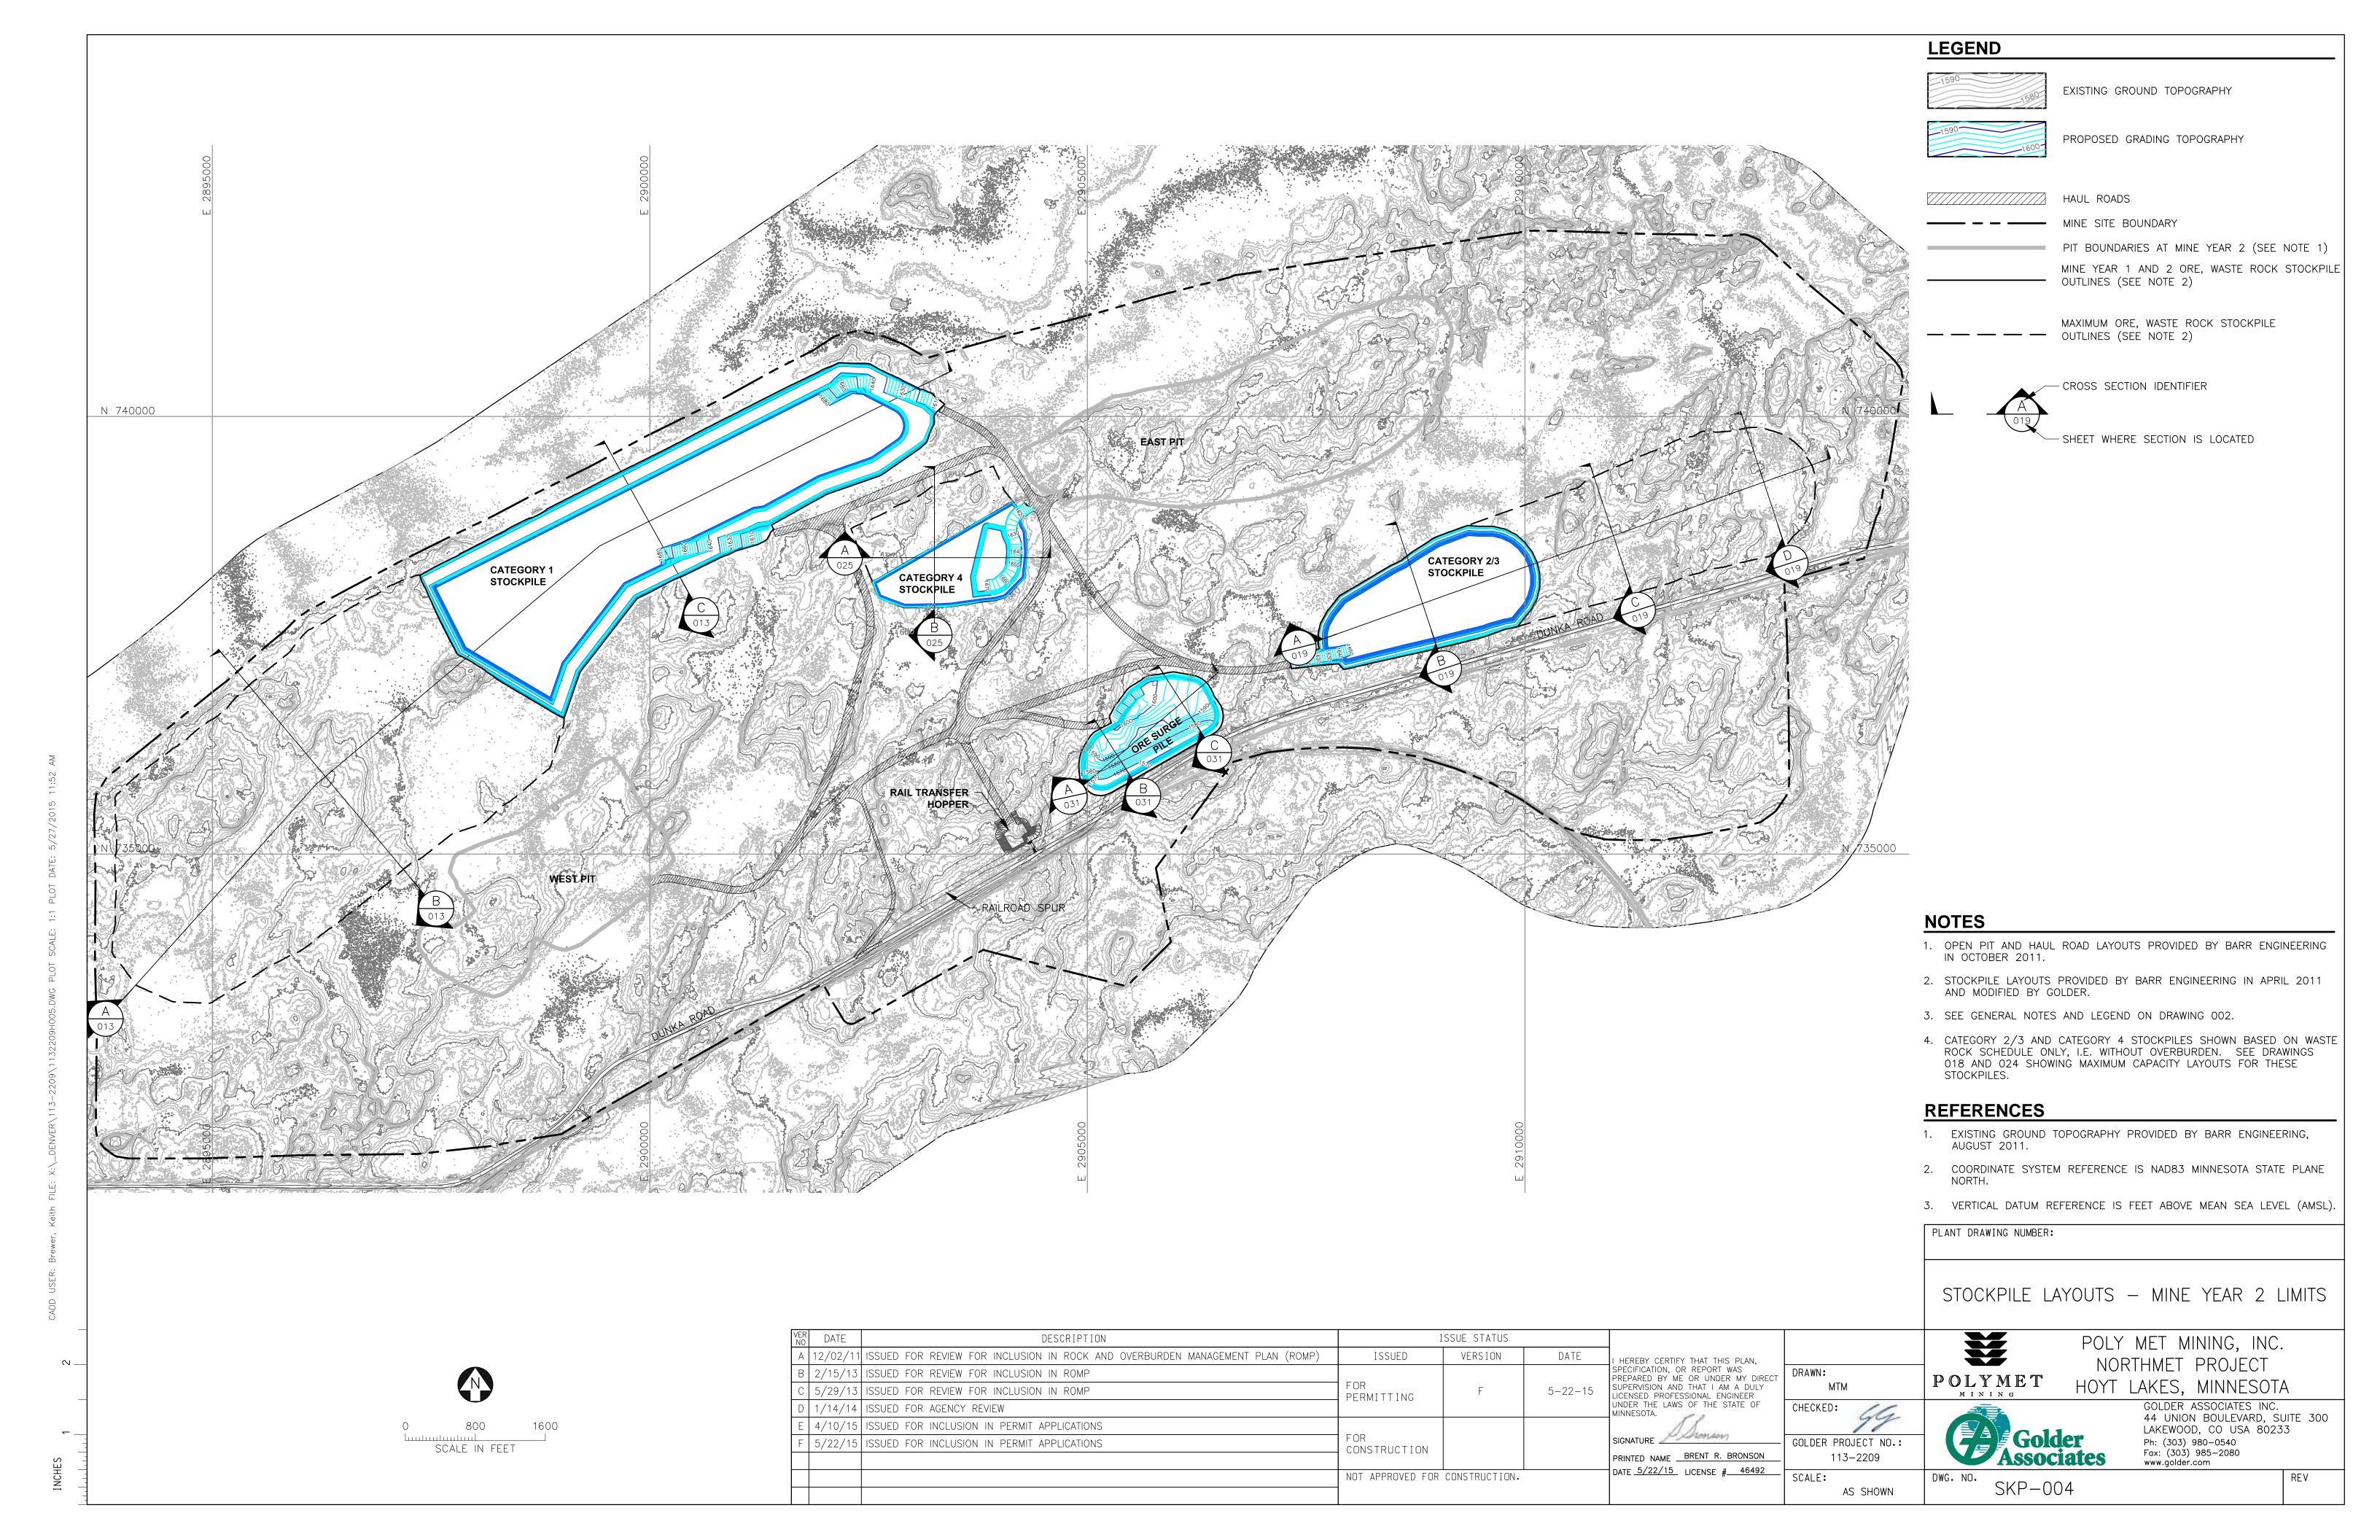


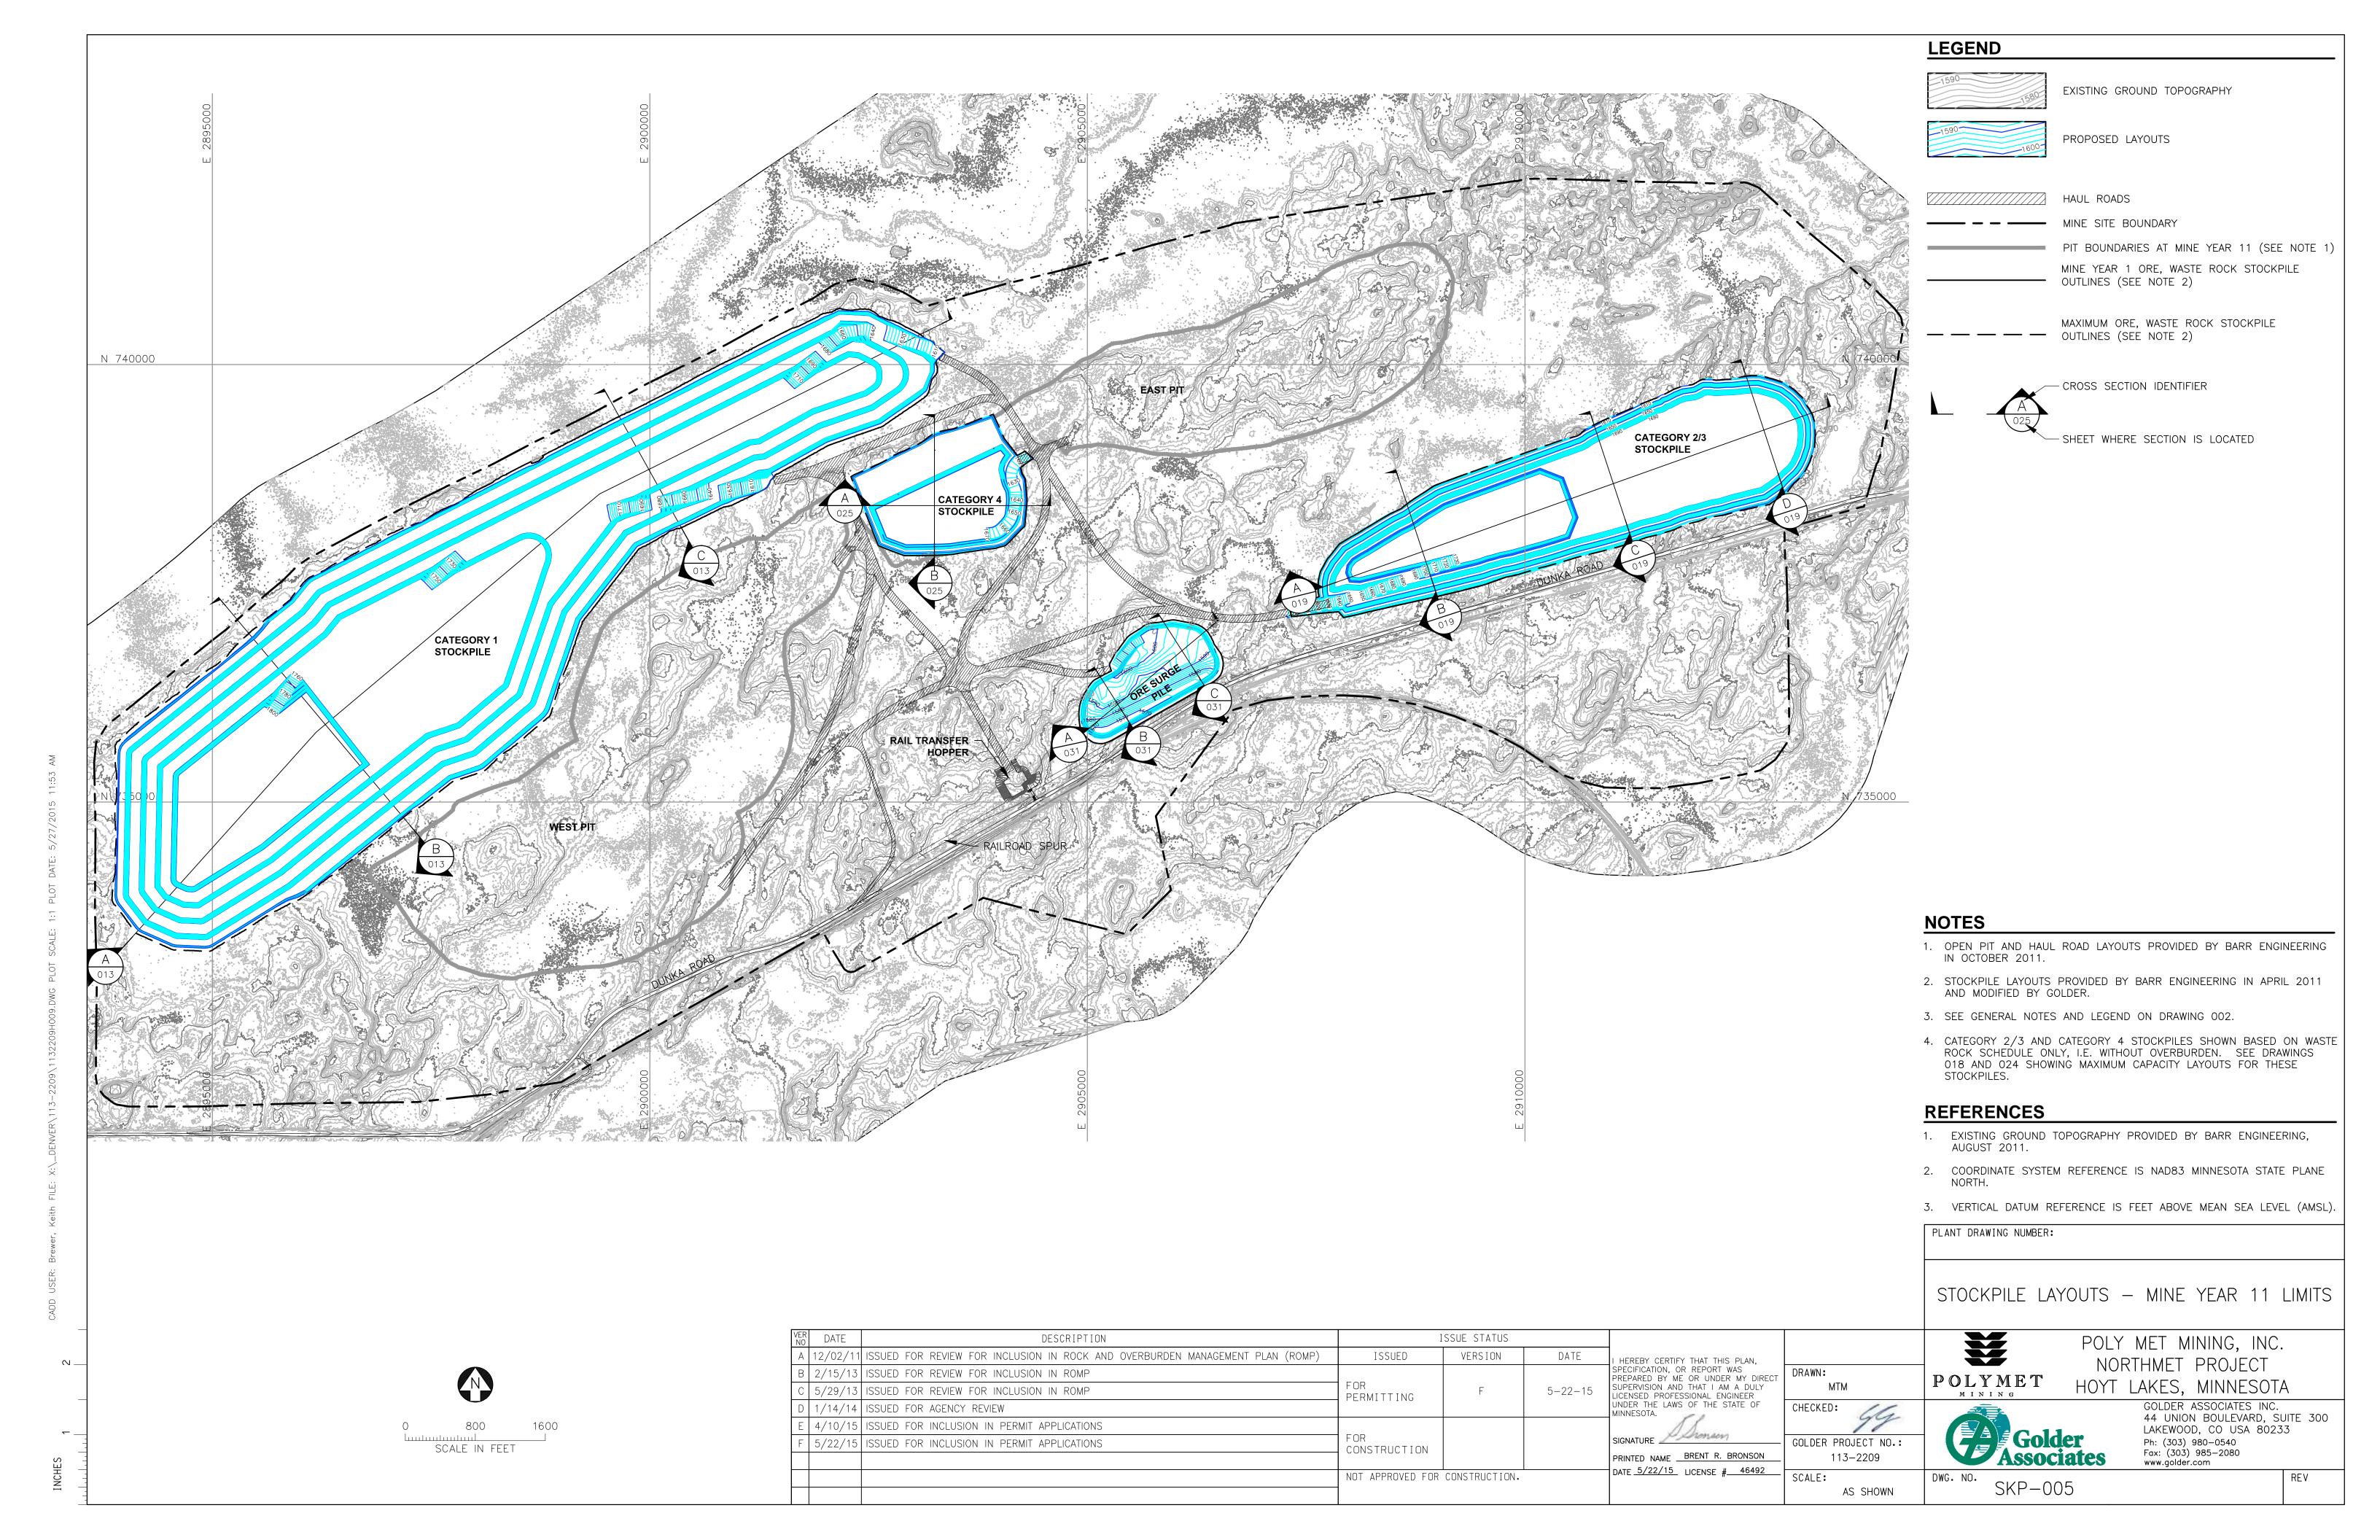


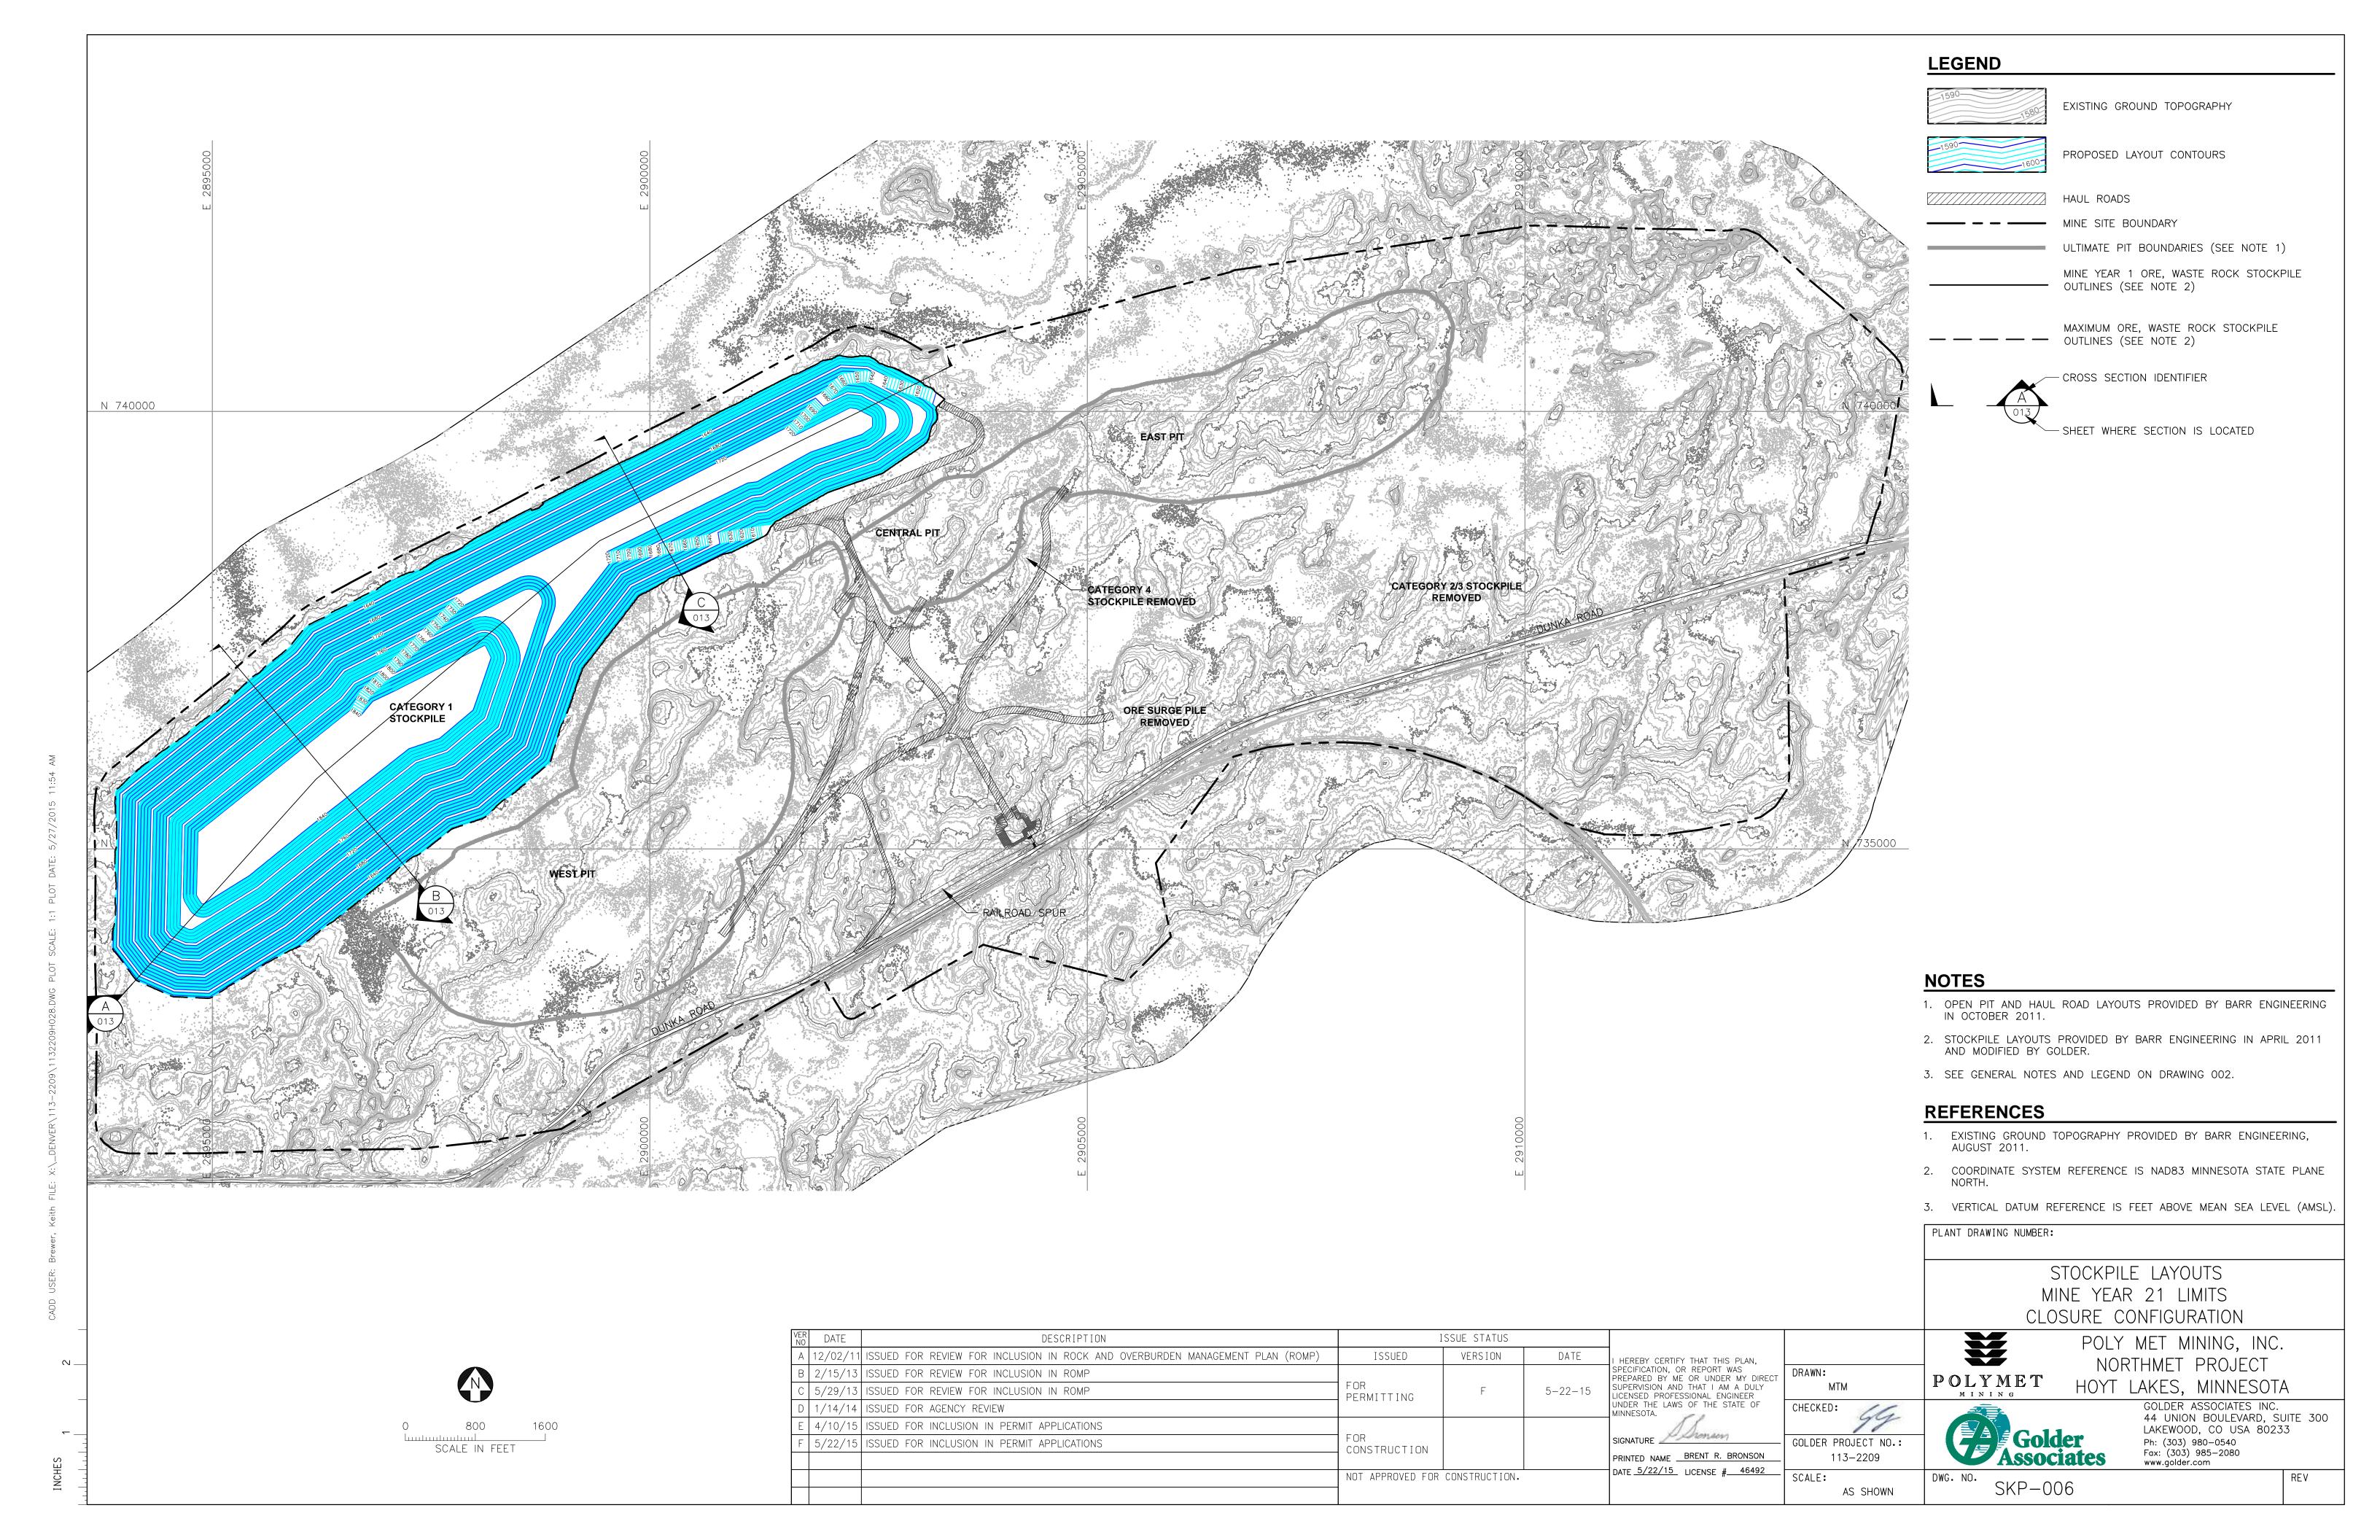


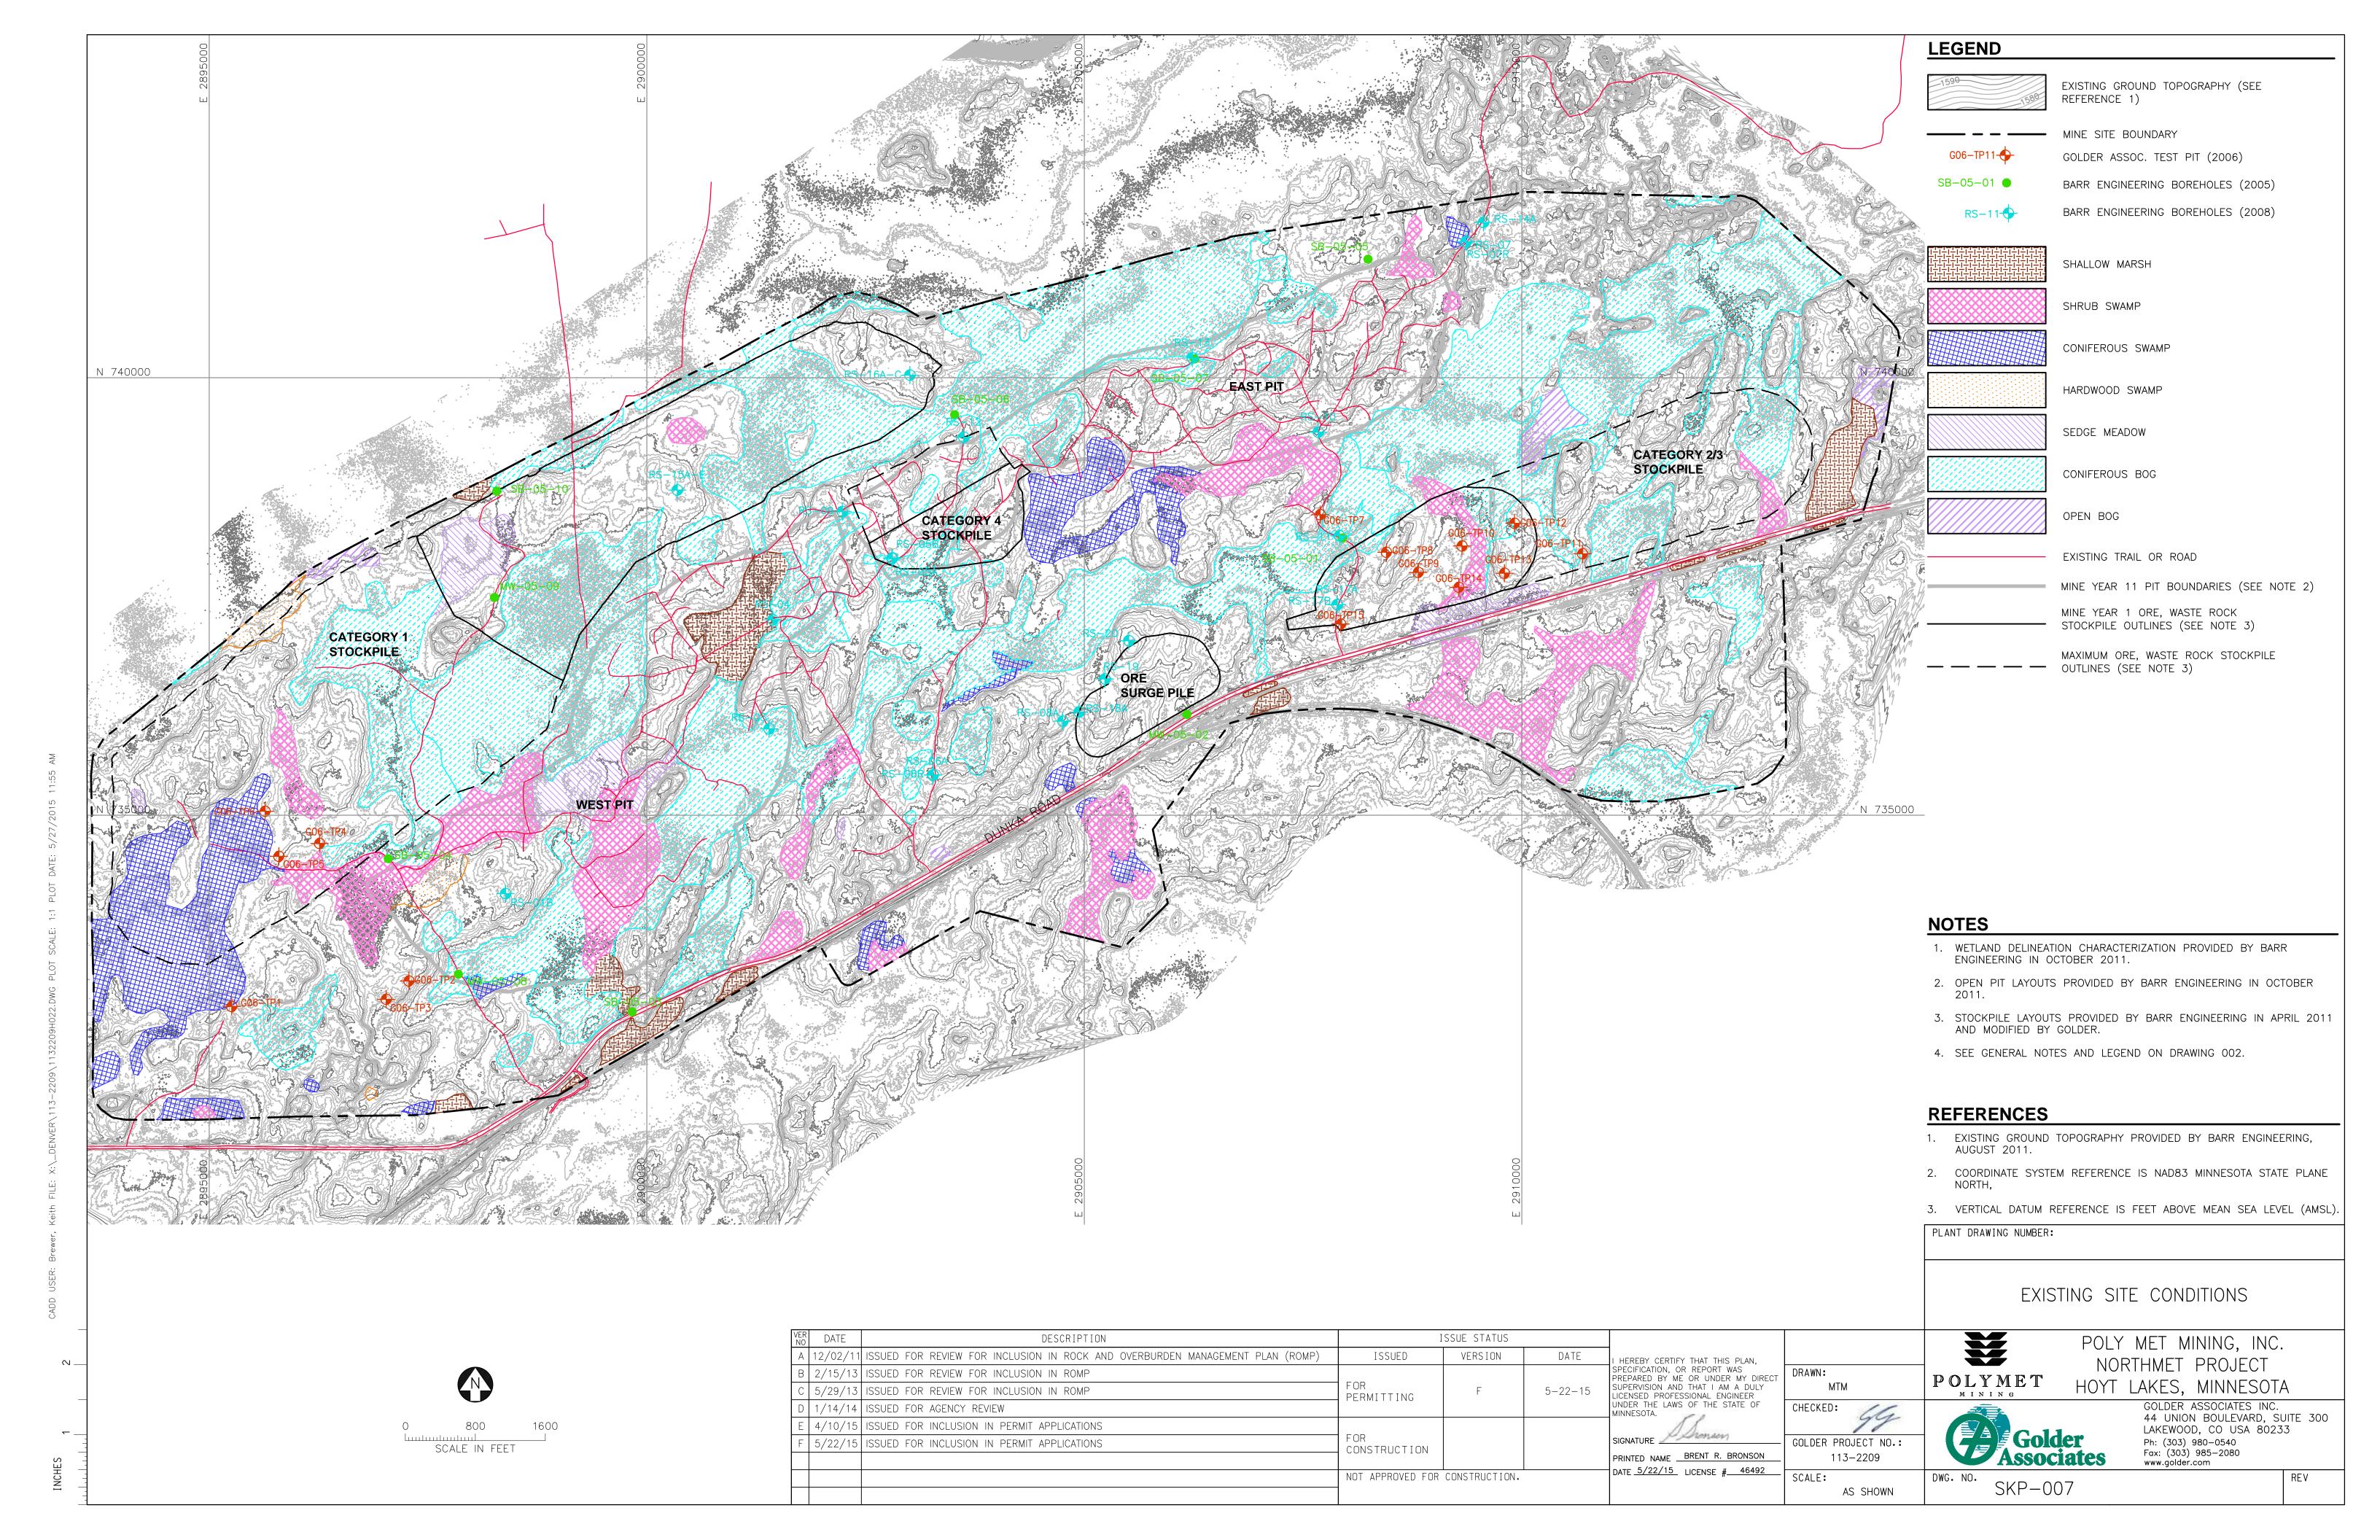


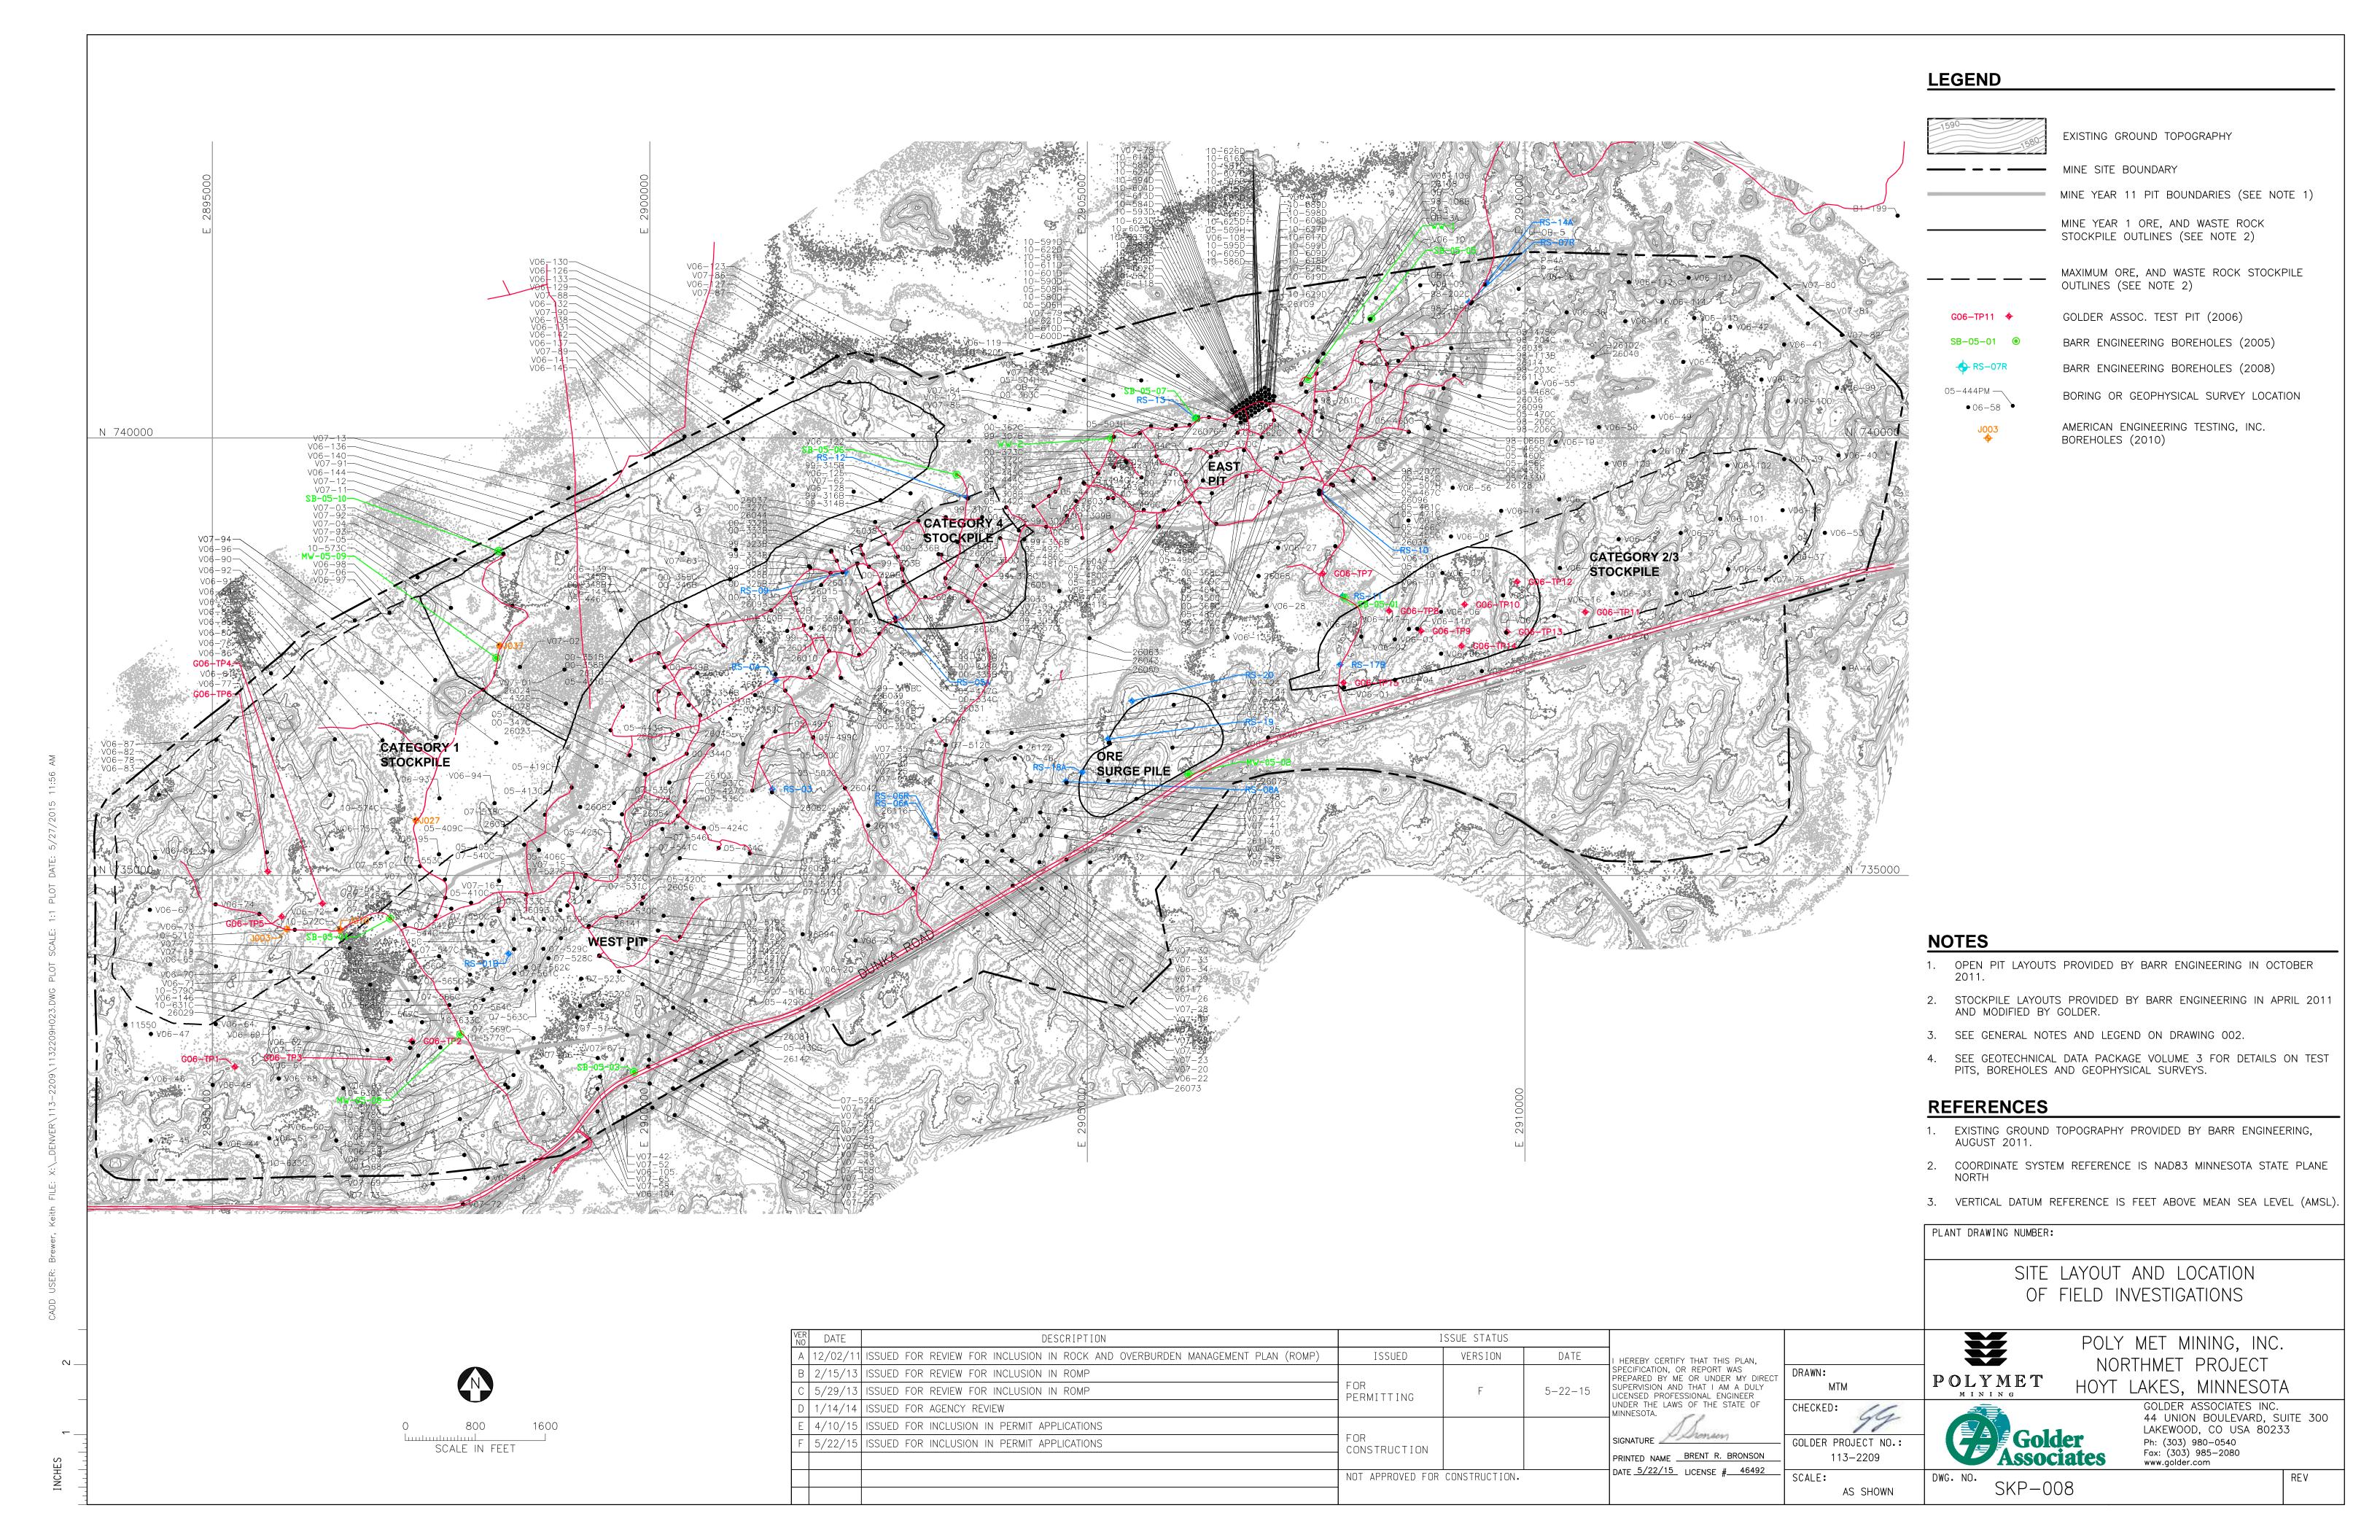


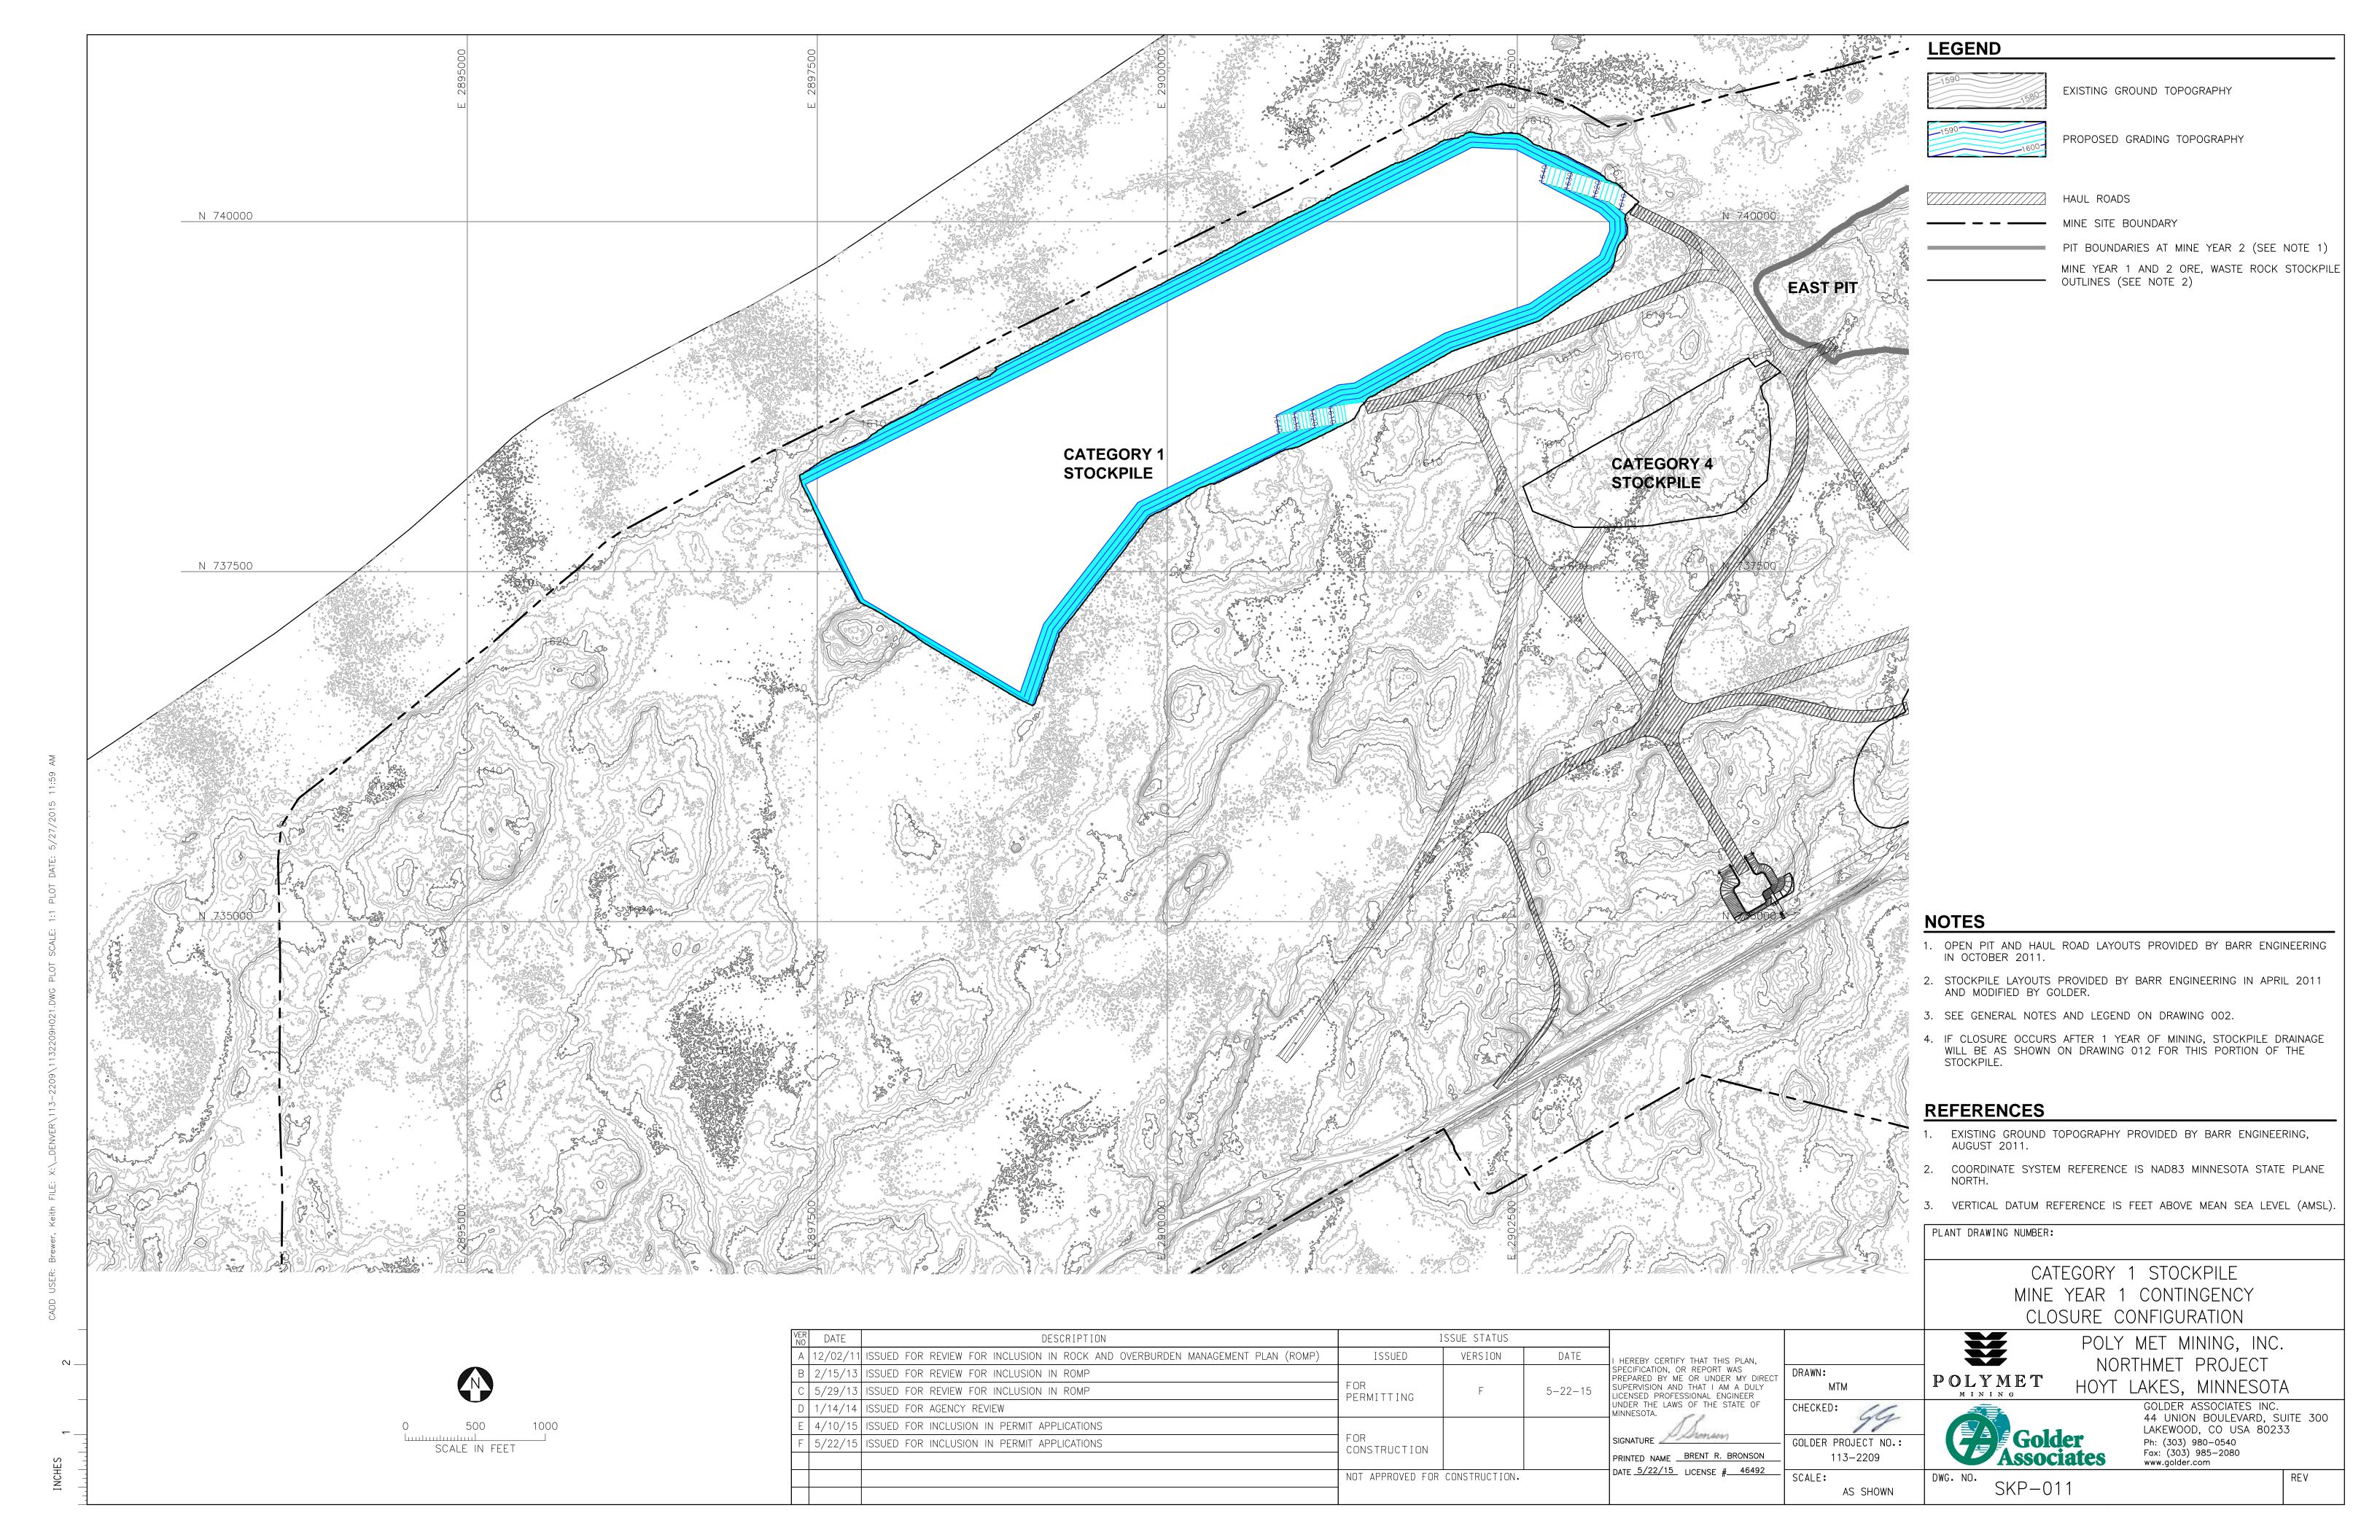

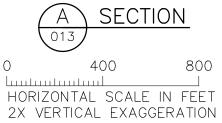

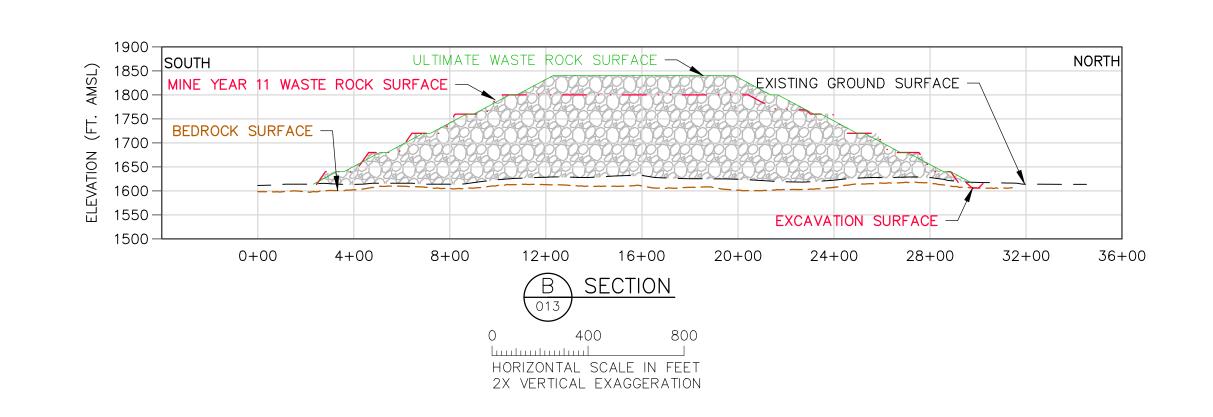

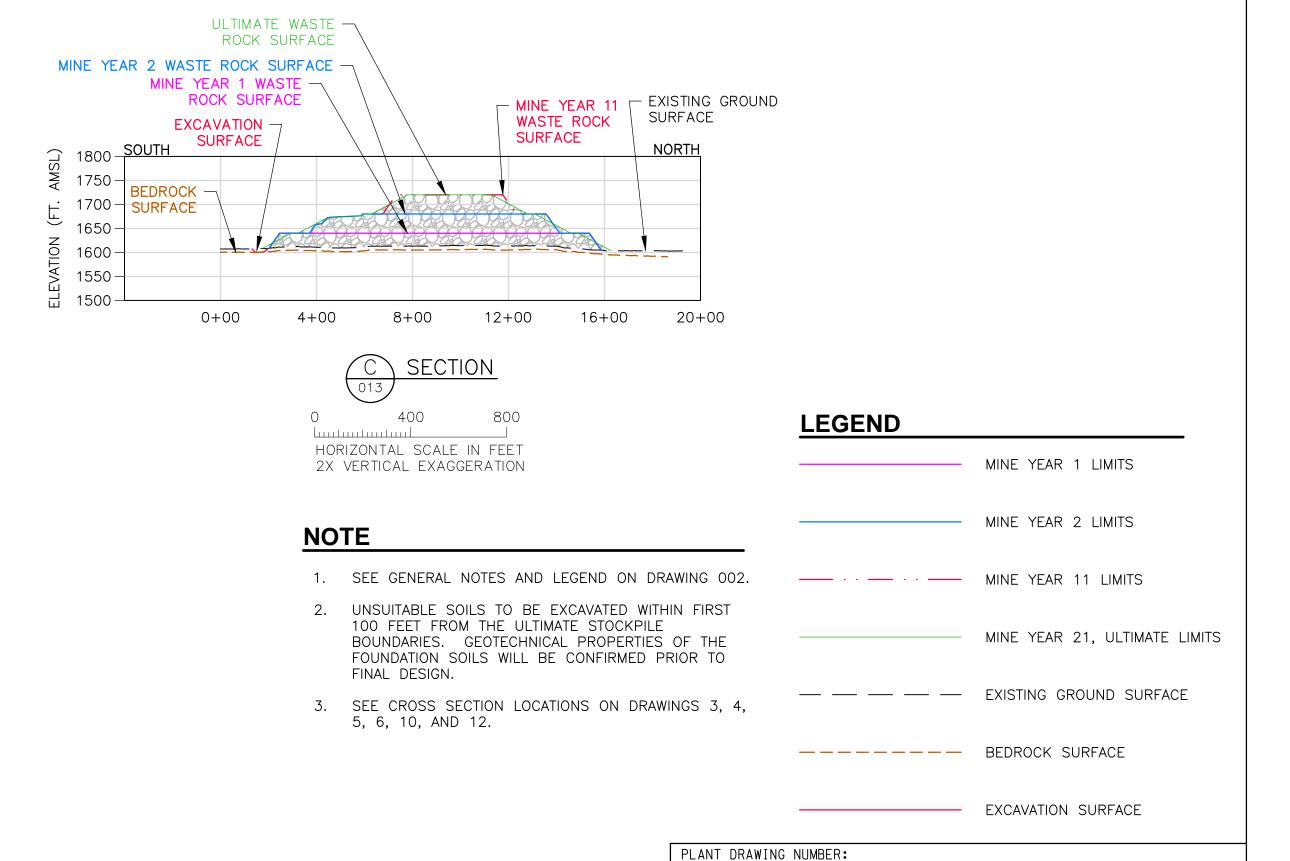

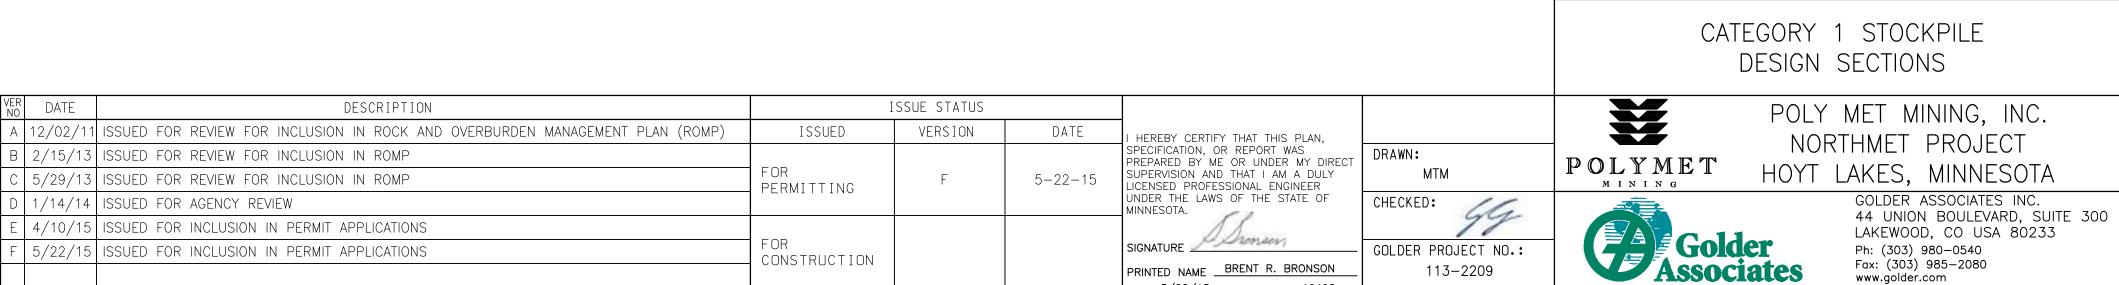

NOT APPROVED FOR CONSTRUCTION.

DATE <u>5/22/15</u> LICENSE # 46492

SCALE:

AS SHOWN

DWG. NO.

SKP-013

REV

CADD USER: Brewer, Keith FILE: X:\\_DENVER\113-2209\1132209H026.DWG PLOT SCALE: 1:1 PLOT D

AS SHOWN

EXISTING GROUND TOPOGRAPHY (SEE

REFERENCE 1) PROPOSED MINE YEAR 1 GRADING TOPOGRAPHY

PROPOSED MAXIMUM FOOTPRINT GRADING TOPOGRAPHY

MINE SITE BOUNDARY

CROSS SECTION IDENTIFIER

- SHEET WHERE SECTION IS LOCATED

MINE YEAR 11 PIT BOUNDARIES (SEE NOTE 1)

MINE YEAR 1 WASTE ROCK STOCKPILE OUTLINES (SEE NOTE 2)

MAXIMUM WASTE ROCK STOCKPILE OUTLINES (SEE NOTE 2)

HAUL ROADS

MINE DRAINAGE SUMP/POND (SEE NOTE 3)

# **NOTES**

- 1. OPEN PIT AND HAUL ROAD LAYOUTS PROVIDED BY BARR ENGINEERING IN OCTOBER 2011.
- 2. STOCKPILE LAYOUTS PROVIDED BY BARR ENGINEERING IN APRIL 2011 AND MODIFIED BY GOLDER.
- 3. SEE MECHANICAL INFRASTRUCTURE PERMIT SUPPORT DRAWINGS.
- 4. SEE GENERAL NOTES AND LEGEND ON DRAWING 002.

# REFERENCES

- 1. EXISTING GROUND TOPOGRAPHY PROVIDED BY BARR ENGINEERING, AUGUST 2011.
- 2. COORDINATE SYSTEM REFERENCE IS NAD83 MINNESOTA STATE PLANE
- 3. VERTICAL DATUM REFERENCE IS FEET ABOVE MEAN SEA LEVEL (AMSL).

PLANT DRAWING NUMBER:

CATEGORY 2/3 STOCKPILE FOUNDATION GRADING PLAN

MINE YEAR 1 AND MAXIMUM POLY MET MINING, INC.

発 NORTHMET PROJECT POLYMET

HOYT LAKES, MINNESOTA

GOLDER ASSOCIATES INC. 44 UNION BOULEVARD, SUITE 300 LAKEWOOD, CO USA 80233

Ph: (303) 980-0540 Fax: (303) 985-2080 www.golder.com Associates

SCALE IN FEET

VER DATE DESCRIPTION ISSUE STATUS A 12/02/11 ISSUED FOR REVIEW FOR INCLUSION IN ROCK AND OVERBURDEN MANAGEMENT PLAN (ROMP) I HEREBY CERTIFY THAT THIS PLAN,
SPECIFICATION, OR REPORT WAS
PREPARED BY ME OR UNDER MY DIRECT
SUPERVISION AND THAT I AM A DULY
LICENSED PROFESSIONAL ENGINEER
UNDER THE LAWS OF THE STATE OF
MINNESOTA. ISSUED VERSION DATE B 2/15/13 ISSUED FOR REVIEW FOR INCLUSION IN ROMP C 5/29/13 ISSUED FOR REVIEW FOR INCLUSION IN ROMP PERMITTING D 1/14/14 ISSUED FOR AGENCY REVIEW E 4/10/15 ISSUED FOR INCLUSION IN PERMIT APPLICATIONS SIGNATURE Monson F | 5/22/15 | ISSUED FOR INCLUSION IN PERMIT APPLICATIONS CONSTRUCTION PRINTED NAME BRENT R. BRONSON

NOT APPROVED FOR CONSTRUCTION.

GOLDER PROJECT NO.: 113-2209

DRAWN:

DATE <u>5/22/15</u> LICENSE # 46492

CHECKED:


SCALE:


MTM


AS SHOWN

DWG. NO.

REV SKP-015

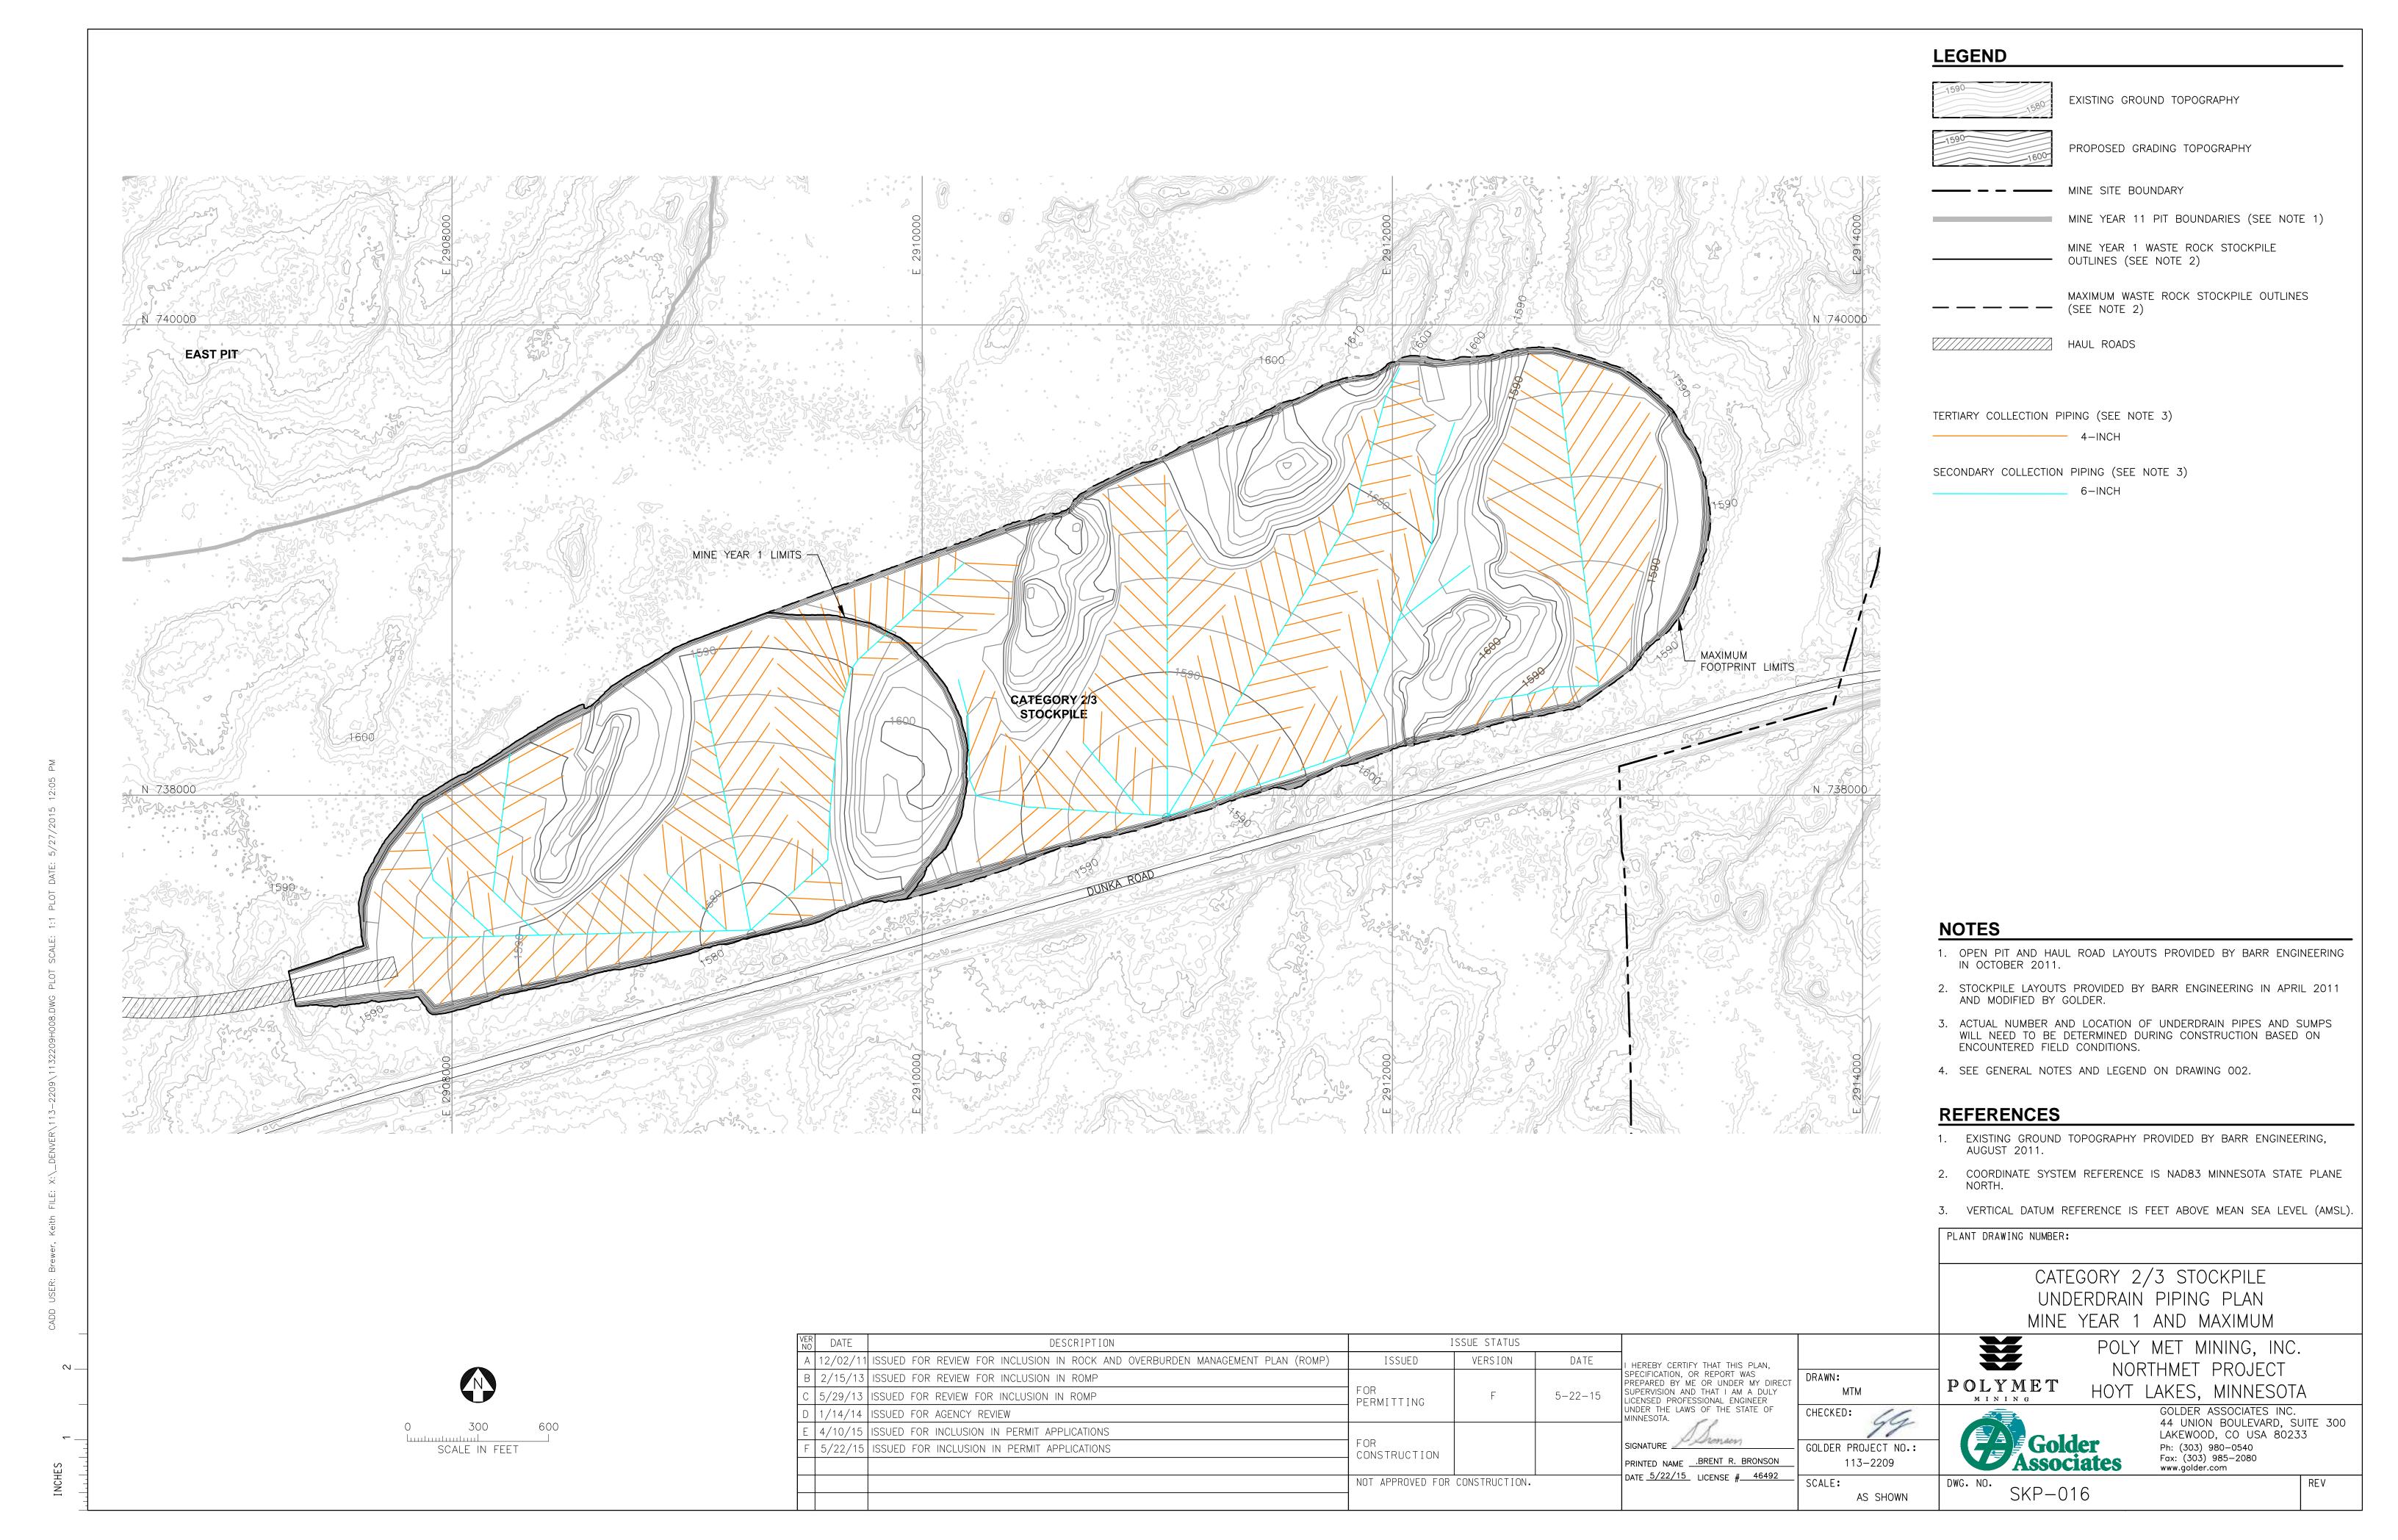

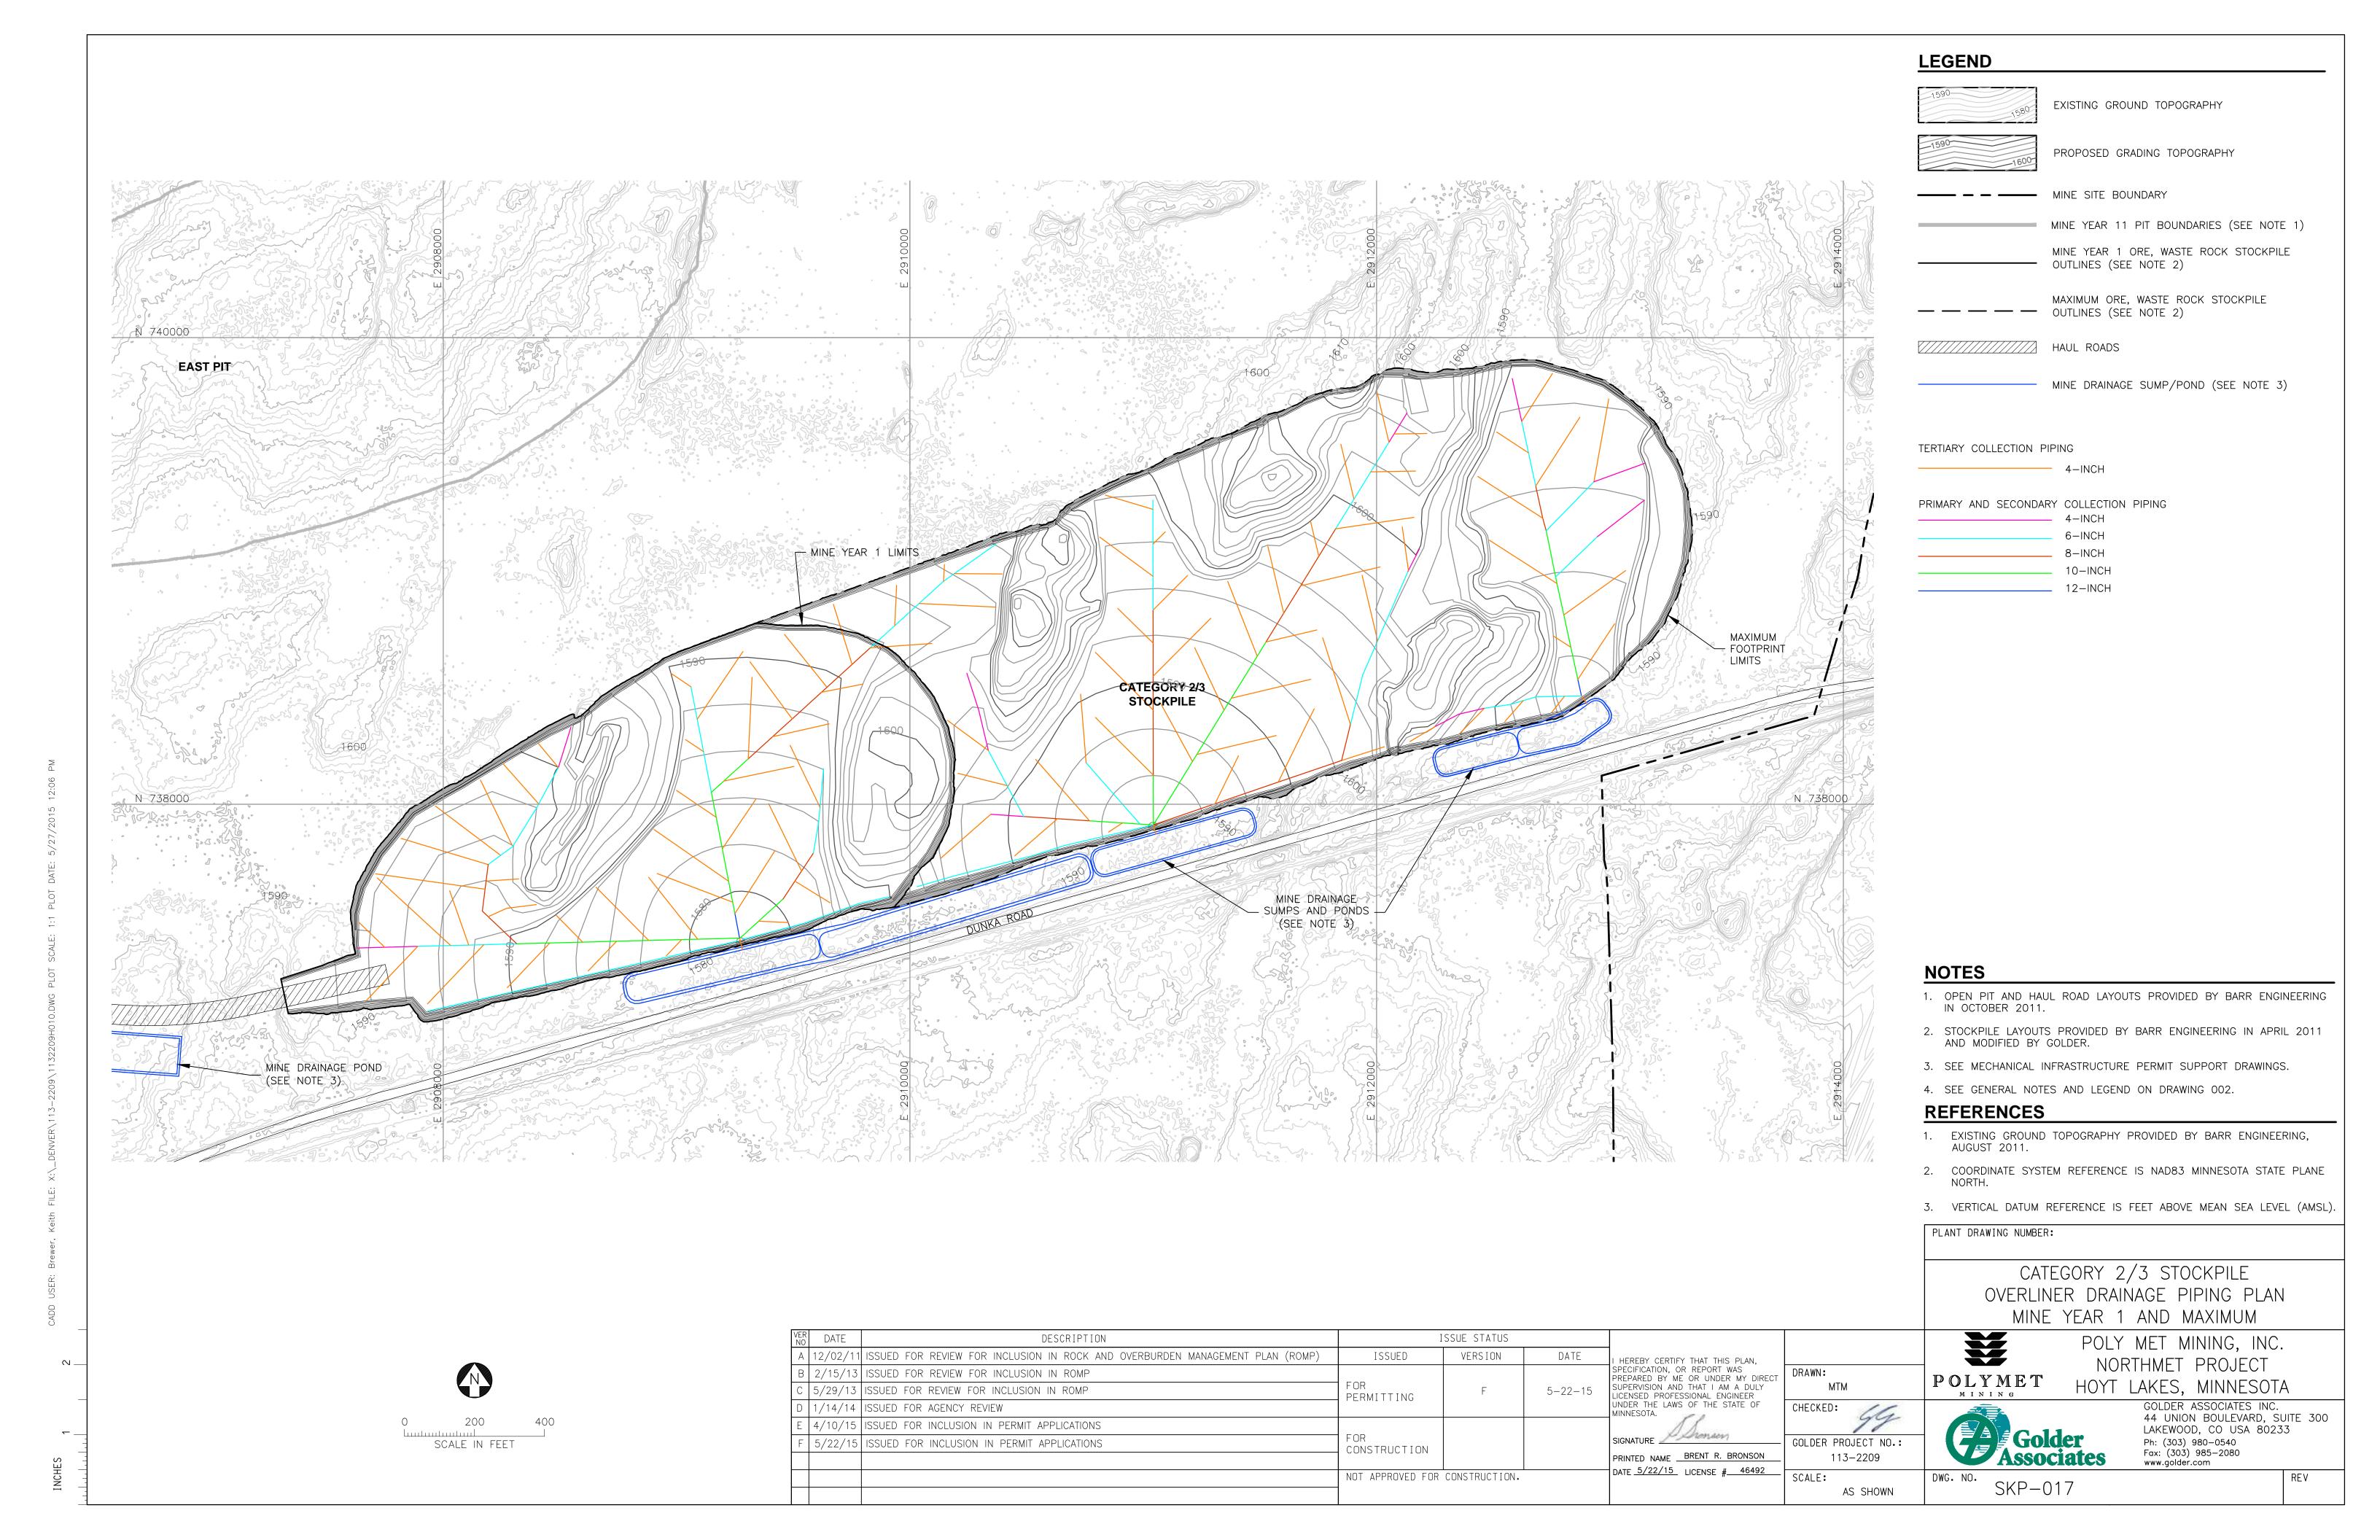

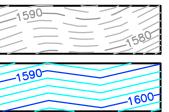

EXISTING GROUND TOPOGRAPHY (SEE REFERENCE 1)

PROPOSED MAXIMUM GRADING TOPOGRAPHY

MINE SITE BOUNDARY

CROSS SECTION IDENTIFIER

SHEET WHERE SECTION IS LOCATED

MINE YEAR 1 WASTE ROCK STOCKPILE OUTLINES (SEE NOTE 2)

MAXIMUM ORE, WASTE ROCK STOCKPILE OUTLINES (SEE NOTE 2)

PROPOSED HAUL ROAD

MINE YEAR 11 PIT BOUNDARIES (SEE NOTE 1)

#### **NOTES**

- 1. OPEN PIT AND HAUL ROAD LAYOUTS PROVIDED BY BARR ENGINEERING IN OCTOBER 2011.
- 2. STOCKPILE LAYOUTS PROVIDED BY BARR ENGINEERING IN APRIL 2011 AND MODIFIED BY GOLDER.
- 3. SEE GENERAL NOTES AND LEGEND ON DRAWING 002.

#### **REFERENCES**

- 1. EXISTING GROUND TOPOGRAPHY PROVIDED BY BARR ENGINEERING, AUGUST 2011.
- 2. COORDINATE SYSTEM REFERENCE IS NAD83 MINNESOTA STATE PLANE
- 3. VERTICAL DATUM REFERENCE IS FEET ABOVE MEAN SEA LEVEL (AMSL).

PLANT DRAWING NUMBER:

CATEGORY 2/3 STOCKPILE MAXIMUM CAPACITY CONFIGURATION

POLY MET MINING, INC. NORTHMET PROJECT

HOYT LAKES, MINNESOTA

GOLDER ASSOCIATES INC. 44 UNION BOULEVARD, SUITE 300 LAKEWOOD, CO USA 80233 Ph: (303) 980-0540 Fax: (303) 985-2080

DWG. NO. SKP-018

P O L Y M E T

DRAWN:

CHECKED:

SCALE:

GOLDER PROJECT NO.:

113-2209


AS SHOWN

Deronsen

**Associates** 


www.golder.com

REV

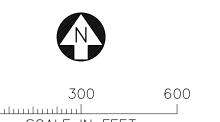

VER DATE DESCRIPTION ISSUE STATUS A 12/02/11 ISSUED FOR REVIEW FOR INCLUSION IN ROCK AND OVERBURDEN MANAGEMENT PLAN (ROMP) ISSUED **VERSION** DATE I HEREBY CERTIFY THAT THIS PLAN,
SPECIFICATION, OR REPORT WAS
PREPARED BY ME OR UNDER MY DIRECT
SUPERVISION AND THAT I AM A DULY
LICENSED PROFESSIONAL ENGINEER
UNDER THE LAWS OF THE STATE OF
MINNESOTA. B 2/15/13 ISSUED FOR REVIEW FOR INCLUSION IN ROMP C | 5/29/13 | ISSUED FOR REVIEW FOR INCLUSION IN ROMP PERMITTING D 1/14/14 ISSUED FOR AGENCY REVIEW E 4/10/15 ISSUED FOR INCLUSION IN PERMIT APPLICATIONS SIGNATURE \_\_\_\_ F | 5/22/15 | ISSUED FOR INCLUSION IN PERMIT APPLICATIONS CONSTRUCTION PRINTED NAME BRENT R. BRONSON DATE <u>5/22/15</u> LICENSE # 46492 NOT APPROVED FOR CONSTRUCTION.

SCALE IN FEET

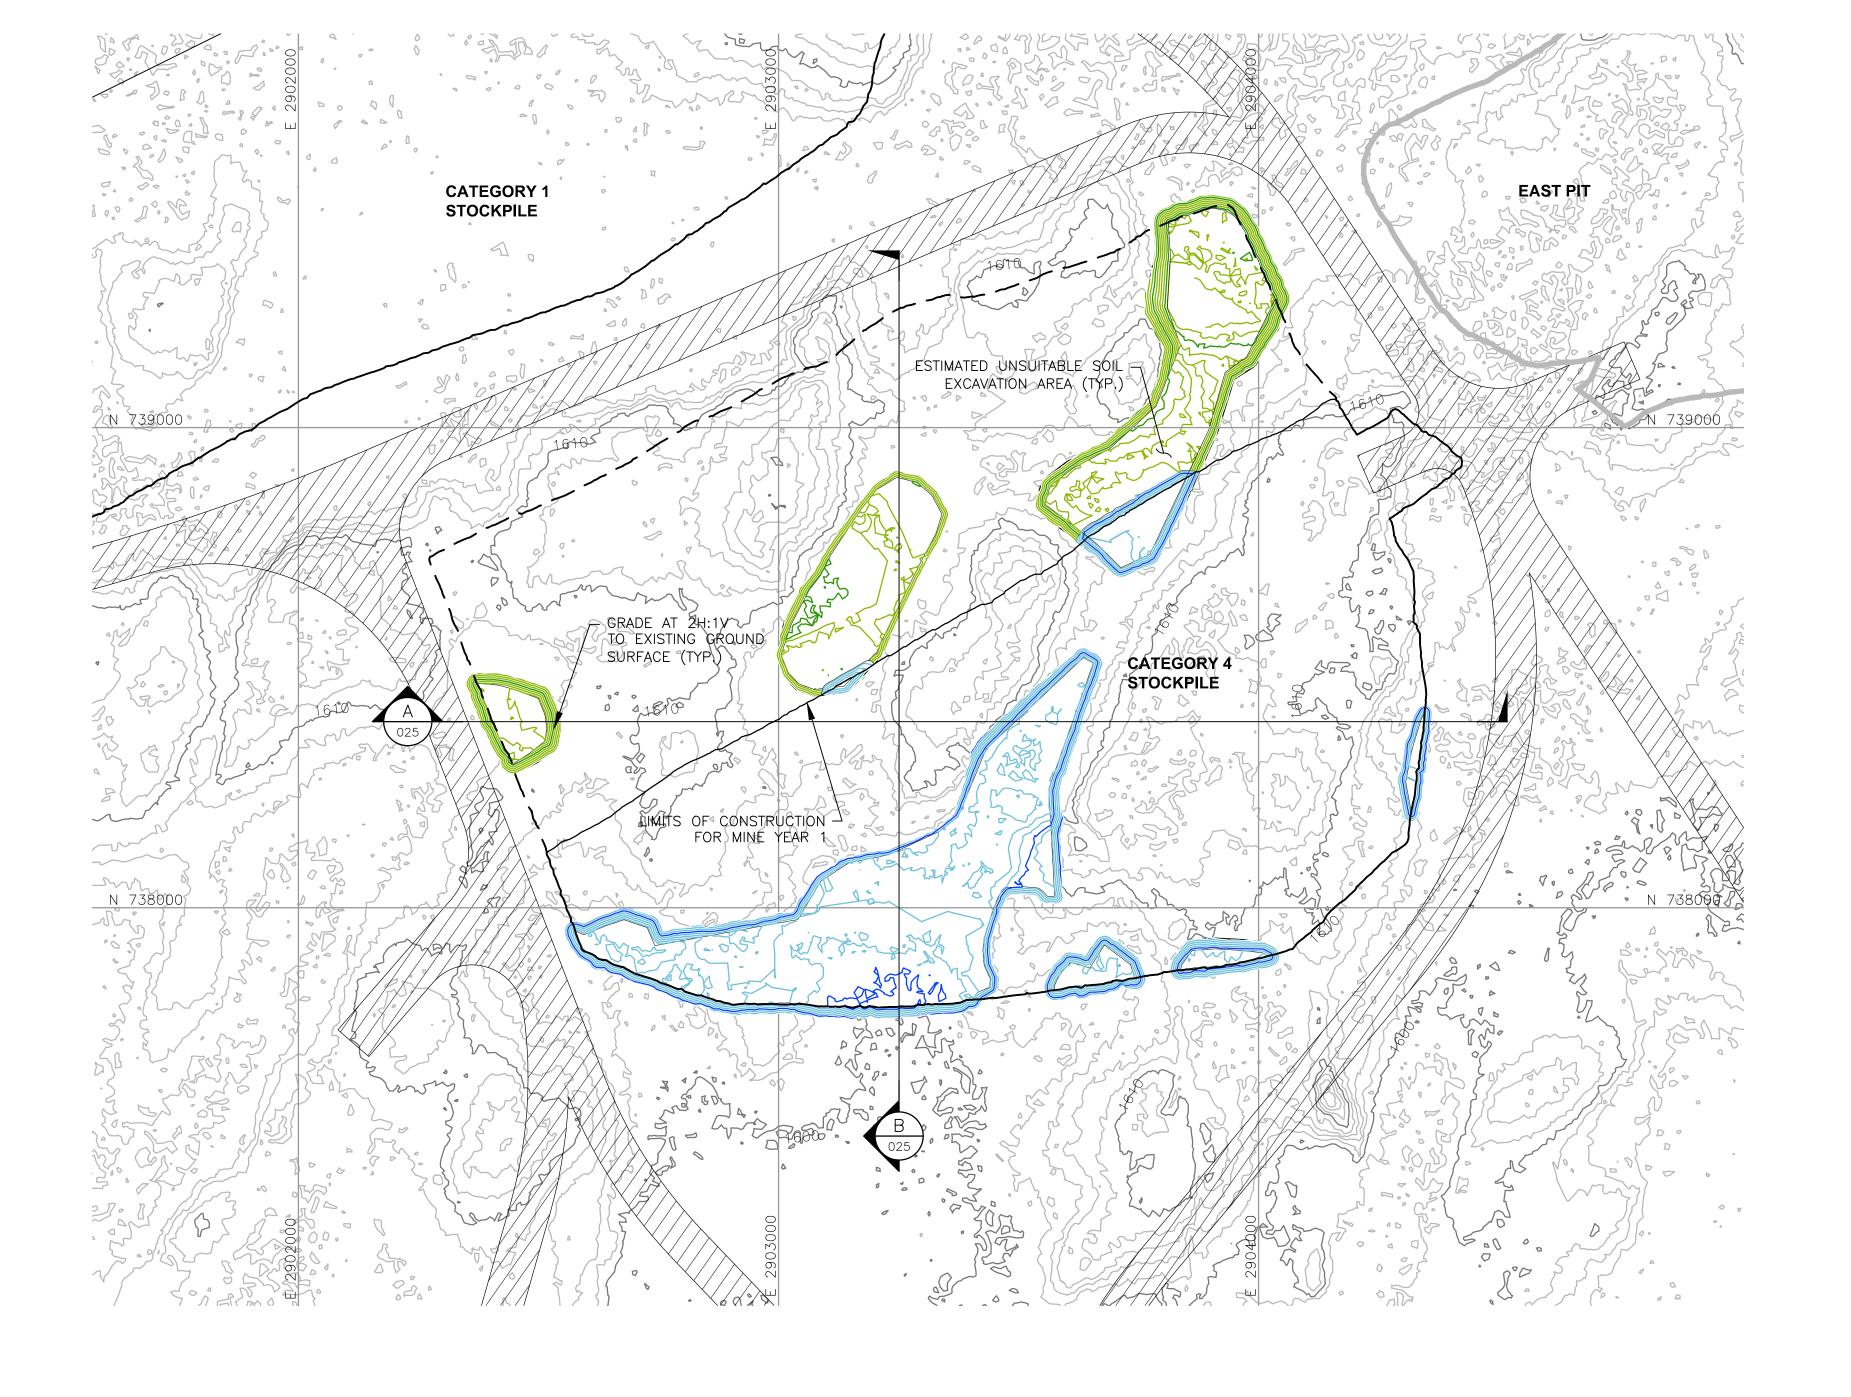

EXISTING GROUND TOPOGRAPHY (SEE REFERENCE 1)

PROPOSED MINE YEAR 1 EXCAVATION TOPOGRAPHY

PROPOSED MAXIMUM FOOTPRINT EXCAVATION TOPOGRAPHY

- - MINE SITE BOUNDARY

MINE YEAR 1 WASTE ROCK STOCKPILE OUTLINES (SEE NOTE 2)

MAXIMUM WASTE ROCK STOCKPILE — OUTLINES (SEE NOTE 2)

HAUL ROADS

MINE YEAR 2 PIT BOUNDARIES (SEE NOTE 1)



— CROSS SECTION IDENTIFIER

- SHEET WHERE SECTION IS LOCATED

# **NOTES**

- OPEN PIT AND HAUL ROAD LAYOUTS PROVIDED BY BARR ENGINEERING IN OCTOBER 2011.
- 2. STOCKPILE LAYOUTS PROVIDED BY BARR ENGINEERING IN APRIL 2011 AND MODIFIED BY GOLDER.
- 3. SEE GENERAL NOTES AND LEGEND ON DRAWING 002.

## REFERENCES

- 1. EXISTING GROUND TOPOGRAPHY PROVIDED BY BARR ENGINEERING, AUGUST 2011.
- 2. COORDINATE SYSTEM REFERENCE IS NAD83 MINNESOTA STATE PLANE
- 3. VERTICAL DATUM REFERENCE IS FEET ABOVE MEAN SEA LEVEL (AMSL).

CATEGORY 4 STOCKPILE SUBGRADE EXCAVATION PLAN

吾

DRAWN:

DATE <u>5/22/15</u> LICENSE # 46492

CHECKED:

SCALE:

MTM

GOLDER PROJECT NO.:

113-2209

AS SHOWN

PLANT DRAWING NUMBER:

POLY MET MINING, INC. NORTHMET PROJECT

 $\mathbb{P} \bigcirc \mathbb{L} \underset{\scriptscriptstyle{\mathrm{M}}}{\mathbb{L}} \underset{\scriptscriptstyle{\mathrm{N}}}{\mathbb{N}} \underset{\scriptscriptstyle{\mathrm{K}}}{\mathbb{M}} \mathbb{E} \mathbb{T}$ HOYT LAKES, MINNESOTA

GOLDER ASSOCIATES INC. 44 UNION BOULEVARD, SUITE 300 LAKEWOOD, CO USA 80233


REV


Ph: (303) 980-0540 Fax: (303) 985-2080 www.golder.com DWG. NO. SKP-020

SCALE IN FEET

VER DATE DESCRIPTION ISSUE STATUS A 12/02/11 ISSUED FOR REVIEW FOR INCLUSION IN ROCK AND OVERBURDEN MANAGEMENT PLAN (ROMP) I HEREBY CERTIFY THAT THIS PLAN,
SPECIFICATION, OR REPORT WAS
PREPARED BY ME OR UNDER MY DIRECT
SUPERVISION AND THAT I AM A DULY
LICENSED PROFESSIONAL ENGINEER
UNDER THE LAWS OF THE STATE OF
MINNESOTA. ISSUED VERSION DATE B 2/15/13 ISSUED FOR REVIEW FOR INCLUSION IN ROMP C 5/29/13 ISSUED FOR REVIEW FOR INCLUSION IN ROMP PERMITTING D 1/14/14 ISSUED FOR AGENCY REVIEW E 4/10/15 ISSUED FOR INCLUSION IN PERMIT APPLICATIONS Honson SIGNATURE \_\_\_\_ F | 5/22/15 | ISSUED FOR INCLUSION IN PERMIT APPLICATIONS CONSTRUCTION PRINTED NAME BRENT R. BRONSON

NOT APPROVED FOR CONSTRUCTION.

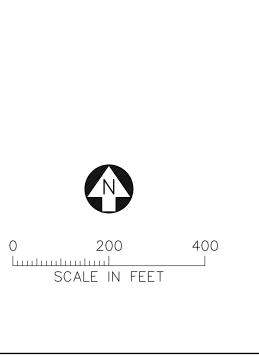

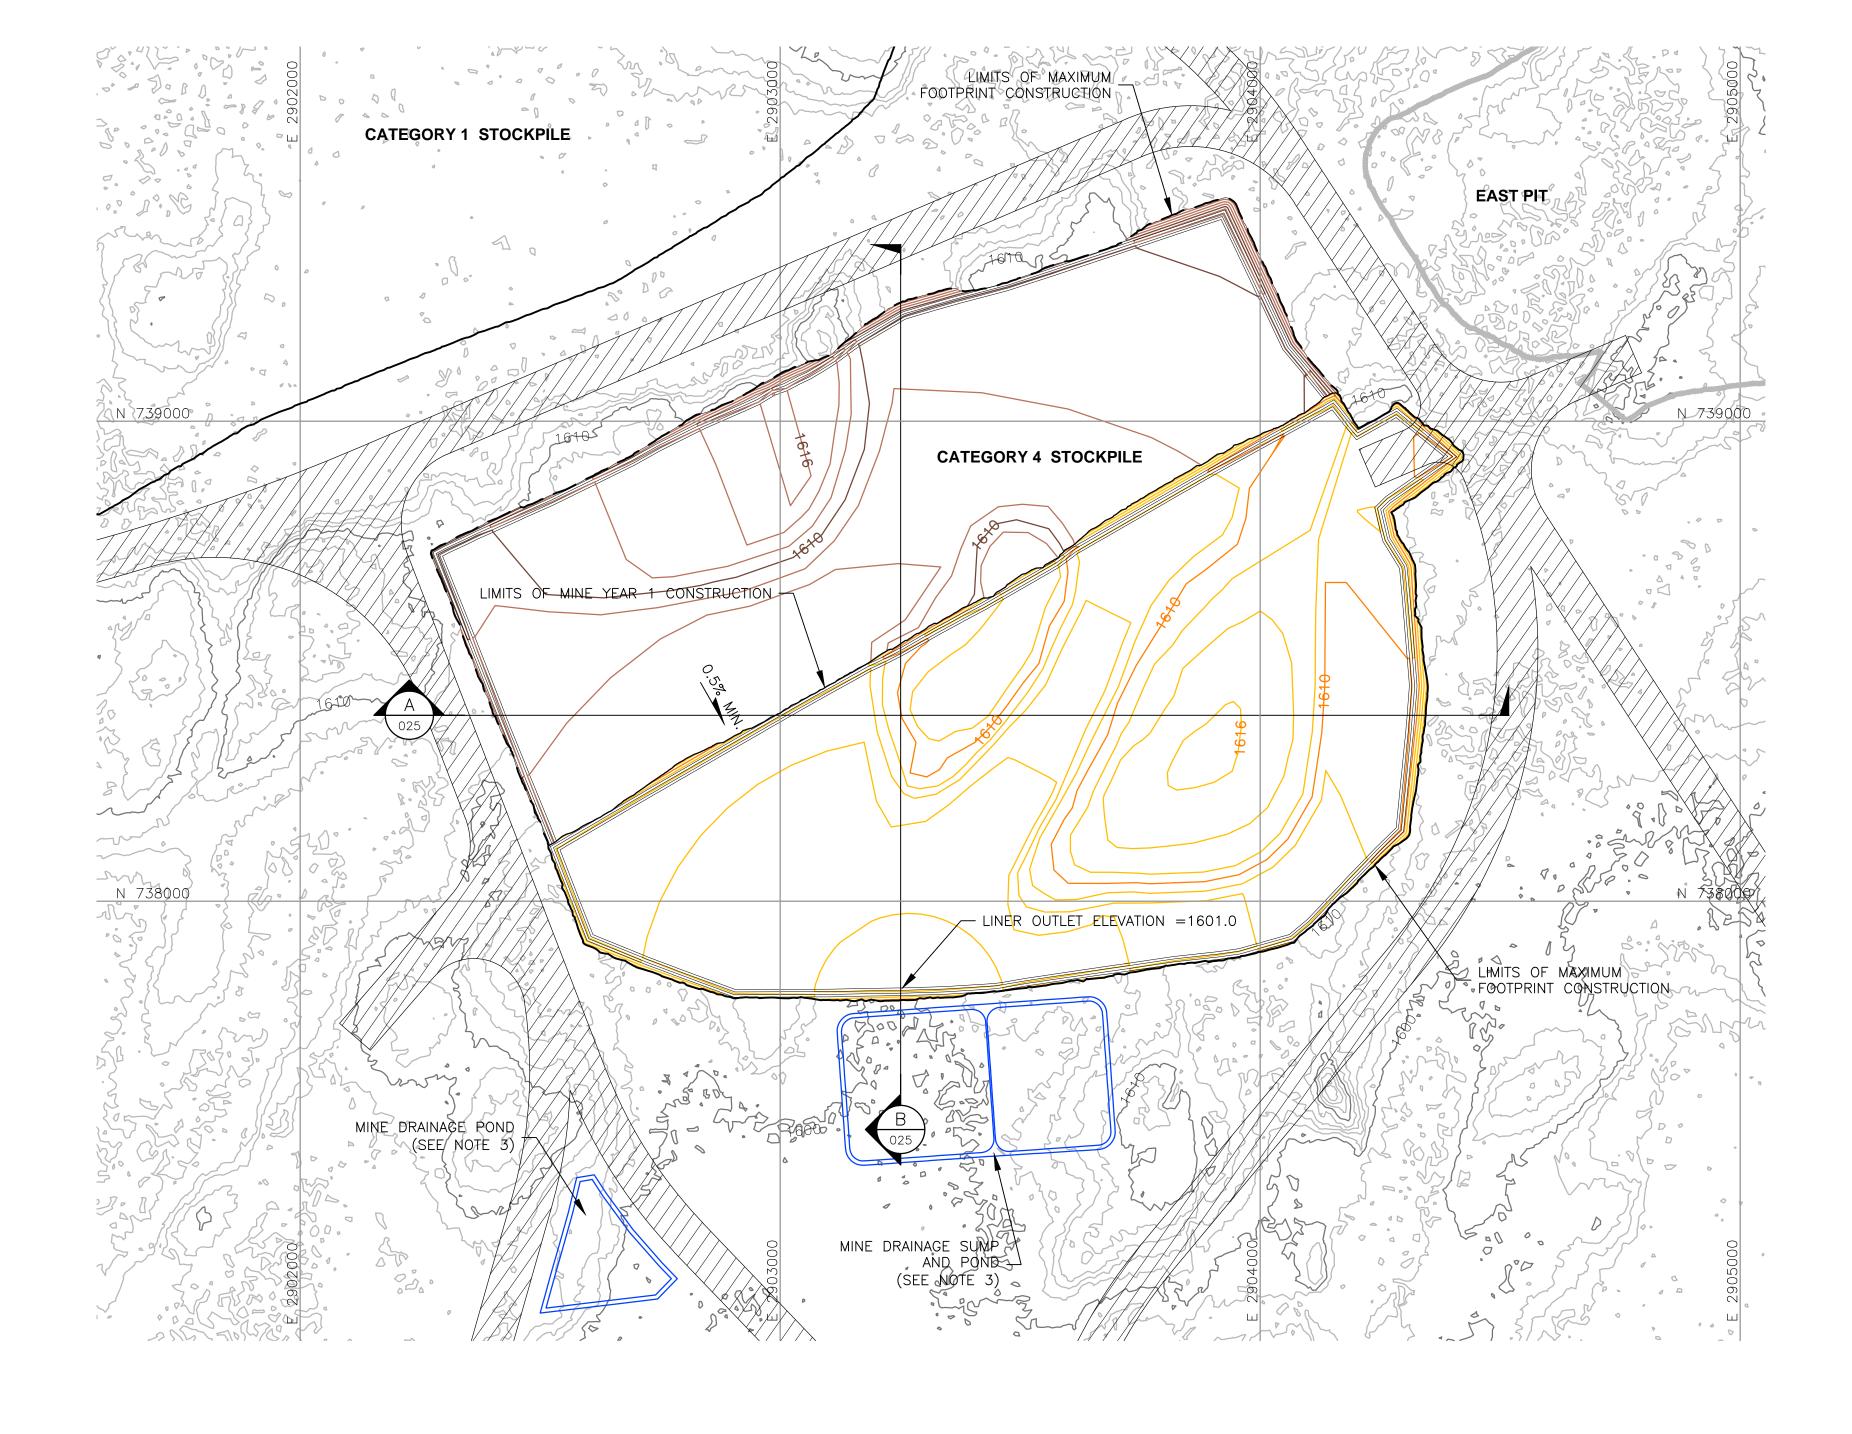

VER DATE

DESCRIPTION

A 12/02/11 ISSUED FOR REVIEW FOR INCLUSION IN ROCK AND OVERBURDEN MANAGEMENT PLAN (ROMP)

B 2/15/13 ISSUED FOR REVIEW FOR INCLUSION IN ROMP

C 5/29/13 ISSUED FOR REVIEW FOR INCLUSION IN ROMP

E 4/10/15 ISSUED FOR INCLUSION IN PERMIT APPLICATIONS

F | 5/22/15 | ISSUED FOR INCLUSION IN PERMIT APPLICATIONS

D 1/14/14 ISSUED FOR AGENCY REVIEW

# **LEGEND**

EXISTING GROUND TOPOGRAPHY (SEE

REFERENCE 1)

PROPOSED MINE YEAR 1 GRADING TOPOGRAPHY PROPOSED MAXIMUM FOOTPRINT GRADING TOPOGRAPHY

- MINE SITE BOUNDARY

- CROSS SECTION IDENTIFIER

SLOPE

- SHEET WHERE SECTION IS LOCATED

MINE YEAR 1 WASTE ROCK STOCKPILE

OUTLINES (SEE NOTE 2)

MAXIMUM WASTE ROCK STOCKPILE OUTLINES (SEE NOTE 2)

HAUL ROAD

MINE YEAR 2 PIT BOUNDARIES (SEE NOTE 1)

MINE DRAINAGE SUMP/POND (SEE NOTE 3)

# **NOTES**

OPEN PIT AND HAUL ROAD LAYOUTS PROVIDED BY BARR ENGINEERING IN OCTOBER 2011.

2. STOCKPILE LAYOUTS PROVIDED BY BARR ENGINEERING IN APRIL 2011

- AND MODIFIED BY GOLDER.
- 3. SEE MECHANICAL INFRASTRUCTURE PERMIT SUPPORT DRAWINGS.
- 4. SEE GENERAL NOTES AND LEGEND ON DRAWING 002.

# **REFERENCES**

PLANT DRAWING NUMBER:

ISSUE STATUS

VERSION

DATE

ISSUED

PERMITTING

CONSTRUCTION

NOT APPROVED FOR CONSTRUCTION.

I HEREBY CERTIFY THAT THIS PLAN,
SPECIFICATION, OR REPORT WAS
PREPARED BY ME OR UNDER MY DIRECT
SUPERVISION AND THAT I AM A DULY
LICENSED PROFESSIONAL ENGINEER
UNDER THE LAWS OF THE STATE OF
MINNESOTA.

Honson

PRINTED NAME BRENT R. BRONSON

DATE <u>5/22/15</u> LICENSE # 46492

SIGNATURE \_\_\_\_

DRAWN:

CHECKED:

SCALE:

MTM

AS SHOWN

- 1. EXISTING GROUND TOPOGRAPHY PROVIDED BY BARR ENGINEERING, AUGUST 2011.
- 2. COORDINATE SYSTEM REFERENCE IS NAD83 MINNESOTA STATE PLANE
- 3. VERTICAL DATUM REFERENCE IS FEET ABOVE MEAN SEA LEVEL (AMSL).

CATEGORY 4 STOCKPILE FOUNDATION GRADING PLAN MINE YEAR 1 AND MAXIMUM

¥ POLY MET MINING, INC. NORTHMET PROJECT


POLYMET HOYT LAKES, MINNESOTA

GOLDER ASSOCIATES INC. 44 UNION BOULEVARD, SUITE 300 LAKEWOOD, CO USA 80233 Ph: (303) 980-0540 Fax: (303) 985-2080


REV

GOLDER PROJECT NO.: Associates 113-2209 DWG. NO.

www.golder.com SKP-021

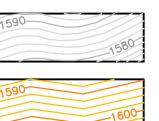

EXISTING GROUND TOPOGRAPHY

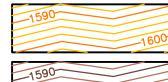

PROPOSED MINE YEAR 1 GRADING TOPOGRAPHY

PROPOSED MAXIMUM FOOTPRINT GRADING TOPOGRAPHY

----- MINE SITE BOUNDARY

MINE YEAR 2 PIT BOUNDARIES (SEE NOTE 1)

MINE YEAR 1 WASTE ROCK STOCKPILE OUTLINES (SEE NOTE 2)

MAXIMUM WASTE ROCK STOCKPILE OUTLINES (SEE NOTE 2)

HAUL ROADS

TERTIARY COLLECTION PIPING (SEE NOTE 3)

4-INCH

SECONDARY COLLECTION PIPING (SEE NOTE 3)

6-INCH

# **NOTES**

- 1. OPEN PIT AND HAUL ROAD LAYOUTS PROVIDED BY BARR ENGINEERING IN OCTOBER 2011.
- 2. STOCKPILE LAYOUTS PROVIDED BY BARR ENGINEERING IN APRIL 2011 AND MODIFIED BY GOLDER.
- 3. ACTUAL NUMBER AND LOCATION OF UNDERDRAIN PIPES AND SUMPS WILL NEED TO BE DETERMINED DURING CONSTRUCTION BASED ON ENCOUNTERED FIELD CONDITIONS.
- 4. SEE GENERAL NOTES AND LEGEND ON DRAWING 002.

#### REFERENCES

PLANT DRAWING NUMBER:

- 1. EXISTING GROUND TOPOGRAPHY PROVIDED BY BARR ENGINEERING, AUGUST 2011.
- 2. COORDINATE SYSTEM REFERENCE IS NAD83 MINNESOTA STATE PLANE
- 3. VERTICAL DATUM REFERENCE IS FEET ABOVE MEAN SEA LEVEL (AMSL).

CATEGORY 4 STOCKPILE

UNDERDRAIN PIPING PLAN MINE YEAR 1 AND MAXIMUM

> POLY MET MINING, INC. NORTHMET PROJECT

GOLDER ASSOCIATES INC. 44 UNION BOULEVARD, SUITE 300 LAKEWOOD, CO USA 80233 Ph: (303) 980-0540 Fax: (303) 985-2080

REV

¥

POLYMET

HOYT LAKES, MINNESOTA

www.golder.com



VER DATE ISSUE STATUS DESCRIPTION A 12/02/11 ISSUED FOR REVIEW FOR INCLUSION IN ROCK AND OVERBURDEN MANAGEMENT PLAN (ROMP) ISSUED VERSION B 2/15/13 ISSUED FOR REVIEW FOR INCLUSION IN ROMP C 5/29/13 ISSUED FOR REVIEW FOR INCLUSION IN ROMP PERMITTING D 1/14/14 ISSUED FOR AGENCY REVIEW E 4/10/15 ISSUED FOR INCLUSION IN PERMIT APPLICATIONS F | 5/22/15 | ISSUED FOR INCLUSION IN PERMIT APPLICATIONS CONSTRUCTION

I HEREBY CERTIFY THAT THIS PLAN,
SPECIFICATION, OR REPORT WAS
PREPARED BY ME OR UNDER MY DIRECT
SUPERVISION AND THAT I AM A DULY
LICENSED PROFESSIONAL ENGINEER
UNDER THE LAWS OF THE STATE OF
MINNESOTA. Deronsen SIGNATURE 🚄 PRINTED NAME BRENT R. BRONSON DATE <u>5/22/15</u> LICENSE # 46492

DATE

NOT APPROVED FOR CONSTRUCTION.

GOLDER PROJECT NO.:


113-2209 SCALE: AS SHOWN


DRAWN:

CHECKED:

MTM

DWG. NO. SKP-022

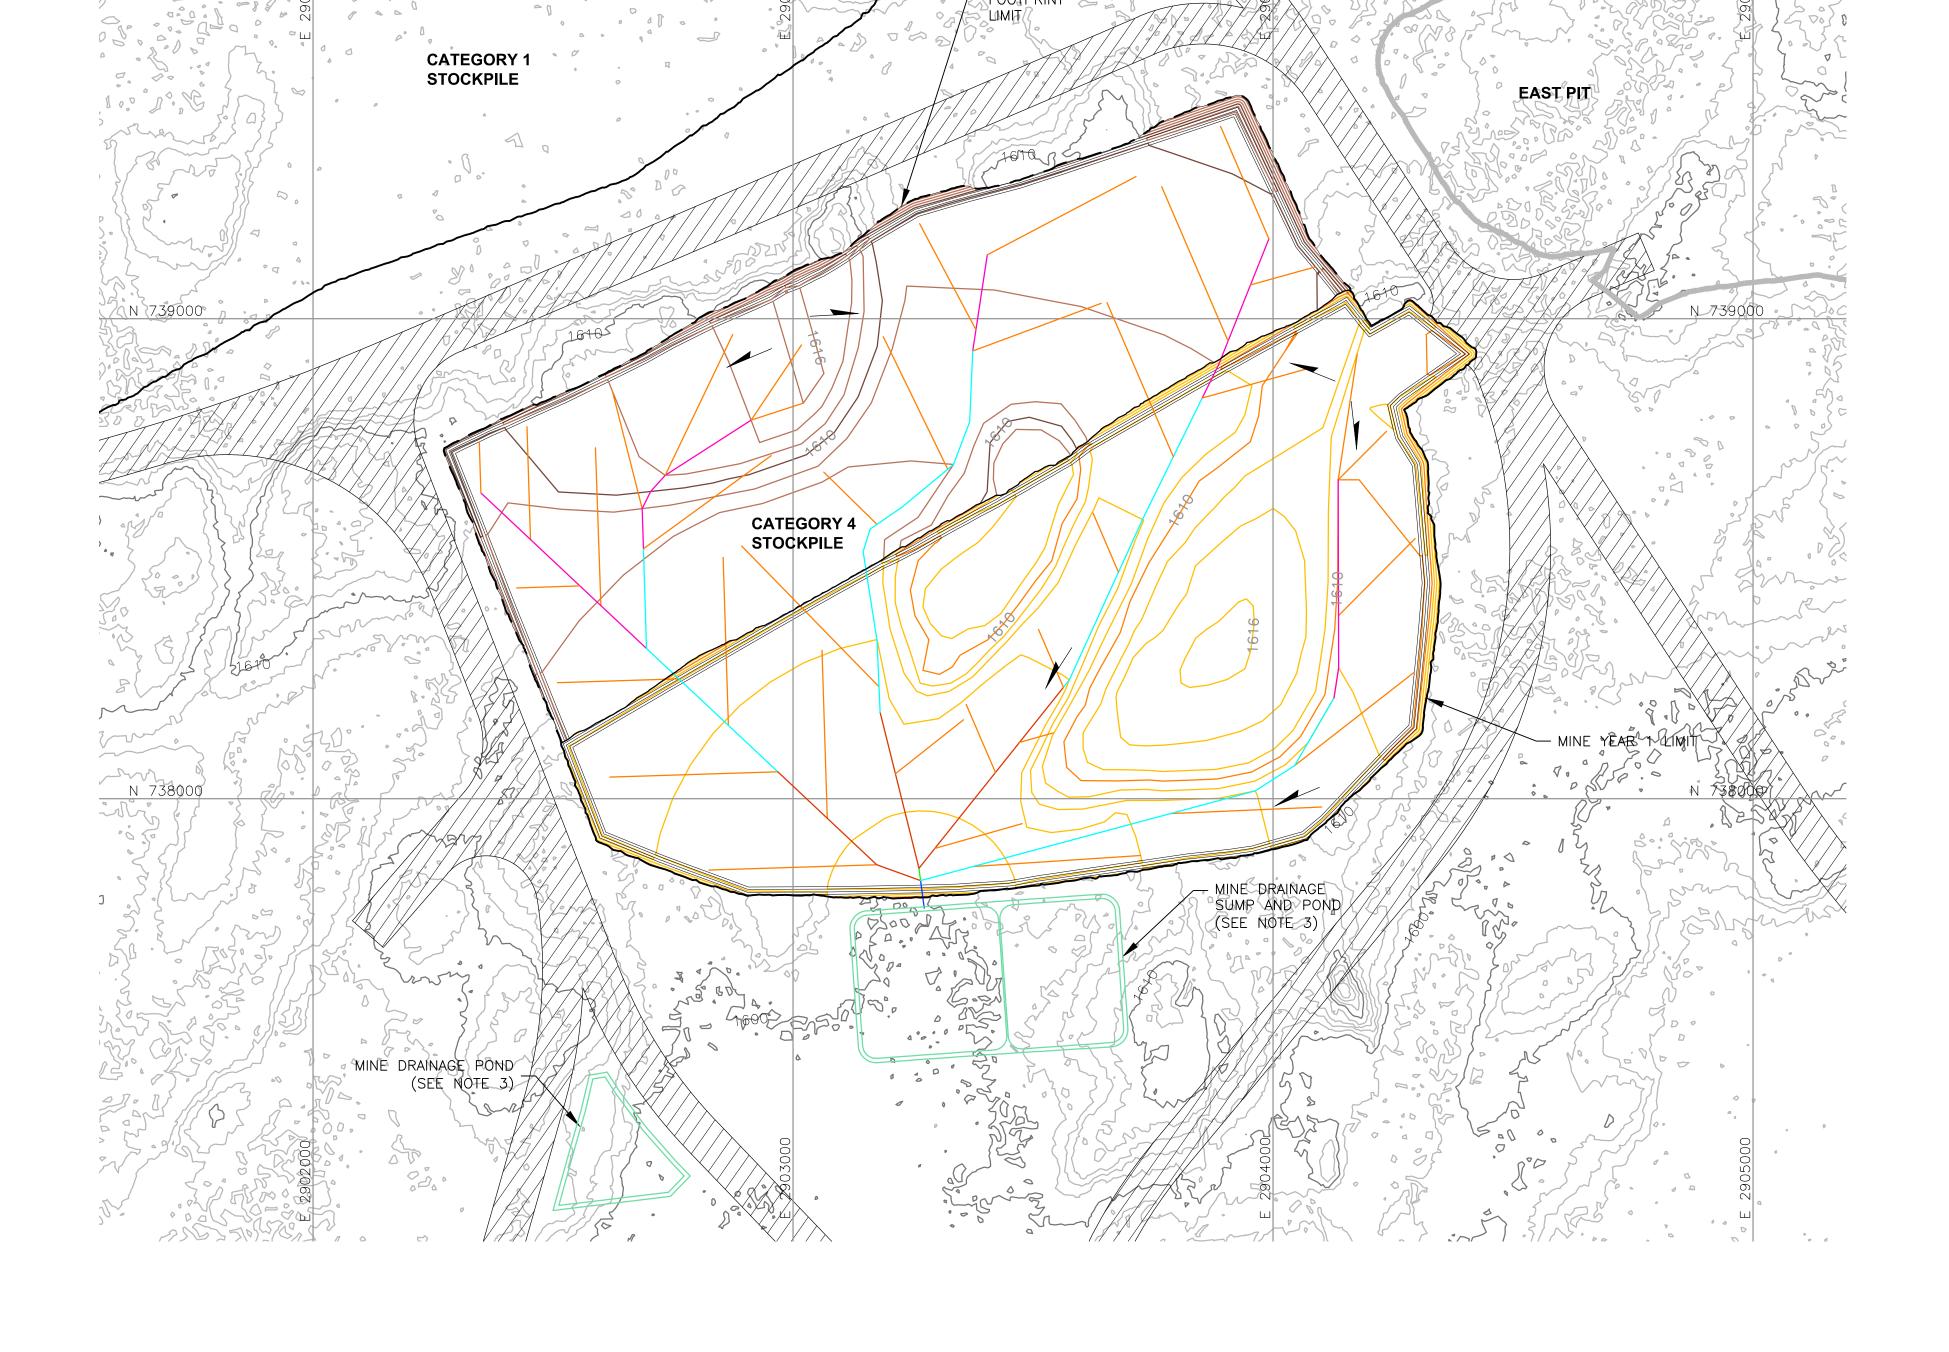

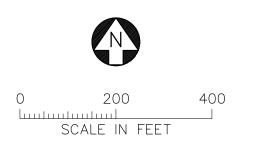

VEF NO	DATE	DESCRIPTION		ISSUE STATUS		
Α	12/02/11	ISSUED FOR REVIEW FOR INCLUSION IN ROCK AND OVERBURDEN MANAGEMENT PLAN (ROMP)	ISSUED	VERSION	DATE	   HEREBY CERTIFY THAT THIS PLAN,
В	2/15/13	ISSUED FOR REVIEW FOR INCLUSION IN ROMP				SPECIFICATION, OR REPORT WAS PREPARED BY ME OR UNDER MY DIRECT
С	5/29/13	ISSUED FOR REVIEW FOR INCLUSION IN ROMP	] FOR _ PERMITTING	F	5-22-15	SUPERVISION AND THAT I AM A DULY LICENSED PROFESSIONAL ENGINEER
D	1/14/14	ISSUED FOR AGENCY REVIEW				UNDER THE LAWS OF THE STATE OF MINNESOTA.
Ε	4/10/15	ISSUED FOR INCLUSION IN PERMIT APPLICATIONS				18
F	5/22/15	ISSUED FOR INCLUSION IN PERMIT APPLICATIONS	] FOR   CONSTRUCTION			SIGNATURE
						PRINTED NAME BRENT R. BRONSON
			NOT APPROVED FOR			DATE <u>5/22/15</u> LICENSE # 46492
			→ CONSTRUCTION.			

DRAWN: MTM CHECKED:

AS SHOWN

CERTIFY THAT THIS PLAN,
ATION, OR REPORT WAS
BY ME OR UNDER MY DIRECT
ION AND THAT I AM A DULY
PROFESSIONAL ENGINEER
HE LAWS OF THE STATE OF GOLDER PROJECT NO.: 113-2209 SCALE:

DWG. NO.

 $P \bigcirc L \underset{M}{} X \underset{N}{} M E T$ 

SKP-023

HOYT LAKES, MINNESOTA GOLDER ASSOCIATES INC. 44 UNION BOULEVARD, SUITE 300 LAKEWOOD, CO USA 80233 Ph: (303) 980-0540

Fax: (303) 985-2080 www.golder.com

POLY MET MINING, INC.

NORTHMET PROJECT

MINE YEAR 1 - TERTIARY COLLECTION PIPING

MINE YEAR 1 - PRIMARY AND SECONDARY COLLECTION PIPING

TOPOGRAPHY

- - MINE SITE BOUNDARY

EXISTING GROUND TOPOGRAPHY

PROPOSED MINE YEAR 1 GRADING TOPOGRAPHY

PROPOSED MAXIMUM FOOTPRINT GRADING

MINE YEAR 2 PIT BOUNDARIES (SEE NOTE 1)

MINE YEAR 1 WASTE ROCK STOCKPILE OUTLINES (SEE NOTE 2) MAXIMUM WASTE ROCK STOCKPILE — — OUTLINES (SEE NOTE 2) HAUL ROADS

**LEGEND** 

MINE DRAINAGE SUMP/POND (SEE NOTE 3)

4-INCH

- 4-INCH 6-INCH 8-INCH 10-INCH \_\_\_ 12-INCH

# **NOTES**

- 1. OPEN PIT AND HAUL ROAD LAYOUTS PROVIDED BY BARR ENGINEERING IN OCTOBER 2011.
- 2. STOCKPILE LAYOUTS PROVIDED BY BARR ENGINEERING IN APRIL 2011 AND MODIFIED BY GOLDER.
- 3. SEE MECHANICAL INFRASTRUCTURE PERMIT SUPPORT DRAWINGS.
- 4. SEE GENERAL NOTES AND LEGEND ON DRAWING 002.

# **REFERENCES**


PLANT DRAWING NUMBER:


- 1. EXISTING GROUND TOPOGRAPHY PROVIDED BY BARR ENGINEERING, AUGUST 2011.
- 2. COORDINATE SYSTEM REFERENCE IS NAD83 MINNESOTA STATE PLANE
- 3. VERTICAL DATUM REFERENCE IS FEET ABOVE MEAN SEA LEVEL (AMSL).

CATEGORY 4 STOCKPILE

OVERLINER DRAINAGE PIPING PLAN

MINE YEAR 1 AND MAXIMUM

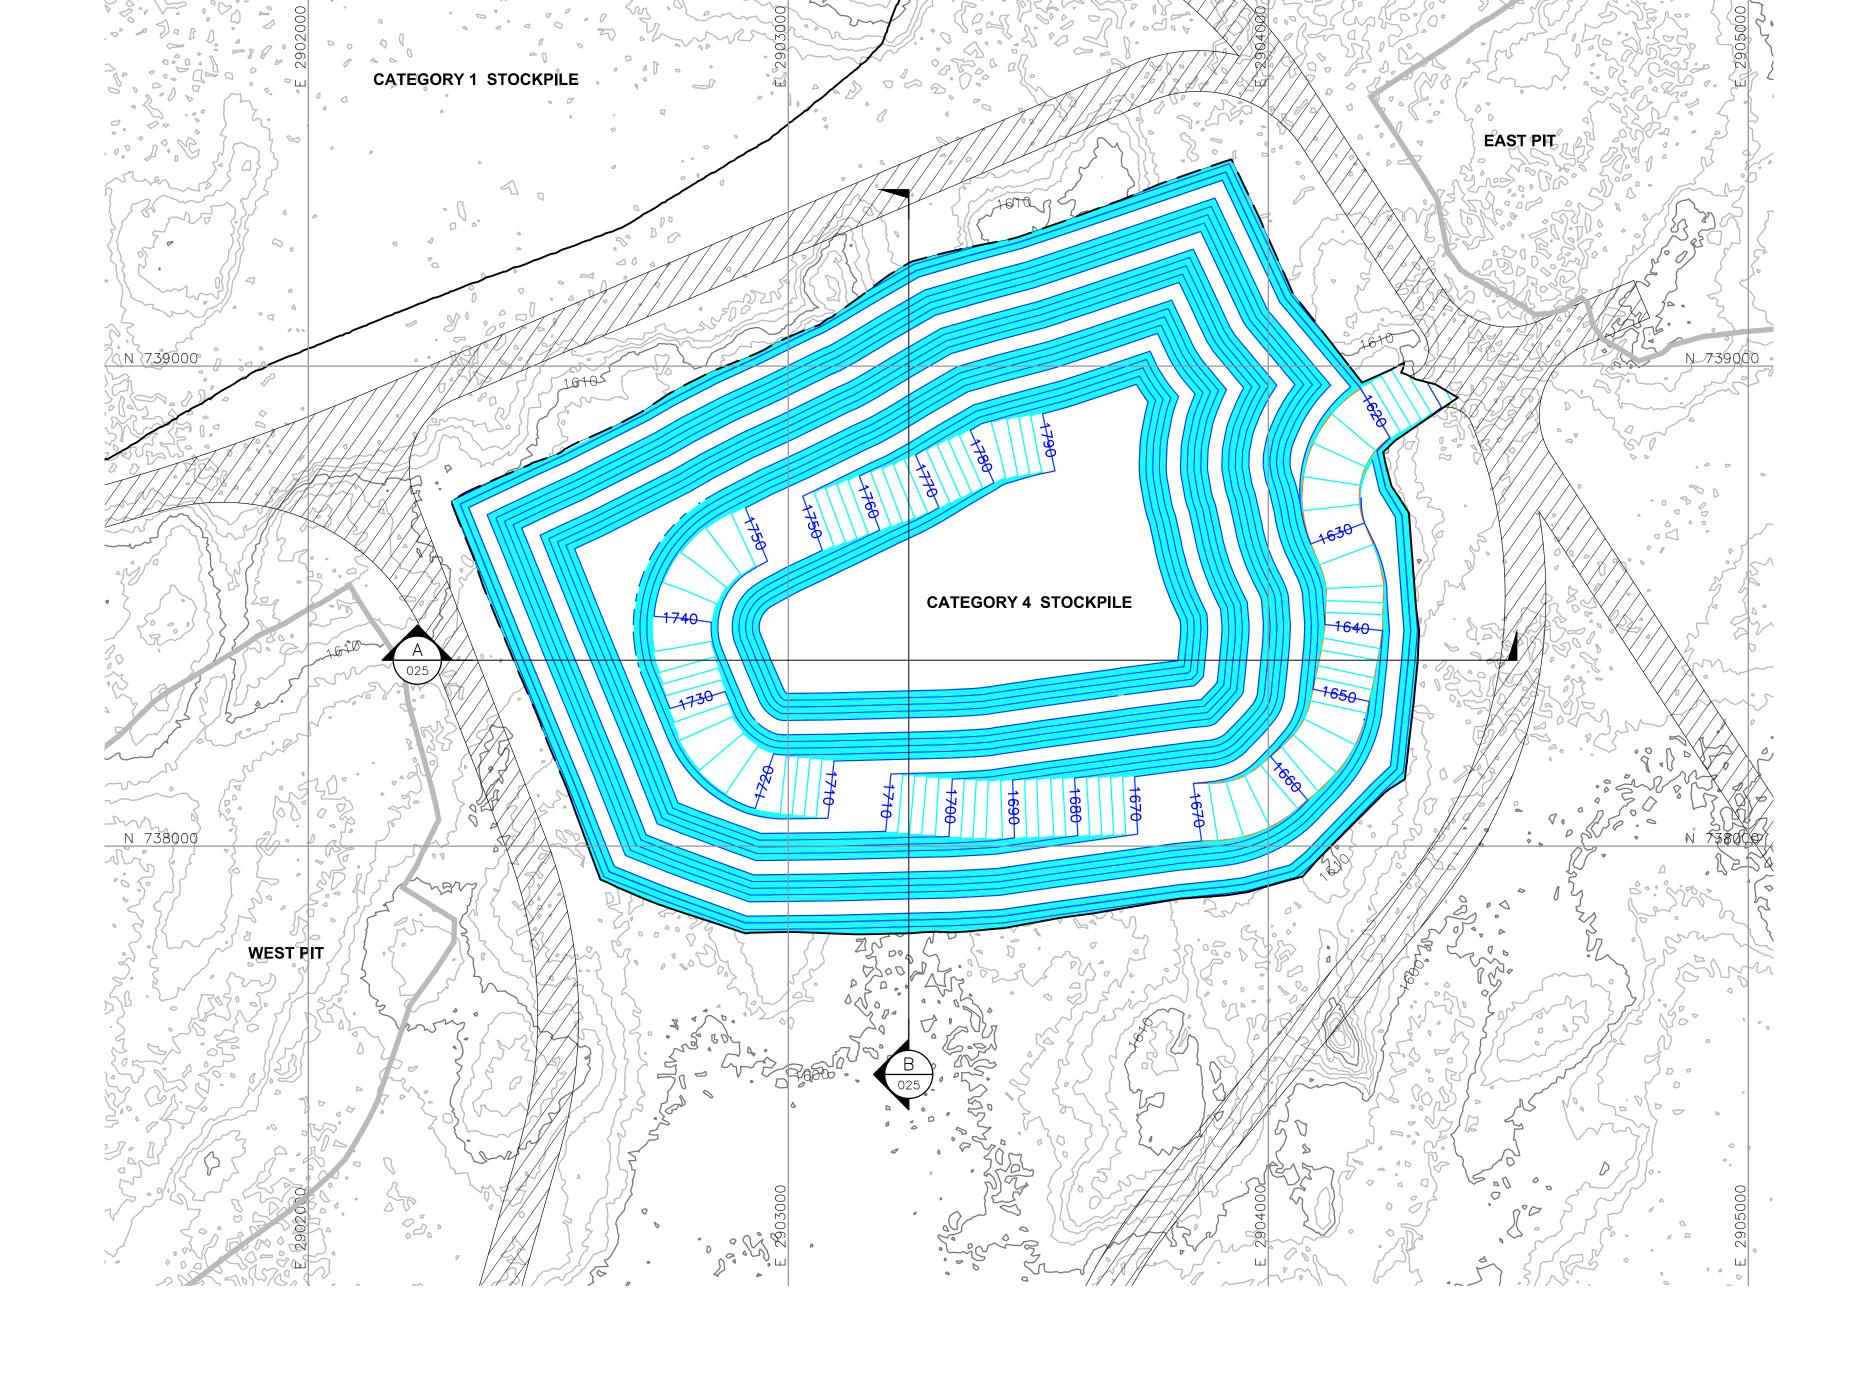

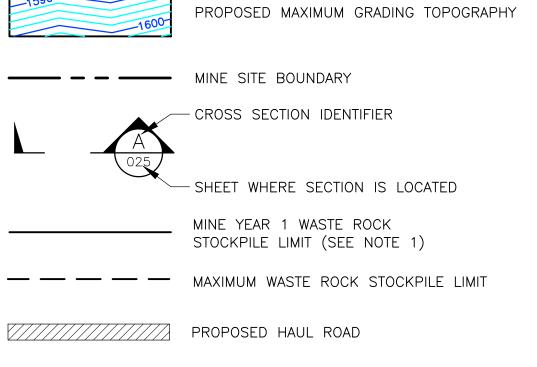

MINE YEAR 11 PIT BOUNDARIES (SEE NOTE 1)

EXISTING GROUND TOPOGRAPHY

(SEE REFERENCE 1)

**LEGEND** 

#### **NOTES**

- 1. OPEN PIT AND HAUL ROAD LAYOUTS PROVIDED BY BARR ENGINEERING IN OCTOBER 2011.
- 2. STOCKPILE LAYOUTS PROVIDED BY BARR ENGINEERING IN APRIL 2011 AND MODIFIED BY GOLDER.
- 3. SEE GENERAL NOTES AND LEGEND ON DRAWING 002.

# **REFERENCES**

- 1. EXISTING GROUND TOPOGRAPHY PROVIDED BY BARR ENGINEERING, AUGUST 2011.
- 2. COORDINATE SYSTEM REFERENCE IS NAD83 MINNESOTA STATE PLANE
- 3. VERTICAL DATUM REFERENCE IS FEET ABOVE MEAN SEA LEVEL (AMSL).

PLANT DRAWING NUMBER:

CATEGORY 4 STOCKPILE STOCKPILE MAXIMUM CAPACITY CONFIGURATION

POLY MET MINING, INC. NORTHMET PROJECT HOYT LAKES, MINNESOTA

 $\mathbb{P} \underset{\scriptscriptstyle{M}}{\mathsf{OL}} \underset{\scriptscriptstyle{K}}{\mathsf{Y}} \underset{\scriptscriptstyle{K}}{\mathsf{M}} \underset{\scriptscriptstyle{K}}{\mathsf{E}} \mathbb{T}$ 

GOLDER ASSOCIATES INC. 44 UNION BOULEVARD, SUITE 300 LAKEWOOD, CO USA 80233 Ph: (303) 980-0540

Fax: (303) 985-2080 www.golder.com

SCALE IN FEET

ISSUE STATUS DESCRIPTION A 12/02/11 ISSUED FOR REVIEW FOR INCLUSION IN ROCK AND OVERBURDEN MANAGEMENT PLAN (ROMP) ISSUED VERSION DATE I HEREBY CERTIFY THAT THIS PLAN,
SPECIFICATION, OR REPORT WAS
PREPARED BY ME OR UNDER MY DIRECT
SUPERVISION AND THAT I AM A DULY
LICENSED PROFESSIONAL ENGINEER B 2/15/13 ISSUED FOR REVIEW FOR INCLUSION IN ROMP 5-22-15 C | 5/29/13 | ISSUED FOR REVIEW FOR INCLUSION IN ROMP PERMITTING D | 1/14/14 | ISSUED FOR AGENCY REVIEW MINNESOTA. E 4/10/15 ISSUED FOR INCLUSION IN PERMIT APPLICATIONS SIGNATURE \_\_\_\_ 5/22/15 ISSUED FOR INCLUSION IN PERMIT APPLICATIONS CONSTRUCTION NOT APPROVED FOR CONSTRUCTION.

UNDER THE LAWS OF THE STATE OF CHECKED: Phonsen PRINTED NAME BRENT R. BRONSON DATE <u>5/22/15</u> LICENSE # 46492

GOLDER PROJECT NO.: 113-2209 SCALE:

DRAWN:


MTM

AS SHOWN

SKP-024

AS SHOWN

1850 WEST

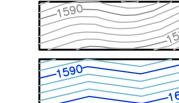

EXISTING GROUND TOPOGRAPHY (SEE

REFERENCE 1) PROPOSED MINE YEAR 1 EXCAVATION TOPOGRAPHY

-- MINE SITE BOUNDARY

MINE YEAR 1 ORE STOCKPILE OUTLINES (SEE NOTE 2)

HAUL ROADS



- CROSS SECTION IDENTIFIER

SHEET WHERE SECTION IS LOCATED

# **NOTES**

- 1. OPEN PIT AND HAUL ROAD LAYOUTS PROVIDED BY BARR ENGINEERING IN OCTOBER 2011.
- 2. STOCKPILE LAYOUTS PROVIDED BY BARR ENGINEERING IN APRIL 2011 AND MODIFIED BY GOLDER.
- 3. SEE GENERAL NOTES AND LEGEND ON DRAWING 002.

# **REFERENCES**

- 1. EXISTING GROUND TOPOGRAPHY PROVIDED BY BARR ENGINEERING, AUGUST 2011.
- 2. COORDINATE SYSTEM REFERENCE IS NAD83 MINNESOTA STATE PLANE
- 3. VERTICAL DATUM REFERENCE IS FEET ABOVE MEAN SEA LEVEL (AMSL).

PLANT DRAWING NUMBER:

ORE SURGE PILE SUBGRADE EXCAVATION PLAN

 $\mathbb{P} \underset{\scriptscriptstyle{M}}{\mathsf{OL}} \underset{\scriptscriptstyle{X}}{\mathsf{Y}} \underset{\scriptscriptstyle{N}}{\mathsf{M}} \underset{\scriptscriptstyle{G}}{\mathsf{E}} \mathbb{T}$ 

POLY MET MINING, INC. NORTHMET PROJECT HOYT LAKES, MINNESOTA

GOLDER ASSOCIATES INC. 44 UNION BOULEVARD, SUITE 300 LAKEWOOD, CO USA 80233 Ph: (303) 980-0540 Fax: (303) 985-2080 www.golder.com

A | 12/02/11 ISSUED FOR REVIEW FOR INCLUSION IN ROCK AND OVERBURDEN MANAGEMENT PLAN (ROMP) ISSUED VERSION DATE B 2/15/13 ISSUED FOR REVIEW FOR INCLUSION IN ROMP C 5/29/13 ISSUED FOR REVIEW FOR INCLUSION IN ROMP 5-22-15 PERMITTING D 1/14/14 ISSUED FOR AGENCY REVIEW 4/10/15 ISSUED FOR INCLUSION IN PERMIT APPLICATIONS 5/22/15 ISSUED FOR INCLUSION IN PERMIT APPLICATIONS CONSTRUCTION NOT APPROVED FOR CONSTRUCTION.

LIMITS OF LINER CONSTRUCTION

ORE SURGE PILE

RAILROAD SPUR

DESCRIPTION

BEDROCK EXCAVATION AREA -

LIMITS OF EXCAVATION

LIMITS OF BEDROCK

CATEGORY 2/3

STOCKPILE BOUNDARY

ISSUE STATUS

I HEREBY CERTIFY THAT THIS PLAN,
SPECIFICATION, OR REPORT WAS
PREPARED BY ME OR UNDER MY DIRECT
SUPERVISION AND THAT I AM A DULY
LICENSED PROFESSIONAL ENGINEER DRAWN: MTM UNDER THE LAWS OF THE STATE OF MINNESOTA. SIGNATURE\_\_\_\_ PRINTED NAME BRENT R. BRONSON

DATE <u>5/22/15</u> LICENSE # 46492

CHECKED: 113-2209

GOLDER PROJECT NO.: SCALE:


AS SHOWN

SKP-026


RAIL TRANSFER

HOPPER

SCALE IN FEET

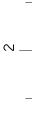



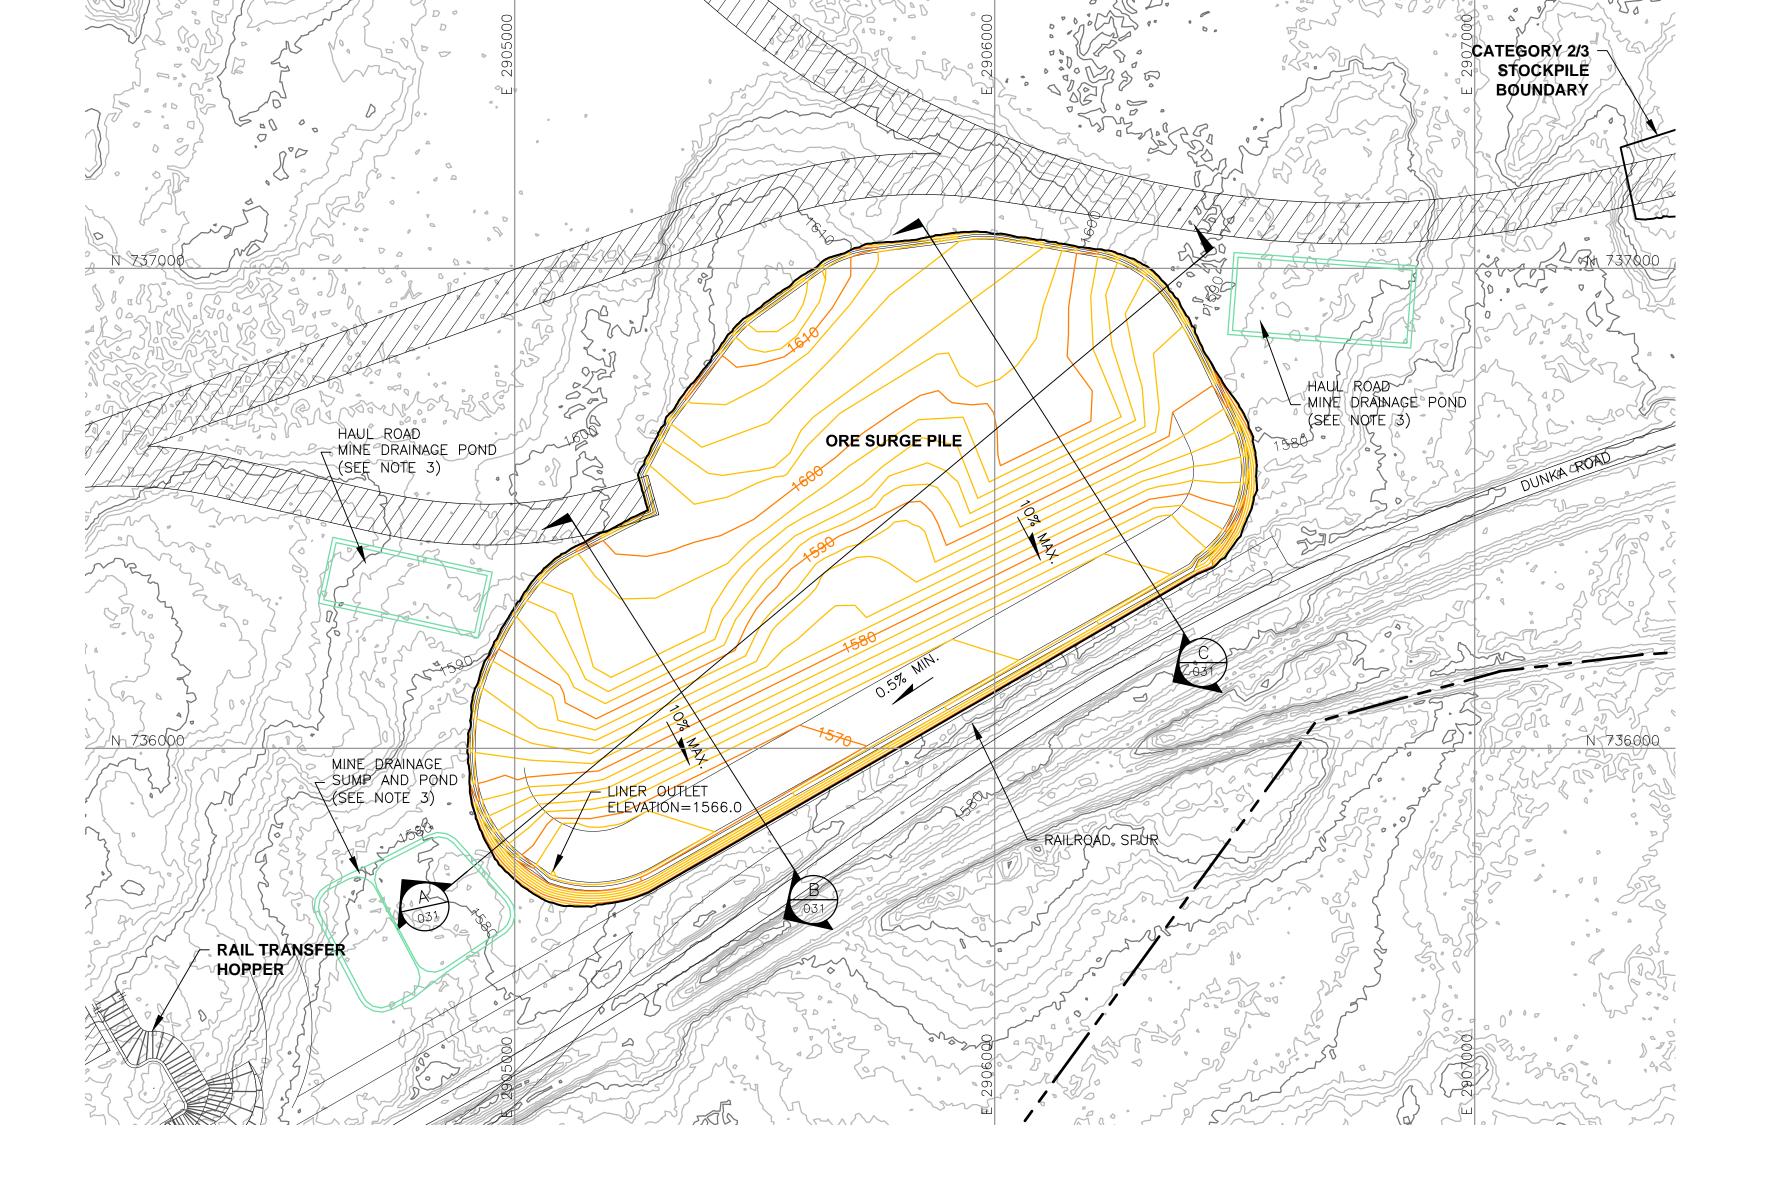

DESCRIPTION

A | 12/02/11 ISSUED FOR REVIEW FOR INCLUSION IN ROCK AND OVERBURDEN MANAGEMENT PLAN (ROMP)

B 2/15/13 ISSUED FOR REVIEW FOR INCLUSION IN ROMP

C 5/29/13 ISSUED FOR REVIEW FOR INCLUSION IN ROMP

4/10/15 ISSUED FOR INCLUSION IN PERMIT APPLICATIONS

5/22/15 ISSUED FOR INCLUSION IN PERMIT APPLICATIONS

D 1/14/14 ISSUED FOR AGENCY REVIEW

ISSUE STATUS

VERSION

DATE

5-22-15

MINNESOTA.

SIGNATURE \_\_\_\_

ISSUED

PERMITTING

CONSTRUCTION

NOT APPROVED FOR CONSTRUCTION.

# **LEGEND**

EXISTING GROUND TOPOGRAPHY (SEE REFERENCE 1)

PROPOSED MINE YEAR 1 GRADING TOPOGRAPHY

MINE SITE BOUNDARY - CROSS SECTION IDENTIFIER

- SHEET WHERE SECTION IS LOCATED

SLOPE

MINE YEAR 1 ORE, WASTE ROCK STOCKPILE OUTLINES (SEE NOTE 2)

HAUL ROADS

MINE DRAINAGE SUMP/POND (SEE NOTE 3)

# **NOTES**

- 1. OPEN PIT AND HAUL ROAD LAYOUTS PROVIDED BY BARR ENGINEERING IN OCTOBER 2011.
- 2. STOCKPILE LAYOUTS PROVIDED BY BARR ENGINEERING IN APRIL 2011 AND MODIFIED BY GOLDER.
- 3. SEE MECHANICAL INFRASTRUCTURE PERMIT SUPPORT DRAWINGS.
- 4. SEE GENERAL NOTES AND LEGEND ON DRAWING 002.

# **REFERENCES**

- 1. EXISTING GROUND TOPOGRAPHY PROVIDED BY BARR ENGINEERING, AUGUST 2011.
- 2. COORDINATE SYSTEM REFERENCE IS MINNESOTA STATE PLANE.
- 3. VERTICAL DATUM REFERENCE IS FEET ABOVE MEAN SEA LEVEL (AMSL).

PLANT DRAWING NUMBER:

# ORE SURGE PILE FOUNDATION GRADING PLAN



POLY MET MINING, INC. NORTHMET PROJECT HOYT LAKES, MINNESOTA

GOLDER ASSOCIATES INC. 44 UNION BOULEVARD, SUITE 300 LAKEWOOD, CO USA 80233 Ph: (303) 980-0540 Fax: (303) 985-2080 www.golder.com

I HEREBY CERTIFY THAT THIS PLAN,
SPECIFICATION, OR REPORT WAS
PREPARED BY ME OR UNDER MY DIRECT
SUPERVISION AND THAT I AM A DULY
LICENSED PROFESSIONAL ENGINEER UNDER THE LAWS OF THE STATE OF CHECKED: GOLDER PROJECT NO.: PRINTED NAME BRENT R. BRONSON 113-2209 DATE <u>5/22/15</u> LICENSE # 46492 SCALE:

AS SHOWN

DRAWN:

MTM

DWG. NO.

SKP-027

SCALE IN FEET

EXISTING GROUND TOPOGRAPHY



PROPOSED GRADING TOPOGRAPHY

- MINE SITE BOUNDARY

MINE YEAR 1 ORE, WASTE ROCK STOCKPILE OUTLINES (SEE NOTE 2)

HAUL ROADS

TERTIARY COLLECTION PIPING (SEE NOTE 3)

4-INCH

SECONDARY COLLECTION PIPING (SEE NOTE 3) 6-INCH

#### **NOTES**

- 1. OPEN PIT AND HAUL ROAD LAYOUTS PROVIDED BY BARR ENGINEERING IN OCTOBER 2011.
- 2. STOCKPILE LAYOUTS PROVIDED BY BARR ENGINEERING IN APRIL 2011 AND MODIFIED BY GOLDER.
- 3. ACTUAL NUMBER OF UNDERDRAIN PIPES AND SUMPS WILL NEED TO BE DETERMINED DURING CONSTRUCTION BASED ON ENCOUNTERED FIELD
- 2. SEE GENERAL NOTES AND LEGEND ON DRAWING 002.

#### **REFERENCES**

PLANT DRAWING NUMBER:

- 1. EXISTING GROUND TOPOGRAPHY PROVIDED BY BARR ENGINEERING, AUGUST 2011.
- 2. COORDINATE SYSTEM REFERENCE IS NAD83 MINNESOTA STATE PLANE
- 3. VERTICAL DATUM REFERENCE IS FEET ABOVE MEAN SEA LEVEL (AMSL).

ORE SURGE PILE UNDERDRAIN PIPING PLAN

芸 POLYMET

POLY MET MINING, INC. NORTHMET PROJECT

HOYT LAKES, MINNESOTA

GOLDER ASSOCIATES INC. 44 UNION BOULEVARD, SUITE 300 LAKEWOOD, CO USA 80233 Ph: (303) 980-0540 Fax: (303) 985-2080 www.golder.com

REV

SCALE IN FEET

ISSUE STATUS VER DATE DESCRIPTION A 12/02/11 ISSUED FOR REVIEW FOR INCLUSION IN ROCK AND OVERBURDEN MANAGEMENT PLAN (ROMP) I HEREBY CERTIFY THAT THIS PLAN,
SPECIFICATION, OR REPORT WAS
PREPARED BY ME OR UNDER MY DIRECT
SUPERVISION AND THAT I AM A DULY
LICENSED PROFESSIONAL ENGINEER
UNDER THE LAWS OF THE STATE OF
MINNESOTA. ISSUED VERSION DATE B 2/15/13 ISSUED FOR REVIEW FOR INCLUSION IN ROMP DRAWN: C 5/29/13 ISSUED FOR REVIEW FOR INCLUSION IN ROMP PERMITTING D 1/14/14 ISSUED FOR AGENCY REVIEW E 4/10/15 ISSUED FOR INCLUSION IN PERMIT APPLICATIONS SIGNATURE Mension F | 5/22/15 | ISSUED FOR INCLUSION IN PERMIT APPLICATIONS CONSTRUCTION PRINTED NAME BRENT R. BRONSON DATE <u>5/22/15</u> LICENSE # 46492 NOT APPROVED FOR CONSTRUCTION.

CHECKED: GOLDER PROJECT NO.: 113-2209


SCALE:

AS SHOWN

MTM

DWG. NO. SKP-028

Associates

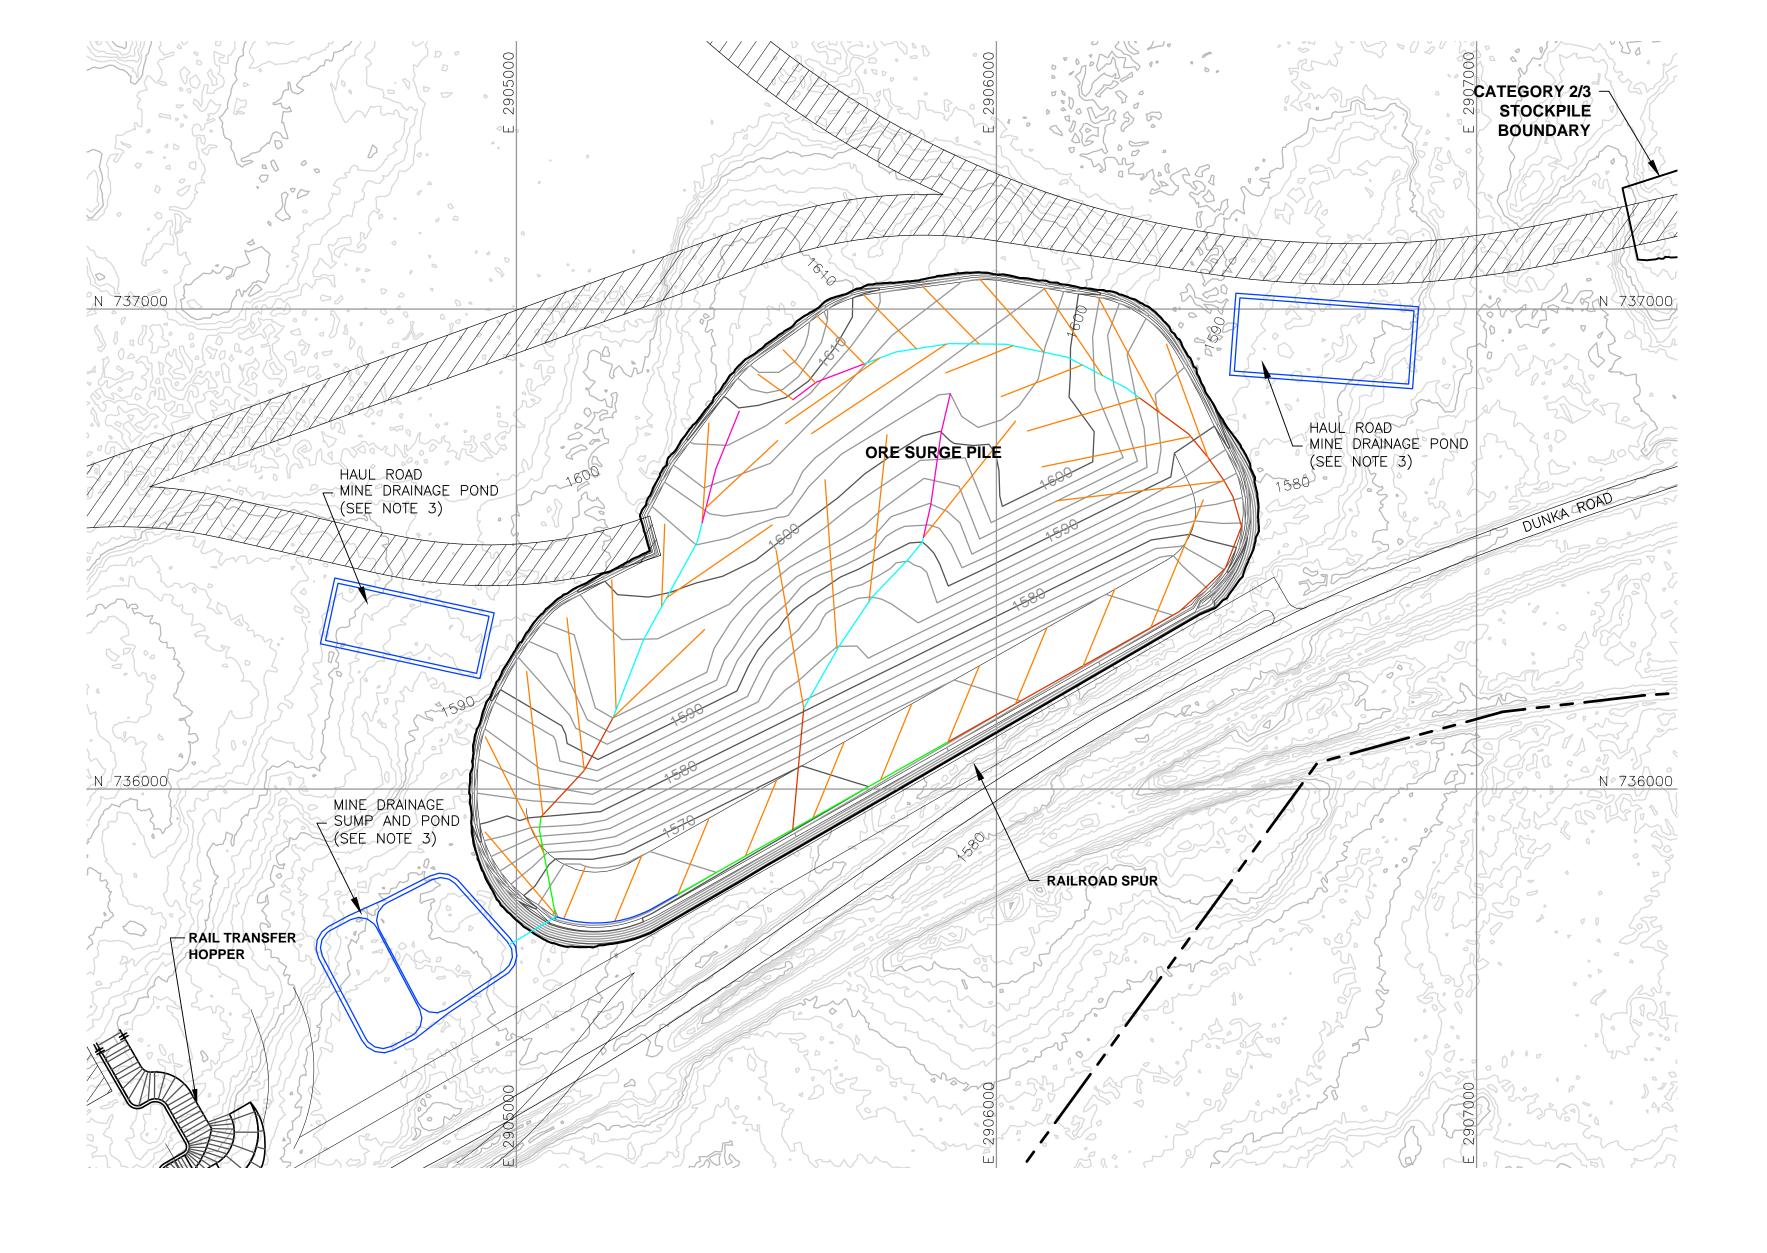

EXISTING GROUND TOPOGRAPHY

PROPOSED GRADING TOPOGRAPHY

- MINE SITE BOUNDARY

MINE YEAR 1 ORE, WASTE ROCK STOCKPILE

OUTLINES (SEE NOTE 2)

HAUL ROADS

MINE DRAINAGE SUMP/POND (SEE NOTE 3)

MINE YEAR 1 - TERTIARY COLLECTION PIPING

\_\_\_\_\_ 4-INCH

MINE YEAR 1 - PRIMARY AND SECONDARY COLLECTION PIPING

6-INCH

--- 4-INCH ---- 8-INCH

> — 10-INCH \_\_\_ 12-INCH

# **NOTES**

- 1. OPEN PIT AND HAUL ROAD LAYOUTS PROVIDED BY BARR ENGINEERING IN OCTOBER 2011.
- 2. STOCKPILE LAYOUTS PROVIDED BY BARR ENGINEERING IN APRIL 2011 AND MODIFIED BY GOLDER.
- 3. SEE MECHANICAL INFRASTRUCTURE PERMIT SUPPORT DRAWINGS.
- 4. SEE GENERAL NOTES AND LEGEND ON DRAWING 002.

#### **REFERENCES**

PLANT DRAWING NUMBER:

- 1. EXISTING GROUND TOPOGRAPHY PROVIDED BY BARR ENGINEERING, AUGUST 2011.
- 2. COORDINATE SYSTEM REFERENCE IS NAD83 MINNESOTA STATE PLANE
- 3. VERTICAL DATUM REFERENCE IS FEET ABOVE MEAN SEA LEVEL (AMSL).

ORE SURGE PILE

OVERLINER DRAINAGE PIPING PLAN



SCALE IN FEET

VER NO	DATE	DESCRIPTION	I	SSUE STATUS			
А	12/02/11	ISSUED FOR REVIEW FOR INCLUSION IN ROCK AND OVERBURDEN MANAGEMENT PLAN (ROMP)	ISSUED	VERSION	DATE	THEREBY CERTIFY THAT THIS PLAN,	
В	2/15/13	ISSUED FOR REVIEW FOR INCLUSION IN ROMP				SPECIFICATION, OR REPORT WAS PREPARED BY ME OR UNDER MY DIRECT	DRAWN:
С	5/29/13	ISSUED FOR REVIEW FOR INCLUSION IN ROMP	T FOR Permitting	F	5-22-15	SUPERVISION AND THAT I AM A DULY LICENSED PROFESSIONAL ENGINEER	MT
D	1/14/14	ISSUED FOR AGENCY REVIEW				UNDER THE LAWS OF THE STATE OF MINNESOTA.	CHECKED:
E	4/10/15	ISSUED FOR INCLUSION IN PERMIT APPLICATIONS				15	
F	5/22/15	ISSUED FOR INCLUSION IN PERMIT APPLICATIONS	FOR CONSTRUCTION			SIGNATURE	GOLDER PR
						PRINTED NAME BRENT R. BRONSON	11
			NOT APPROVED FOR	CONSTRUCTION.		DATE <u>5/22/15</u> LICENSE # 46492	SCALE:
			NOT APPROVED FOR	CONSTRUCTION.		DATE <u>3/22/13</u> LICENSE #46492	SC

DRAWN: CHECKED: GOLDER PROJECT NO.: 113-2209

AS SHOWN

 $\mathbb{P} \bigcirc \mathbb{L} \underset{\text{M I N I N G}}{\mathbb{L}} \mathbb{X} \mathbb{M} \mathbb{E} \mathbb{T}$ 


DWG. NO.

吾 POLY MET MINING, INC. NORTHMET PROJECT HOYT LAKES, MINNESOTA

GOLDER ASSOCIATES INC. 44 UNION BOULEVARD, SUITE 300 LAKEWOOD, CO USA 80233 Ph: (303) 980-0540 Fax: (303) 985-2080 www.golder.com

Associates SKP-029

REV

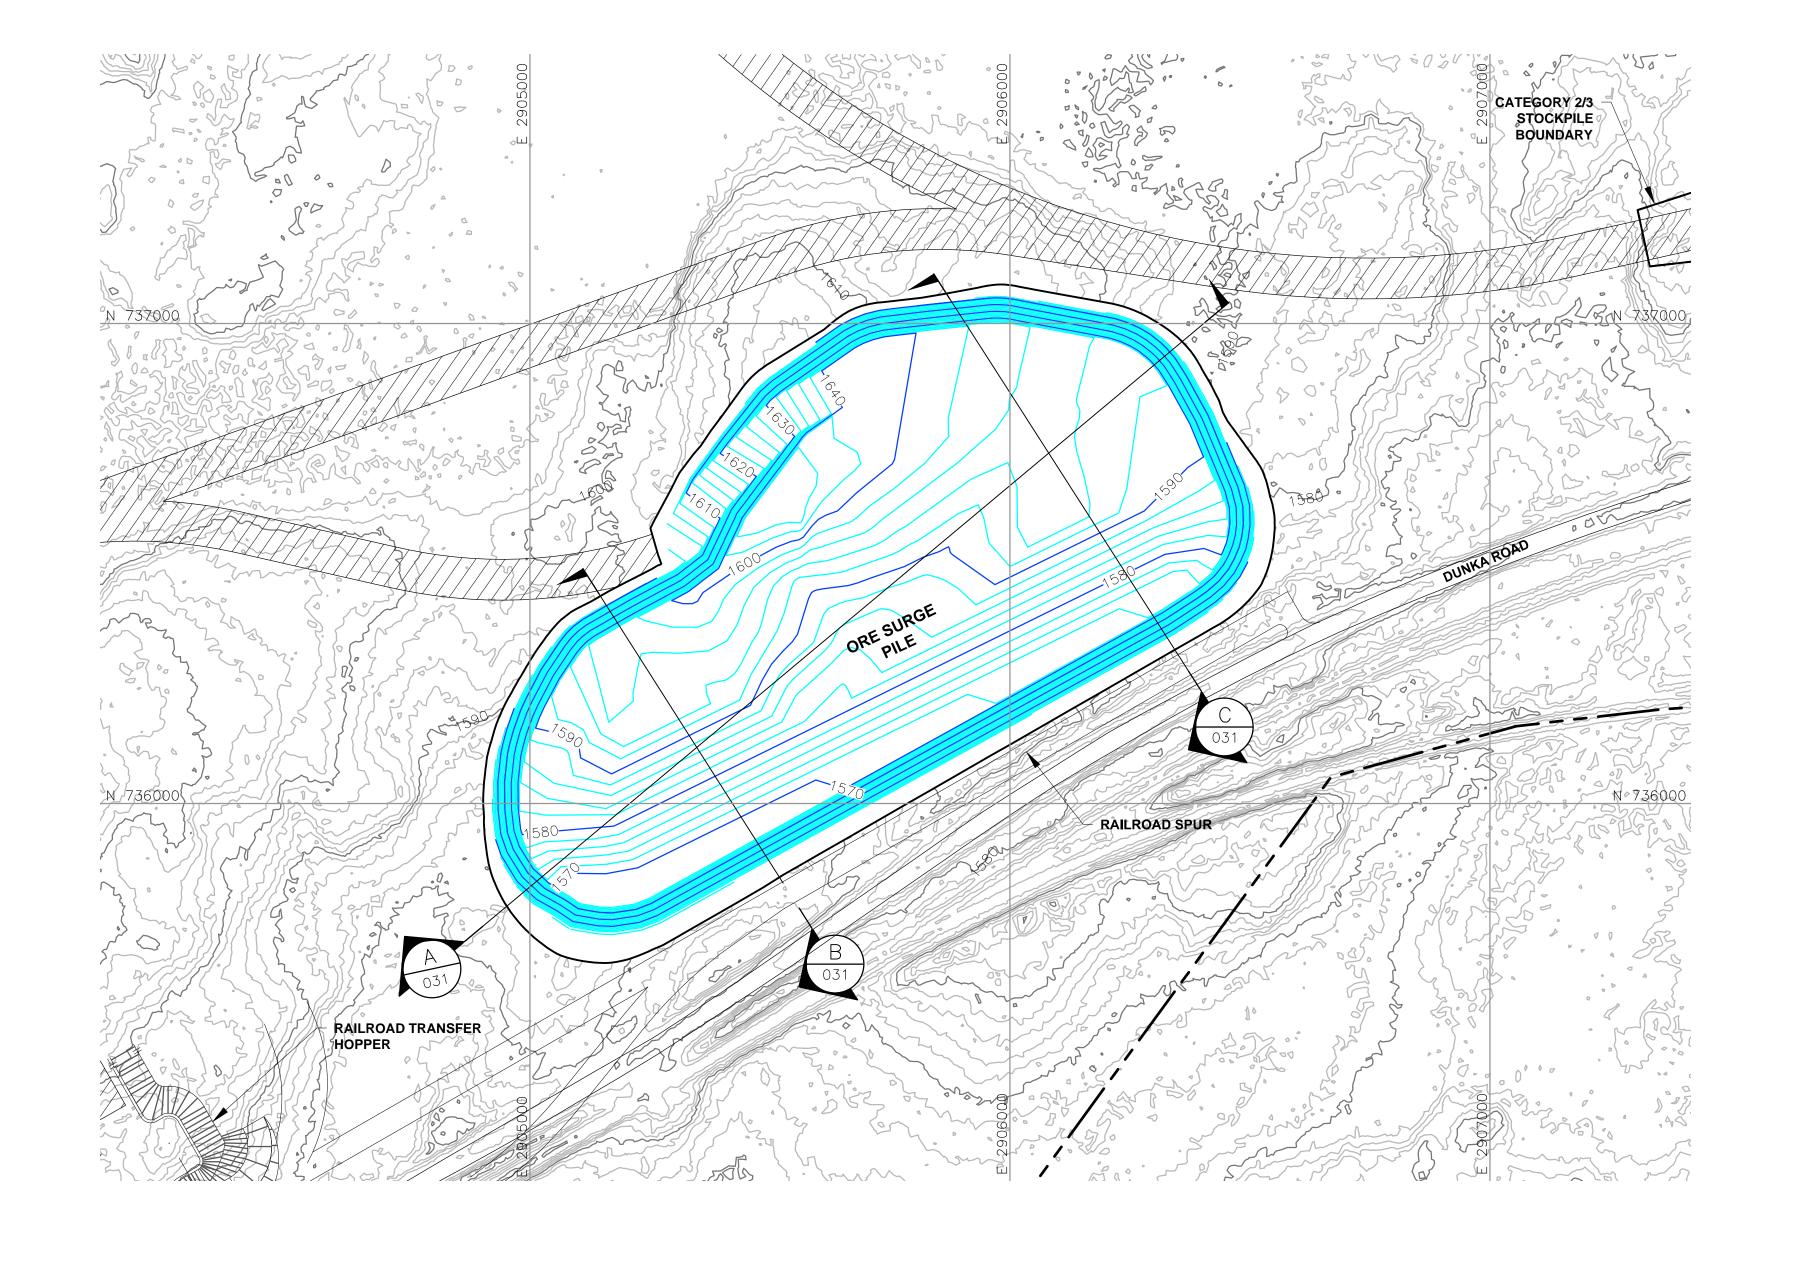



EXISTING GROUND TOPOGRAPHY



PROPOSED STOCKPILE LAYOUTS

HAUL ROADS

---- MINE SITE BOUNDARY MINE YEAR 1 PIT BOUNDARY (SEE NOTE 1)

> MINE YEAR 1 ORE, WASTE ROCK STOCKPILE OUTLINES (SEE NOTE 2)

MAXIMUM ORE, WASTE ROCK STOCKPILE — — OUTLINES (SEE NOTE 2)



- CROSS SECTION IDENTIFIER

- SHEET WHERE SECTION IS LOCATED

#### **NOTES**

- 1. OPEN PIT AND HAUL ROAD LAYOUTS PROVIDED BY BARR ENGINEERING IN OCTOBER 2011.
- 2. STOCKPILE LAYOUTS PROVIDED BY BARR ENGINEERING IN APRIL 2011 AND MODIFIED BY GOLDER.
- 3. SEE GENERAL NOTES AND LEGEND ON DRAWING 002.

# **REFERENCES**

- 1. EXISTING GROUND TOPOGRAPHY PROVIDED BY BARR ENGINEERING, AUGUST 2011.
- 2. COORDINATE SYSTEM REFERENCE IS NAD83 MINNESOTA STATE PLANE
- 3. VERTICAL DATUM REFERENCE IS FEET ABOVE MEAN SEA LEVEL (AMSL).

PLANT DRAWING NUMBER:

ORE SURGE PILE TYPICAL CONFIGURATION



A POLYMET

POLY MET MINING, INC. NORTHMET PROJECT HOYT LAKES, MINNESOTA

GOLDER ASSOCIATES INC. 44 UNION BOULEVARD, SUITE 300 LAKEWOOD, CO USA 80233

Ph: (303) 980-0540 Fax: (303) 985-2080 www.golder.com Associates

SCALE IN FEET


VER DATE ISSUE STATUS DESCRIPTION A 12/02/11 ISSUED FOR REVIEW FOR INCLUSION IN ROCK AND OVERBURDEN MANAGEMENT PLAN (ROMP) ISSUED I HEREBY CERTIFY THAT THIS PLAN,
SPECIFICATION, OR REPORT WAS
PREPARED BY ME OR UNDER MY DIRECT
SUPERVISION AND THAT I AM A DULY
LICENSED PROFESSIONAL ENGINEER
UNDER THE LAWS OF THE STATE OF
MINNESOTA. VERSION DATE B 2/15/13 ISSUED FOR REVIEW FOR INCLUSION IN ROMP DRAWN: C 5/29/13 ISSUED FOR REVIEW FOR INCLUSION IN ROMP PERMITTING D 1/14/14 ISSUED FOR AGENCY REVIEW E 4/10/15 ISSUED FOR INCLUSION IN PERMIT APPLICATIONS SIGNATURE Mensey F | 5/22/15 | ISSUED FOR INCLUSION IN PERMIT APPLICATIONS CONSTRUCTION PRINTED NAME BRENT R. BRONSON


NOT APPROVED FOR CONSTRUCTION.


CHECKED: GOLDER PROJECT NO.: 113-2209 DATE <u>5/22/15</u> LICENSE # 46492 SCALE: AS SHOWN


MTM


DWG. NO. SKP-030

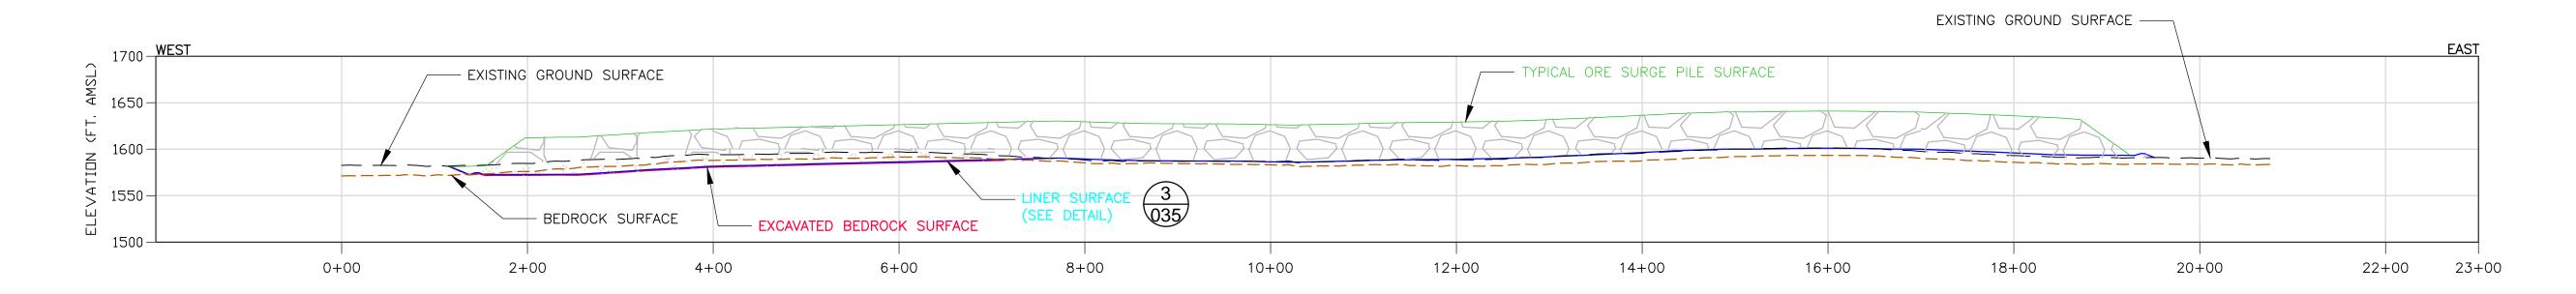


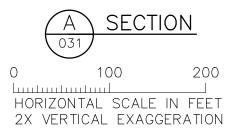

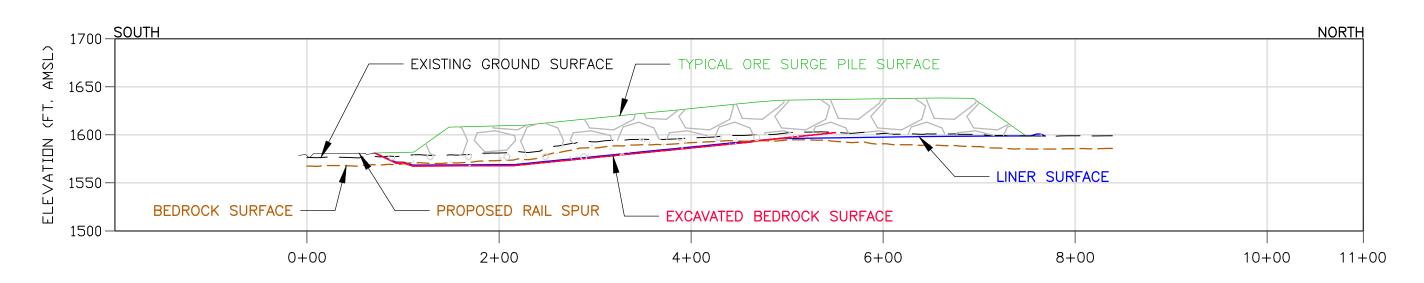

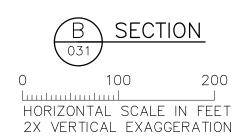

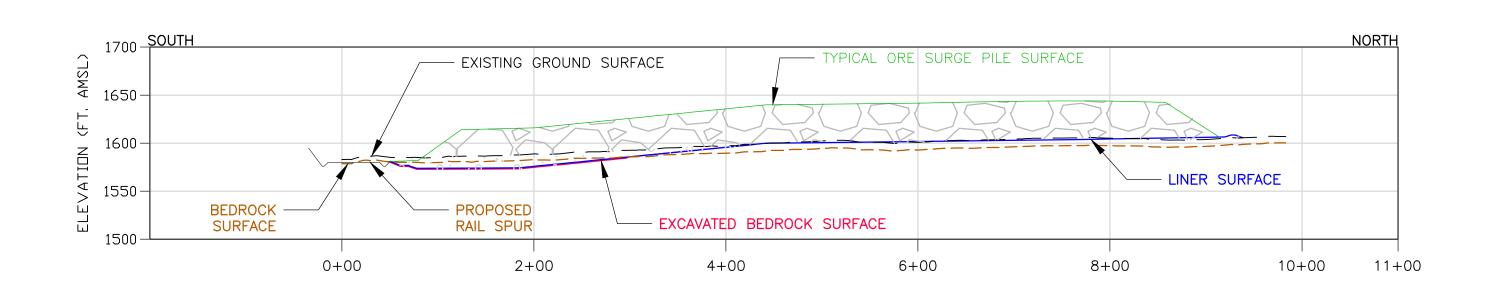

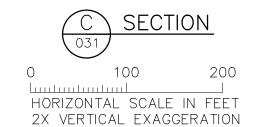

VER NO	DATE	DESCRIPTION	ISSUE STATUS																													
		ISSUED FOR REVIEW FOR INCLUSION IN ROCK AND OVERBURDEN MANAGEMENT PLAN (ROMP)	ISSUED	VERSION	DATE	THEREBY CERTIFY THAT THIS PLAN,																										
В	2/15/13	ISSUED FOR REVIEW FOR INCLUSION IN ROMP				SPECIFICATION, OR REPORT WAS PREPARED BY ME OR UNDER MY DIRECT	DRAWN:																									
С	5/29/13	ISSUED FOR REVIEW FOR INCLUSION IN ROMP	T FOR _ PERMITTING							l l	I I	1		I I	l l	I I				l	1	1	1	1	1	1	I		I F I	5-22-15	2-15 SUPERVISION AND THAT I AM A DULY LICENSED PROFESSIONAL ENGINEER	MTM
D	1/14/14	ISSUED FOR AGENCY REVIEW				UNDER THE LAWS OF THE STATE OF MINNESOTA.	CHECKED:																									
Ε	4/10/15	ISSUED FOR INCLUSION IN PERMIT APPLICATIONS				15	77																									
F	5/22/15	ISSUED FOR INCLUSION IN PERMIT APPLICATIONS	FOR CONSTRUCTION	I	l l				SIGNATURE	GOLDER PROJECT NO.:																						
								PRINTED NAME BRENT R. BRONSON	113–2209																							
			NOT APPROVED FOR CONSTRUCTION.		DATE <u>5/22/15</u> LICENSE # 46492	SCALE:																										
			1				AS SHOWN																									

# **LEGEND** — ORE LIMITS AT TYPICAL CAPACITY LINER SURFACE — — — EXISTING GROUND SURFACE OVERBURDEN SOIL AND BEDROCK EXCAVATION SURFACE ---- BEDROCK SURFACE

#### **NOTES**

DWG. NO.

SKP-031

PLANT DRAWING NUMBER:

- 1. STOCKPILE SIDE SLOPES AT ANGLE OF REPOSE.
- 2. SEE GENERAL NOTES AND LEGEND ON DRAWING 002.
- 3. SEE CROSS SECTION LOCATIONS ON DRAWINGS 3, 4, 5, 26, AND 27


DESIGN SECTIONS 養 POLY MET MINING, INC. NORTHMET PROJECT POLYMET HOYT LAKES, MINNESOTA

ORE SURGE PILE

GOLDER ASSOCIATES INC. 44 UNION BOULEVARD, SUITE 300 LAKEWOOD, CO USA 80233


REV

Golder Ph: (303) 980-0540 Fax: (303) 985-2080 www.golder.com Associates

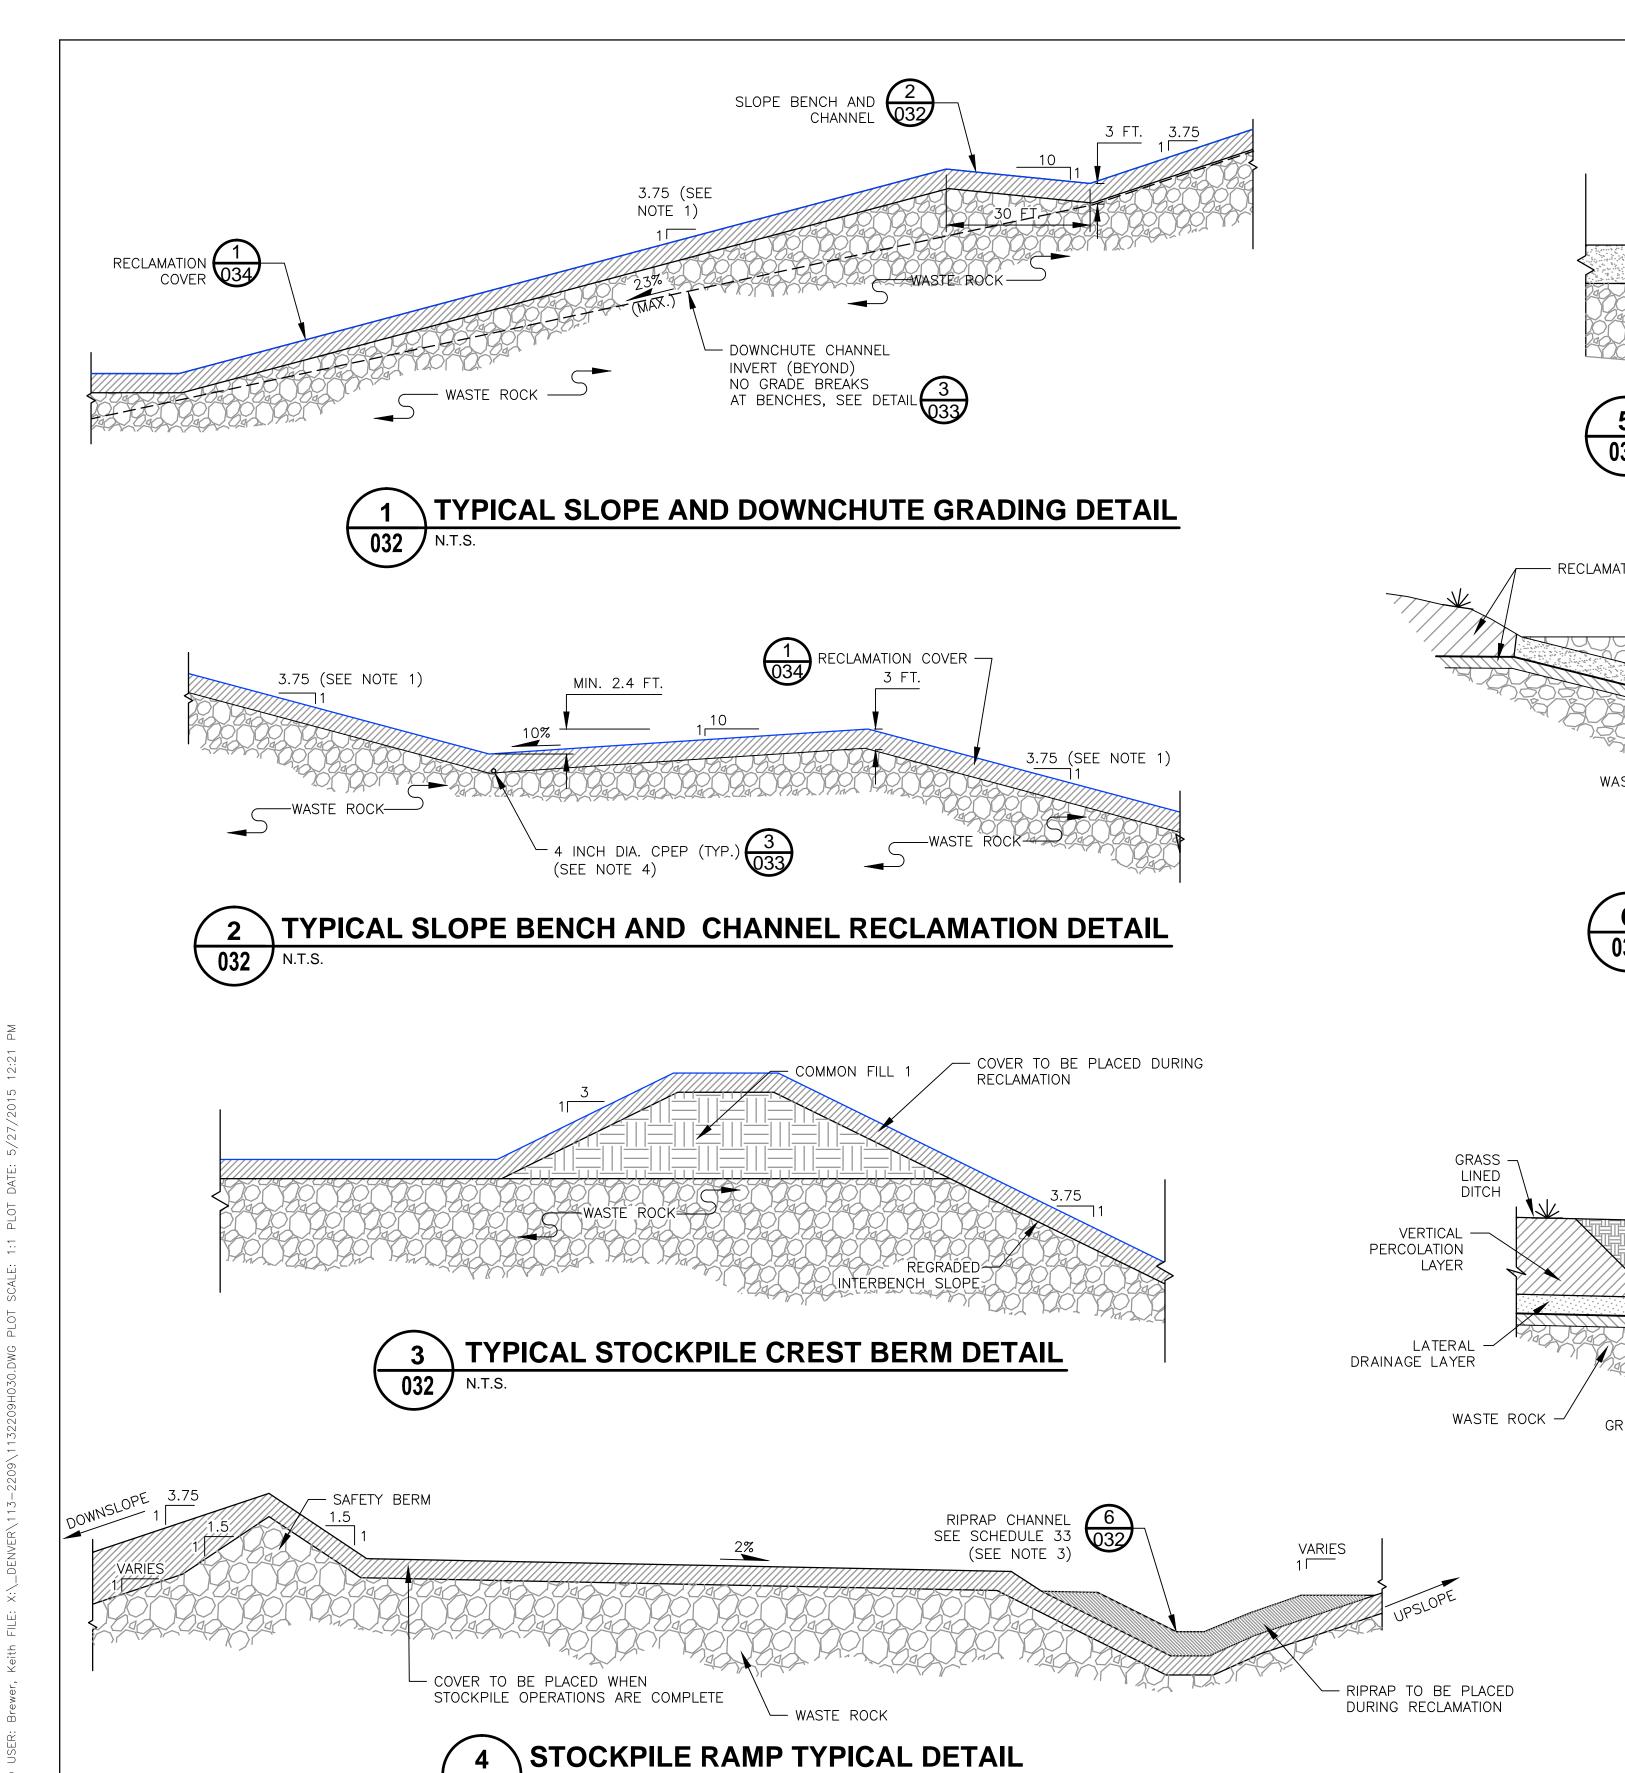


SAFETY BERM -

TYPICAL TOP SURFACE CHANNEL SECTION

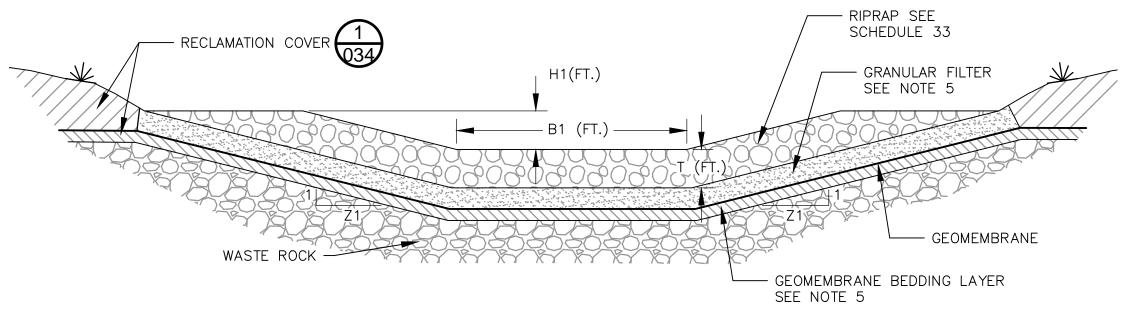

**TYPICAL RIPRAP-LINED CHANNEL AND DOWNCHUTE** N.T.S. (SEE SCHEDULE 33 FOR DIMENSIONS - SKP-033)

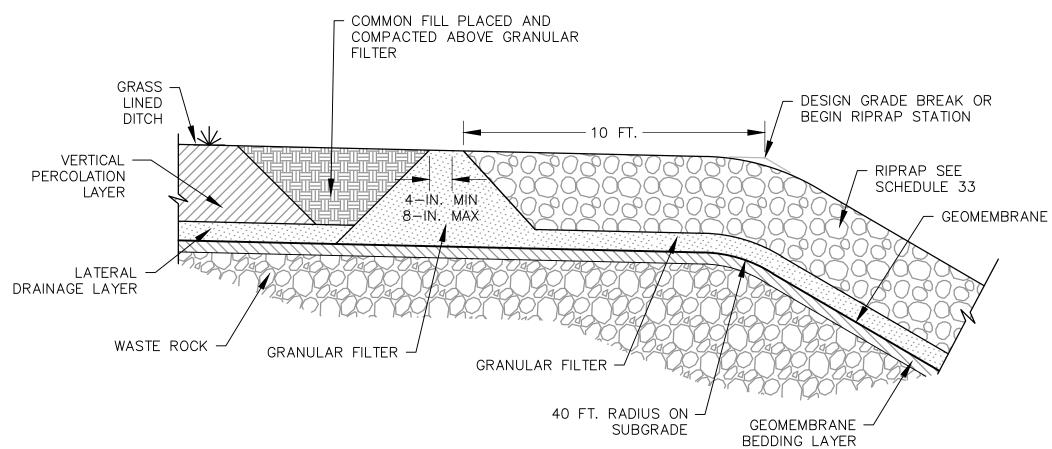

**UPSTREAM END OF RIPRAP CHANNEL** 032 N.T.S.

#### **NOTES**

- 1. THE MAXIMUM SLOPE GRADES ARE 3.75H:1V FOR RECLAIMED STOCKPILE
- 2. ASSUME 1.4H:1V INTERBENCH SLOPES FOR ACTIVE AREAS (EQUAL TO NOMINAL ANGLE OF REPOSE FOR WASTE ROCK MATERIAL). REGRADE PRIOR TO PLACEMENT OF RECLAMATION COVER.
- 3. SEE SCHEDULE 33 ON DRAWING SKP-033.
- 4. AT BASE OF COVER SYSTEM GRANULAR DRAINAGE LAYER PLACE DRAIN PIPE AT SLOPE-BENCH INTERSECTION. PIPE TO BE CONTINUOUS ALONG BENCHES BETWEEN DOWNCHUTE CHANNELS.
- 5. RIPRAP-LINED CHANNEL AND DOWNCHUTE DETAILS REPRESENT PRELIMINARY DESIGNS. DETAILED DIMENSIONS AND TECHNICAL SPECIFICATIONS TO BE PROVIDED PRIOR TO CONSTRUCTION, I.E. AS A PART OF FINAL DESIGN.
- 6. SEE GENERAL NOTES AND LEGEND ON DRAWING 002.

PLANT DRAWING NUMBER:

CATEGORY 1 STOCKPILE RECLAMATION AND OPERATIONS SURFACE WATER

MANAGEMENT DETAILS - SHEET 1 OF 2 発 DESCRIPTION ISSUE STATUS POLY MET MINING, INC. ISSUED VERSION DATE NORTHMET PROJECT

A 12/02/11 ISSUED FOR REVIEW FOR INCLUSION IN ROCK AND OVERBURDEN MANAGEMENT PLAN (ROMP) I HEREBY CERTIFY THAT THIS PLAN,
SPECIFICATION, OR REPORT WAS
PREPARED BY ME OR UNDER MY DIRECT
SUPERVISION AND THAT I AM A DULY
LICENSED PROFESSIONAL ENGINEER B 2/15/13 ISSUED FOR REVIEW FOR INCLUSION IN ROMP DRAWN: : 5/29/13 ISSUED FOR REVIEW FOR INCLUSION IN ROMP PERMITTING UNDER THE LAWS OF THE STATE OF 1/14/14 ISSUED FOR AGENCY REVIEW CHECKED: MINNESOTA. 4/10/15 ISSUED FOR INCLUSION IN PERMIT APPLICATIONS Honson SIGNATURE \_\_\_ 5/22/15 ISSUED FOR INCLUSION IN PERMIT APPLICATIONS CONSTRUCTION PRINTED NAME BRENT R. BRONSON DATE <u>5/22/15</u> LICENSE # 46492 NOT APPROVED FOR CONSTRUCTION. SCALE:

POLYMET Golder GOLDER PROJECT NO.: 113-2209

MTM


AS SHOWN

HOYT LAKES, MINNESOTA GOLDER ASSOCIATES INC. 44 UNION BOULEVARD, SUITE 300 LAKEWOOD, CO USA 80233 Ph: (303) 980-0540 Fax: (303) 985-2080 www.golder.com


REV

SKP-032




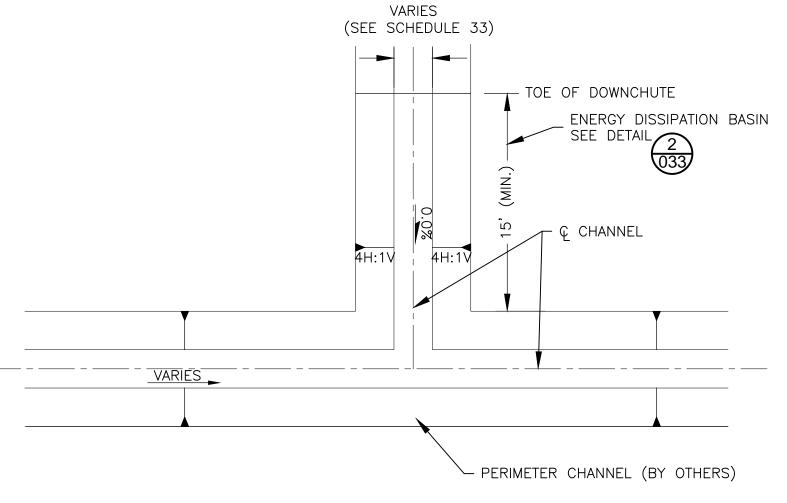

DOWNCHUTE CHANNEL CONFLUENCE DETAIL **033** N.T.S.

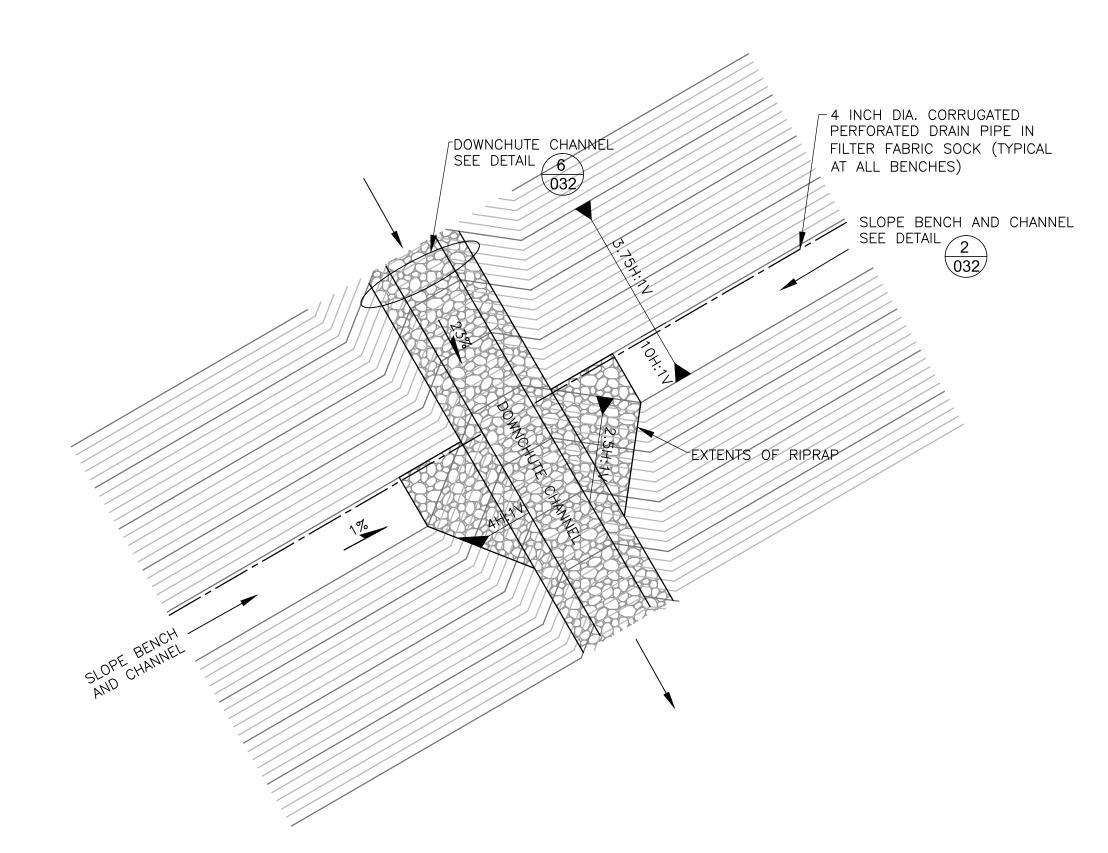

3 SLOPE BENCH AND CHANNEL TO DOWNCHUTE TRANSITION

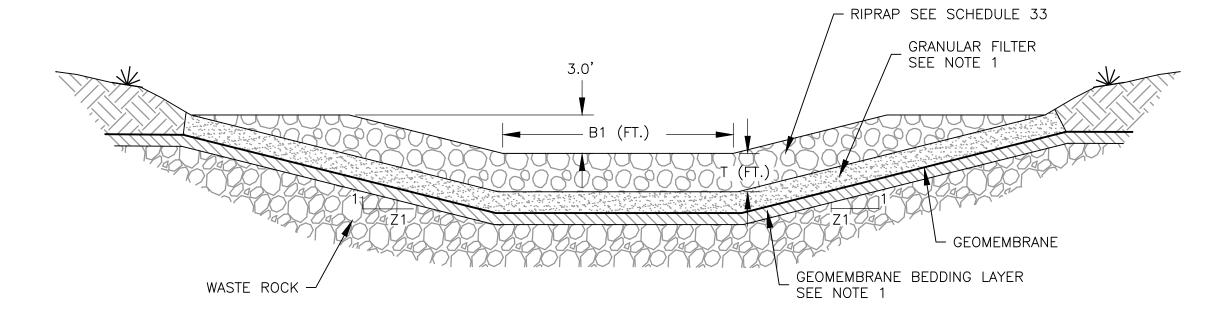

TYPICAL ENERGY DISSIPATION BASIN (SEE SCHEDULE 33 FOR DIMENSIONS) **033** N.T.S.

### SCHEDULE 33: RIPRAP-LINED CHANNEL DIMENSIONS

CHANNEL ID	BOTTOM WIDTH, 81 (FT)	SIDE SLOPE, Z1 (H:1V)	MIN. DEPTH, H1 (FT)	RIPRAP SIZE, D <sub>60</sub> (IN)	RIPRAP LAYER THICKNESS, T (FT)	MAX SLOPE, (FT/FT)
DC1-A	20	4	3	12	2	0.23
DC1-8	20	4	3	12	2	0.23
DC1-C	25	4	3	12	2	0.23
DC1-D	20	4	3	12	2	0.23
DC1-£	25	4	3	12	2	0.23
DC1-F	20	4	3	9	1.5	0.23
DC1-G	20	4	3	12	2	0.23
DC1-HRE	8	4	3	9	1.5	0.06
DC1-H	20	4	3	9	1.5	0.23
DC1-HRS	8	4	3	9	1.5	0.06
DC1-HRU	8	4	3	9	1.6	0.07
DC1-I	20	4	3	12	2	0.23
DC1-J	20	4	3	18	3	0.23
DC1-K	25	4	3	12	2	0.23
DC1-L	25	4	3	12	2	0.23

#### **NOTES**

- ENERGY DISSIPATION BASIN DETAIL REPRESENTS PRELIMINARY DESIGN. DETAILED DIMENSIONS AND TECHNICAL SPECIFICATIONS TO BE PROVIDED PRIOR TO CONSTRUCTION, I.E. AS A PART OF FINAL DESIGN.
- 2. SEE GENERAL NOTES AND LEGEND ON DRAWING 002.

CATEGORY 1 STOCKPILE RECLAMATION AND OPERATIONS SURFACE WATER MANAGEMENT DETAILS - SHEET 2 OF 2

PLANT DRAWING NUMBER:

¥

POLYMET

DWG. NO.

AS SHOWN

R O	DATE	DESCRIPTION	ISSUE STATUS							
\	12/02/11	ISSUED FOR REVIEW FOR INCLUSION IN ROCK AND OVERBURDEN MANAGEMENT PLAN (ROMP)	ISSUED	VERSION	DATE	I HEREBY CERTIFY THAT THIS PLAN,				
~	2/15/13	ISSUED FOR REVIEW FOR INCLUSION IN ROMP				SPECIFICATION, OR REPORT WAS PREPARED BY ME OR UNDER MY DIRECT	DRAWN:			
	5/29/13	ISSUED FOR REVIEW FOR INCLUSION IN ROMP	FOR PERMITTING		F	5_22_15	SUPERVISION AND THAT I AM A DULY LICENSED PROFESSIONAL ENGINEER	MTM		
	1/14/14	ISSUED FOR AGENCY REVIEW				UNDER THE LAWS OF THE STATE OF MINNESOTA.	CHECKED:			
	4/10/15	ISSUED FOR INCLUSION IN PERMIT APPLICATIONS	FOR			FOR CONSTRUCTION			I Samuel	77
	5/22/15	ISSUED FOR INCLUSION IN PERMIT APPLICATIONS							SIGNATURE	GOLDER PROJECT NO.:
						PRINTED NAME BRENT R. BRONSON	113–2209			
			NOT APPROVED FOR CONSTRUCTION.			DATE <u>5/22/15</u> LICENSE # 46492	SCALE:			

SKP-033

POLY MET MINING, INC.

NORTHMET PROJECT

HOYT LAKES, MINNESOTA

Ph: (303) 980-0540 Fax: (303) 985-2080 www.golder.com

GOLDER ASSOCIATES INC. 44 UNION BOULEVARD, SUITE 300 LAKEWOOD, CO USA 80233

REV


D 1/14/14 ISSUED FOR AGENCY REVIEW

E 4/10/15 ISSUED FOR INCLUSION IN PERMIT APPLICATIONS

F | 5/22/15 | ISSUED FOR INCLUSION IN PERMIT APPLICATIONS

RECLAIMED OUTSLOPE CHANNEL GEOMETRY (SEE NOTE 1) RECLAMATION COVER GEOMEMBRANE -BARRIER APPROX. 10

**RECLAMATION TO OPERATIONAL AREA TIE IN DETAIL** 

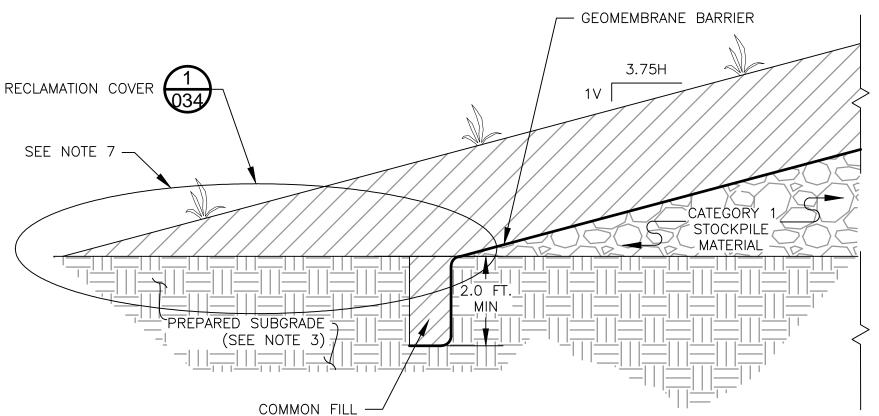

5 GEOMEMBRANE COVER ANCHOR TRENCH DETAIL **034** N.T.S.

- 1. TEMPORARY SLOPE BENCH CHANNEL SHOULD BE CONSTRUCTED WITH MINIMUM DEPTH OF 2.4 FT. ON THE BENCHES BY GRADING CHANNEL SIDE SLOPES TO 10H:1V ON 30 FT. WIDE BENCHES.
- 2. STOCKPILE GEOMETRY DURING OPERATIONS BASED ON ASSUMED WASTE ROCK ANGLE OF REPOSE OF 35.5
- 3. GEOTECHNICALLY UNSUITABLE SOILS TO BE REMOVED AND REPLACED WITH COMPACTED STRUCTURAL FILL WITHIN 100 FT. OF CATEGORY 1 STOCKPILE PERIMETER LIMITS.
- 4. ON TOP OF STOCKPILE ON 1% SLOPE AREAS, PLACE 4 INCH DIAMETER PERFORATED CORRUGATED POLYETHYLENE PIPE (CPEP) WITH FILTER FABRIC SOCK AT 75 FOOT SPACING TO FACILITATE DRAINAGE OF GRANULAR DRAINAGE LAYER TO TOP SURFACE CHANNEL. PIPE LOCATION TO BE FIELD FIT.
- 5. AT STOCKPILE BENCHES, PLACE 4 INCH PERFORATED CPEP DRAIN PIPE WITH FILTER FABRIC SOCK AT BASE OF COVER SYSTEM GRANULAR DRAINAGE LAYER AT SLOPE-BENCH INTERSECTION WITH OUTFLOW DIRECTED TO DOWNCHUTE CHANNELS.

PLANT DRAWING NUMBER:

6. SEE GENERAL NOTES AND LEGEND ON DRAWING 002.

CHECKED:

SCALE:

GOLDER PROJECT NO.:

113-2209

AS SHOWN

UNDER THE LAWS OF THE STATE OF MINNESOTA.

SIGNATURE 🚄

Densen

PRINTED NAME BRENT R. BRONSON

DATE <u>5/22/15</u> LICENSE # 46492

PERMITTING

CONSTRUCTION

NOT APPROVED FOR CONSTRUCTION.

7. 7EDGE OF LINER TO TIE IN TO CATEGORY 1 STOCKPILE GROUNDWATER CONTAINMENT SYSTEM.

DWG. NO.

8. REFER TO UNIFIED SOIL CLASSIFICATION SYSTEM FOR COVER SOIL DESCRIPTION.

CATEGORY 1 STOCKPILE PHASED COVER DESIGN ¥ POLY MET MINING, INC. NORTHMET PROJECT POLYMET HOYT LAKES, MINNESOTA

GOLDER ASSOCIATES INC. 44 UNION BOULEVARD, SUITE 300 LAKEWOOD, CO USA 80233 Golder Ph: (303) 980-0540 Fax: (303) 985-2080

**Associates** www.golder.com REV SKP-034

**TYPICAL FOUNDATION UNDERDRAIN** 

2.0 FT. MIN

STRUCTURAL

NATIVE MATERIAL

FILL OR

GEOMEMBRANE LINER ANCHOR TRENCH DETAIL

- 80-MIL LLDPE GEOMEMBRANE

1 FT. MIN. COMPACTED -SOIL LINER

GRANULAR DRAINAGE


MATERIAL 1

035 N.T.S.


035 N.T.S.

ROAD BERM — SEE DETAIL


COMMON FILL

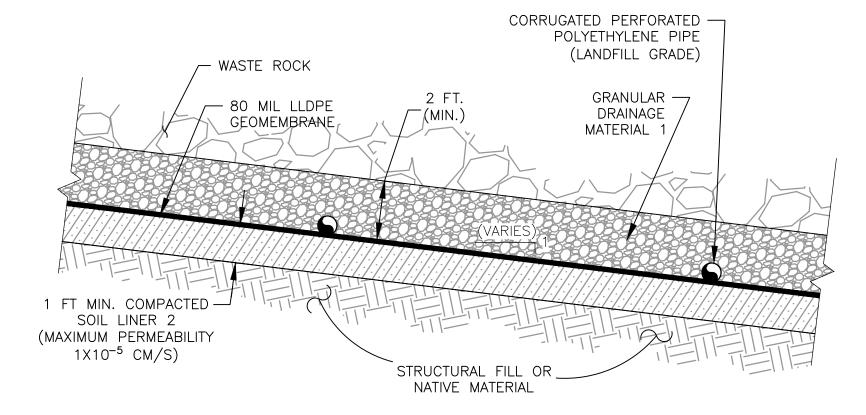

**CATEGORY 2/3 STOCKPILE LINER** 

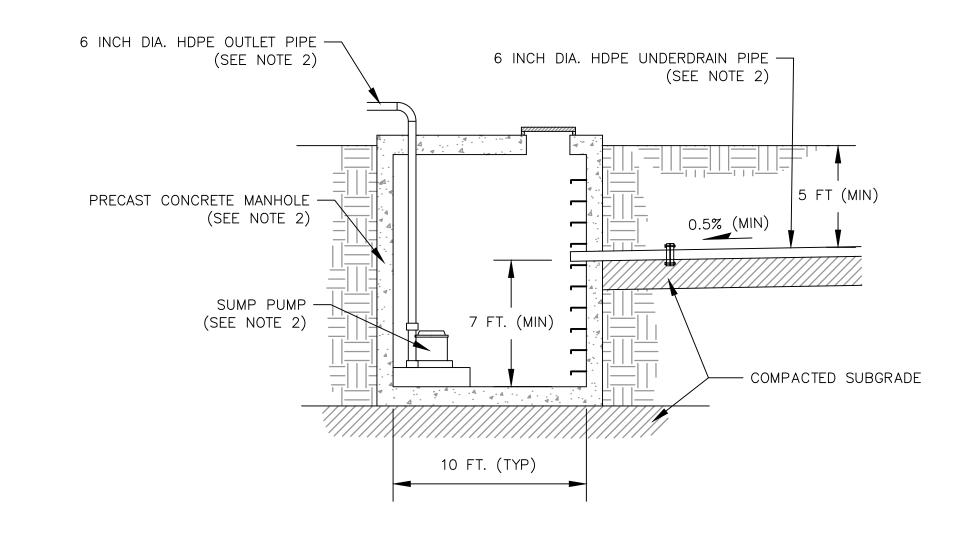

5 UNDERDRAIN SUMP MANHOLE

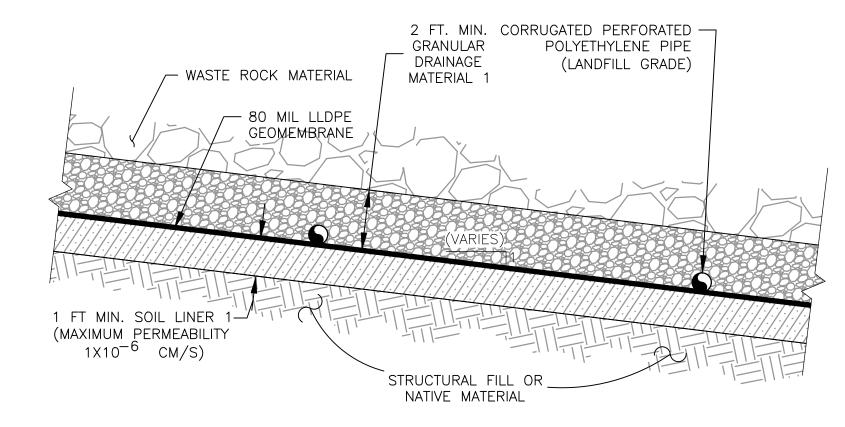



## **NOTES**

1. SEE GENERAL NOTES AND LEGEND ON DRAWING 002.

2. UNDERDRAIN SUMP MANHOLE DIMENSIONS, SUMP PUMP CAPACITY AND PIPE DIMENSIONS ARE PRELIMINARY AND WILL BE SIZED BASED ON ENCOUNTERED FIELD CONDITIONS.

PLANT DRAWING NUMBER:

						CON	NSTRUCTION DETAILS
DESCRIPTION DESCRIPTION		ISSUE STATUS				×	POLY MET MINING, INC.
12/02/11 ISSUED FOR REVIEW FOR INCLUSION IN ROCK AND OVERBURDEN MANAGEMENT PLAN (ROMP)	ISSUED	VERSION	DATE	I HEREBY CERTIFY THAT THIS PLAN,			, in the second
2/15/13 ISSUED FOR REVIEW FOR INCLUSION IN ROMP				SPECIFICATION, OR REPORT WAS PREPARED BY ME OR UNDER MY DIRECT SUPERVISION AND THAT I AM A DULY LICENSED PROFESSIONAL ENGINEER	DRAWN:	POLYMET	NORTHMET PROJECT
5/29/13 ISSUED FOR REVIEW FOR INCLUSION IN ROMP	FOR PERMITTING	F	5-22-15		MTM	MINING	HOYT LAKES, MINNESOTA
1/14/14 ISSUED FOR AGENCY REVIEW				UNDER THE LAWS OF THE STATE OF MINNESOTA.	CHECKED:		GOLDER ASSOCIATES INC.
4/10/15 ISSUED FOR INCLUSION IN PERMIT APPLICATIONS				18	77		44 UNION BOULEVARD, SUITE 300 LAKEWOOD, CO USA 80233
5/22/15 ISSUED FOR INCLUSION IN PERMIT APPLICATIONS	T FOR CONSTRUCTION			PRINTED NAME BRENT R. BRONSON	GOLDER PROJECT NO:: 113-2209	Golder Golder	Ph: (303) 980-0540
						Associ	Fax: (303) 985-2080 www.golder.com
NOT APPROVED FOR		R CONSTRUCTION.		DATE <u>5/22/15</u> LICENSE # 46492	SCALE: AS SHOWN	DWG. NO. SKP-03	55 REV

#### **Errata Sheet**

#### Poly Met Mining, Inc. NorthMet Project


# Permit Application Support Drawings: Category 1 Stockpile Groundwater Containment System

#### July 2016 (version 2)

Engineering design is currently in progress. The table below lists changes that have been identified to-date and have not yet been incorporated in the attached permit application support drawings within this set. Final design will incorporate these changes along with additional site-specific information (e.g., supplementary geotechnical data); therefore, additional adjustments may be made during final design that will be incorporated into the final design drawing set.

Drawing Sheet(s)	Change			
Global change to all sheets, as needed	The terminology "mine drainage" as noted in these drawings will be changed to "mine water".			
GCS-003	To meet construction stormwater requirements, a temporary berm will be added on the west side of the Mine Year 0 Category 1 Stockpile footprint to control mine water runoff as the stockpile is built out.			

# POLY MET MINING, INC. NORTHMET PROJECT PERMIT APPLICATION SUPPORT DRAWINGS CATEGORY 1 STOCKPILE GROUNDWATER CONTAINMENT SYSTEM HOYT LAKES, MINNESOTA

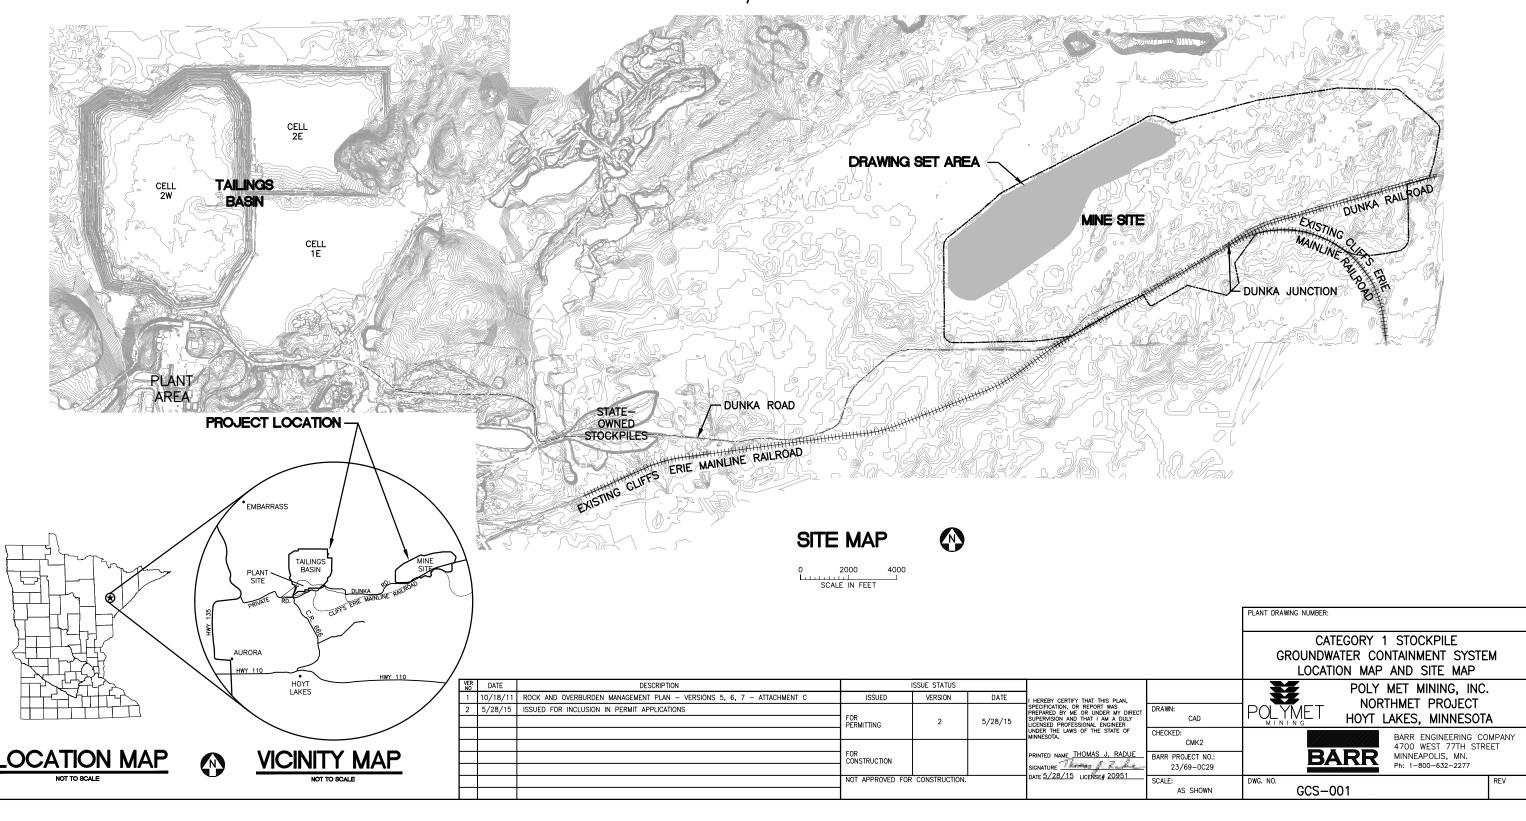

#### **GENERAL LEGEND**

-----1000----- EXISTING CONTOUR - MAJOR EXISTING CONTOUR - MINOR ---- MINE SITE BOUNDARY ----- OF ------ PROPOSED SUMP OVERFLOW PIPE PROPOSED MINE DRAINAGE PIPE (PUMPED FLOW) PROPOSED MINE DRAINAGE PIPE (GRAVITY FLOW) PROPOSED SUMP MANHOLE PROPOSED ACCESS ROADS HAUL ROAD

#### **NOTES**

- 1. COORDINATE SYSTEM IS MINNESOTA STATE PLANE NORTH ZONE, NAD83.
- 2. ELEVATIONS ARE MEAN SEA LEVEL (MSL), NAVD88.
- 3. EXISTING TOPOGRAPHIC INFORMATION SHOWN ON THE DRAWINGS WAS PREPARED BY AEROMETRIC, INC. FROM LIDAR DATA COLLECTED ON MARCH 17, 2010.

#### **ABBREVIATIONS**

CAT CATEGORY DWG DRAWING EL ELEVATION GROUNDWATER CONTAINMENT SYSTEM GCS МН MANHOLE NTS NOT TO SCALE PVI PROFILE VERTICAL INTERSECTION

WWTF - WASTE WATER TREATMENT FACILITY

STATION

STA

#### SHEET INDEX


#### SHEET NO. TITLE

#### GENERAL DRAWINGS

GENERAL DRAWINGS

GCS-001 LOCATION MAP AND SITE MAP
GCS-002 LEGEND AND SHEET INDEX
GCS-003 MINE YEAR 0 LAYOUT
GCS-004 MINE YEAR 2 LAYOUT
GCS-005 MINE YEAR 3 LAYOUT
GCS-006 MINE YEAR 3 LAYOUT
GCS-007 MINE YEAR 6 LAYOUT
GCS-008 MINE YEAR 6 LAYOUT
GCS-009 CLOSURE CONFIGURATION
GCS-011 TYPICAL CROSS SECTIONS
GCS-011 NORTH PROFILES
GCS-013 SOUTH PROFILES
GCS-014 DISCHARGE PROFILES

#### **DRAWING NUMBERING**

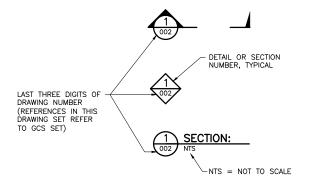

CATEGORY 1 STOCKPILE GROUNDWATER CONTAINMENT SYSTEM LEGEND AND SHEET INDEX POLY MET MINING, INC.

BARR

GCS-002

NORTHMET PROJECT

HOYT LAKES, MINNESOTA

MINNEAPOLIS, MN.


Ph: 1-800-632-2277


BARR ENGINEERING COMPANY 4700 WEST 77TH STREET


PLANT DRAWING NUMBER:


POLYMET


VER NO	DATE	DESCRIPTION	ISSUE STATUS				
		ROCK AND OVERBURDEN MANAGEMENT PLAN - VERSIONS 5, 6, 7 - ATTACHMENT C	ISSUED	VERSION	DATE	I HEREBY CERTIFY THAT THIS PLAN.	
2	5/28/15	ISSUED FOR INCLUSION IN PERMIT APPLICATIONS			5/28/15	SPECIFICATION, OR REPORT WAS PREPARED BY ME OR UNDER MY DIRECT SUPERVISION AND THAT I AM A DULY LICENSED PROFESSIONAL ENGINEER UNDER THE LAWS OF THE STATE OF MINNESOTA.	DRAWN:
			FOR PERMITTING 2				CAD
							CHECKED:
							CMK2
			FOR CONSTRUCTION			PRINTED NAME THOMAS J. RADUE	BARR PROJECT NO.:
						SIGNATURE 20051	23/69-0C29
			NOT APPROVED FOR CONSTRUCTION.		DATE 5/28/15 LICENSE# 20951	SCALE:	
			1			İ	AS SHOWN

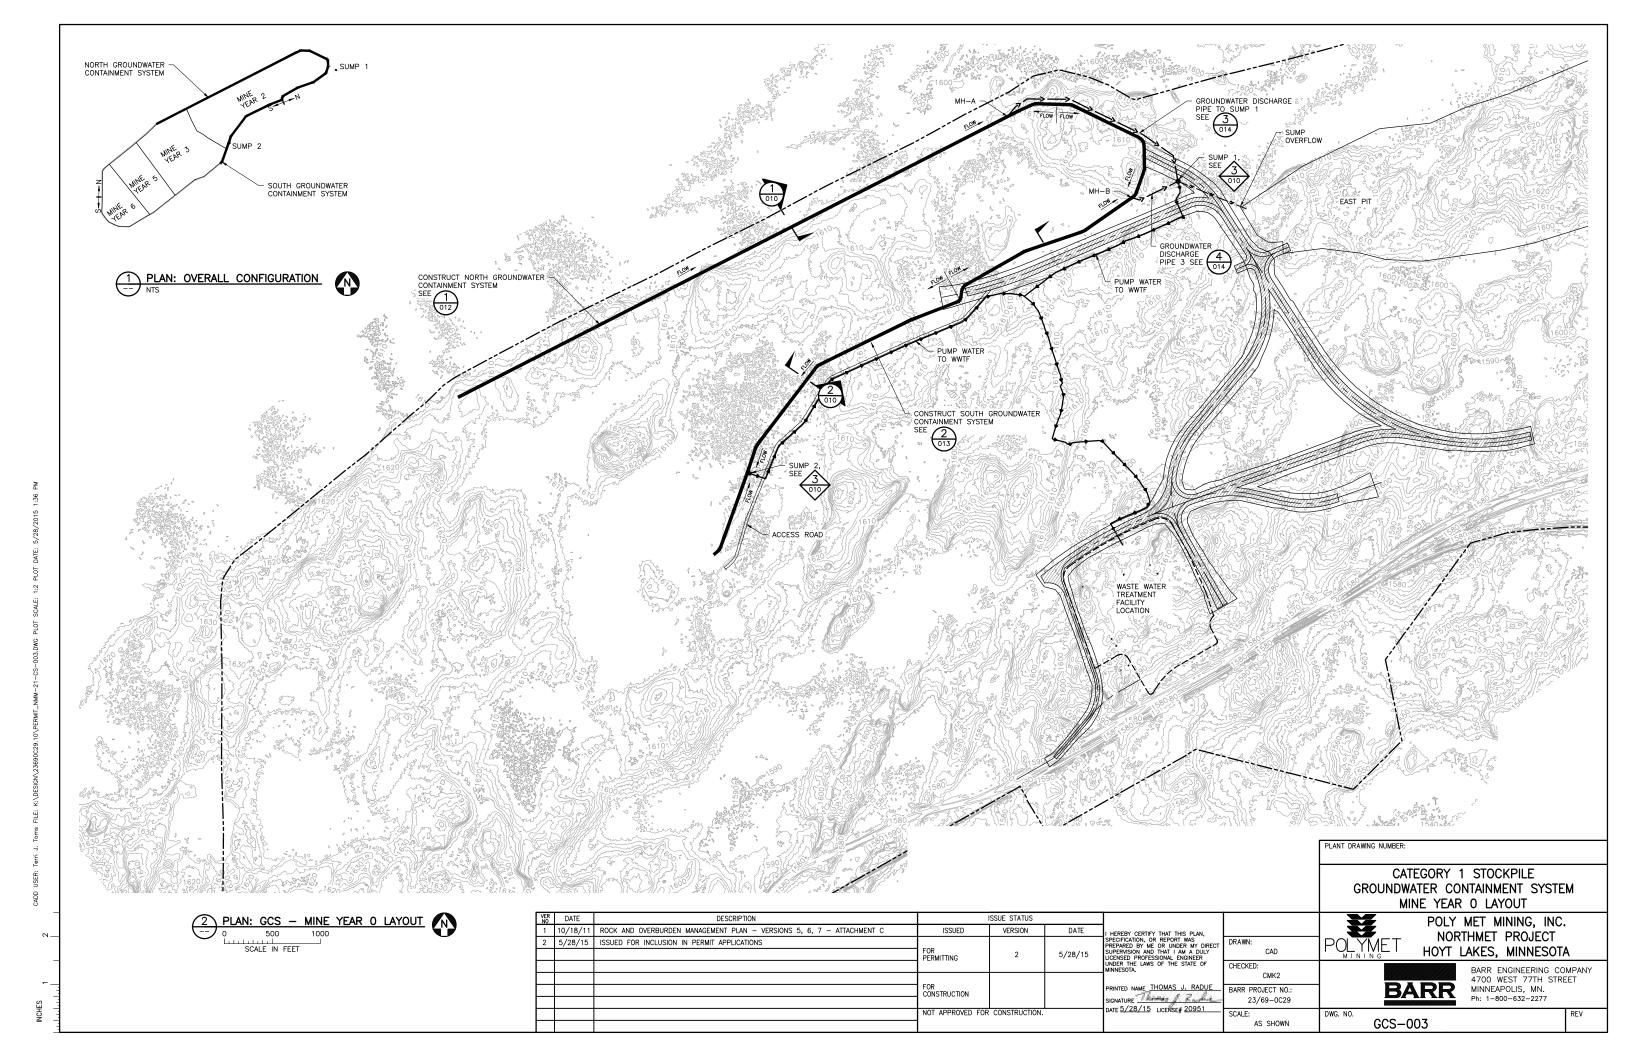


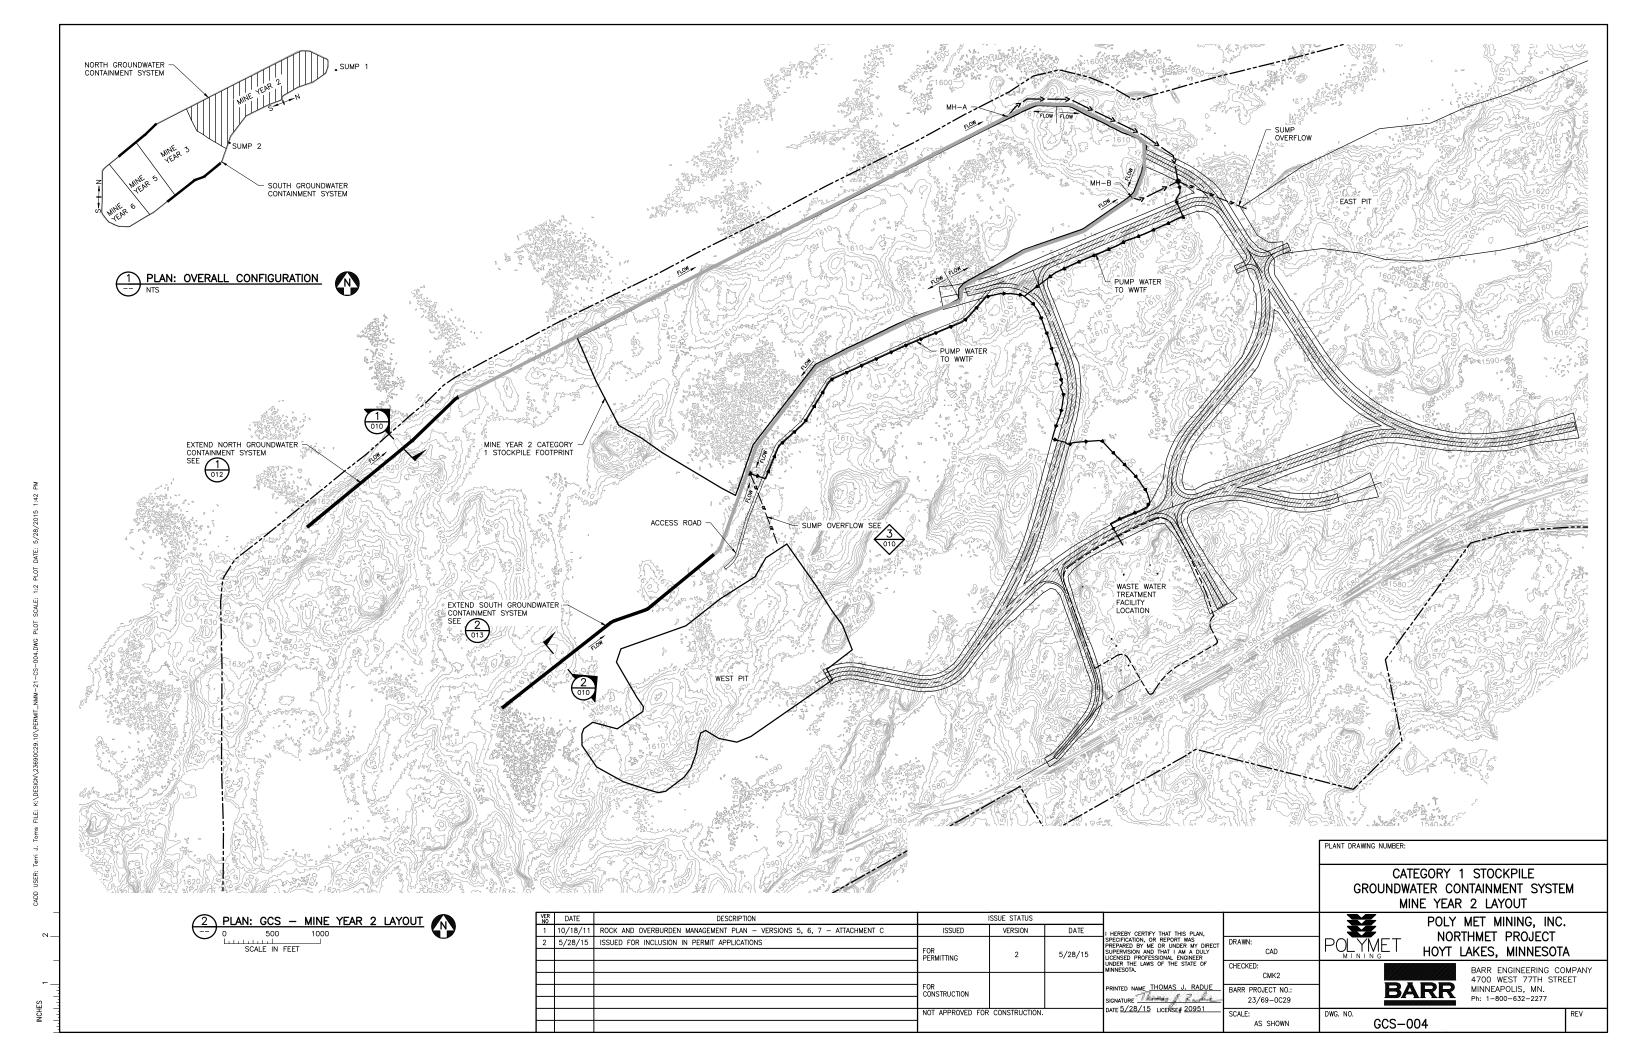


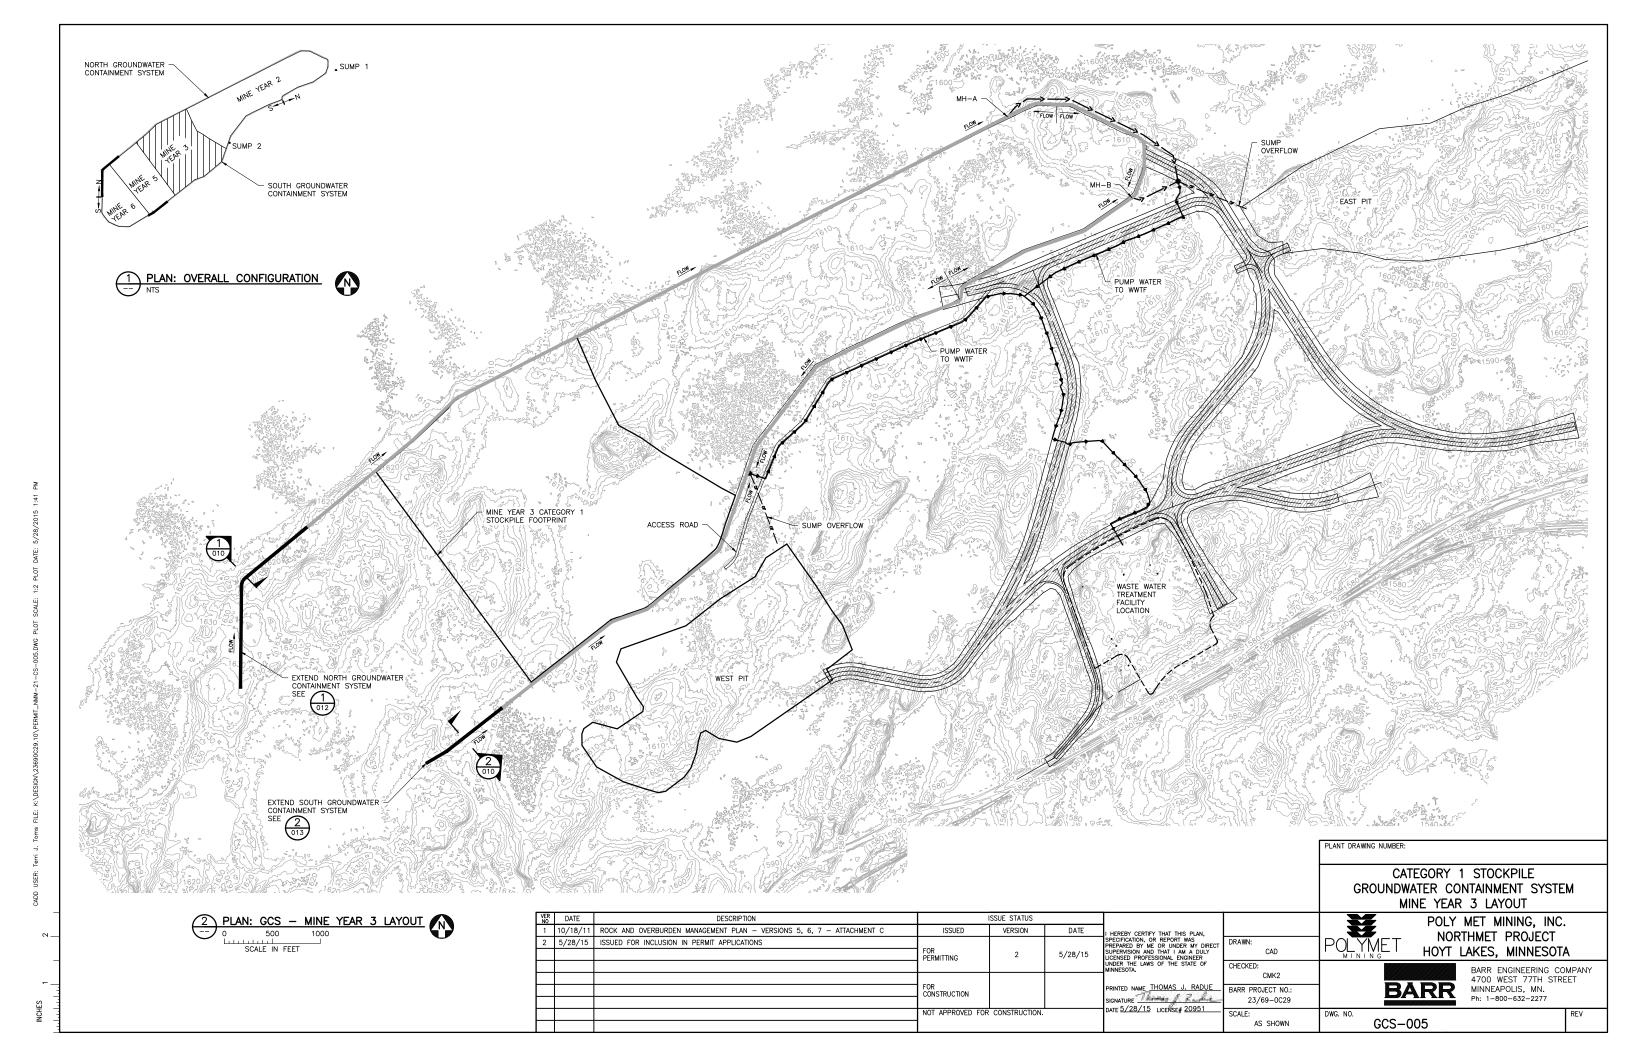


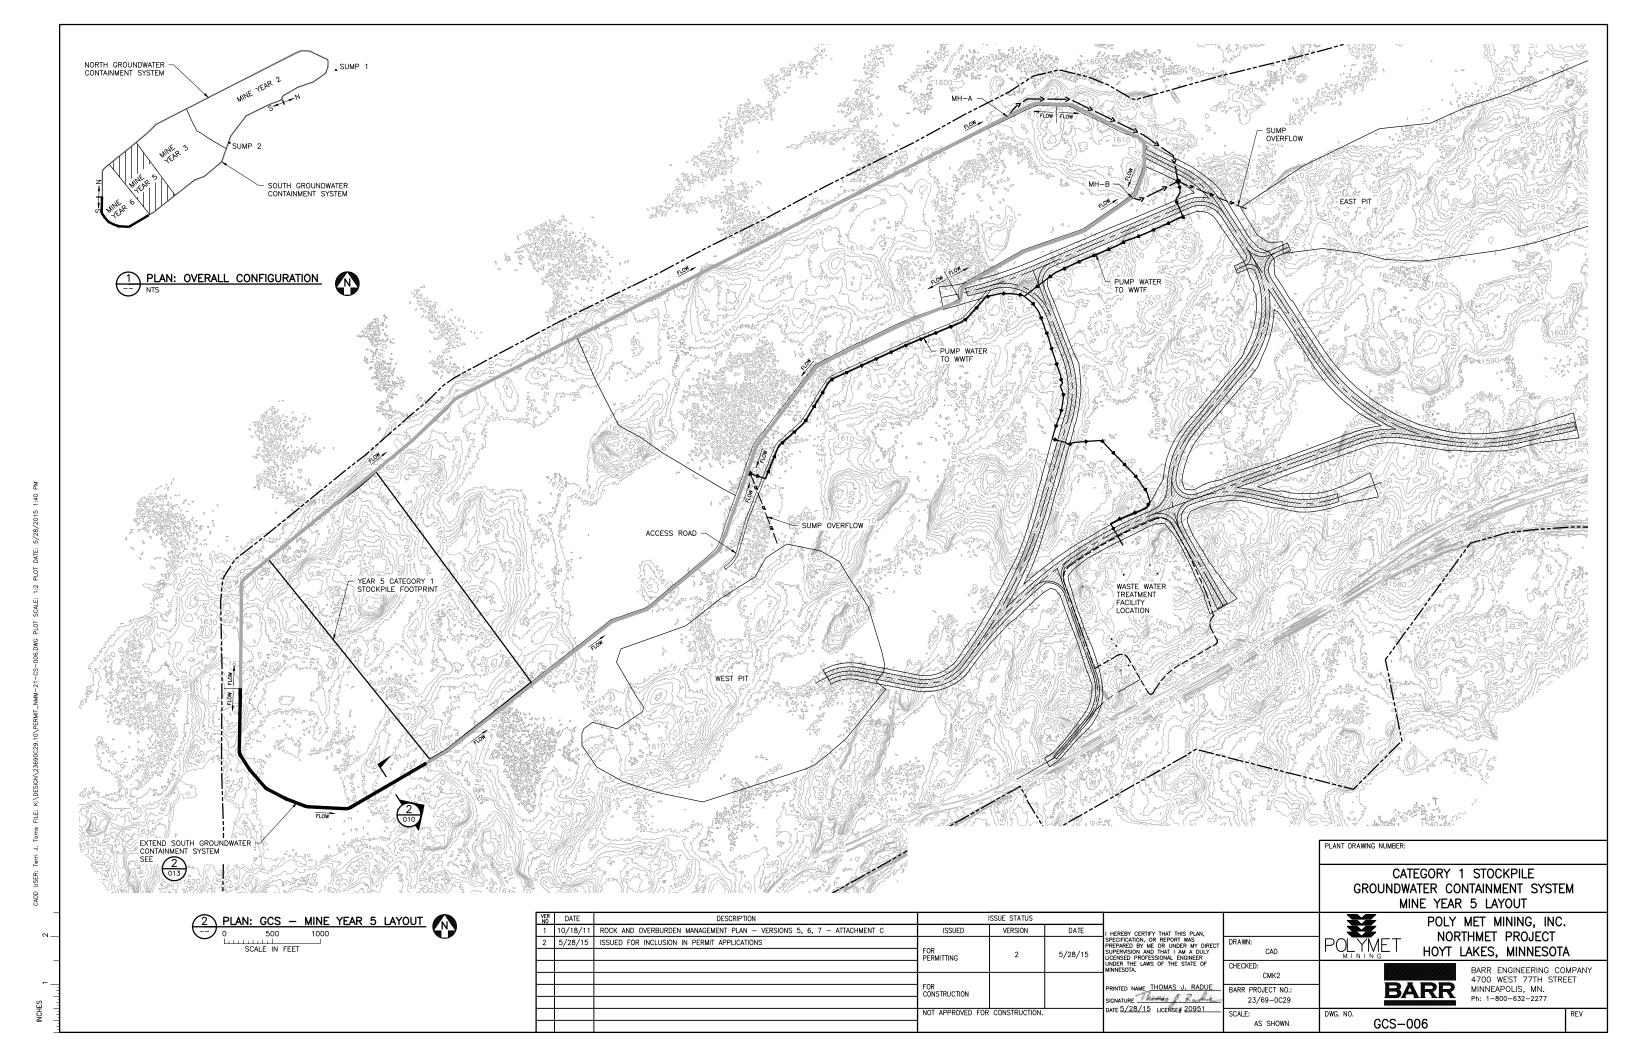

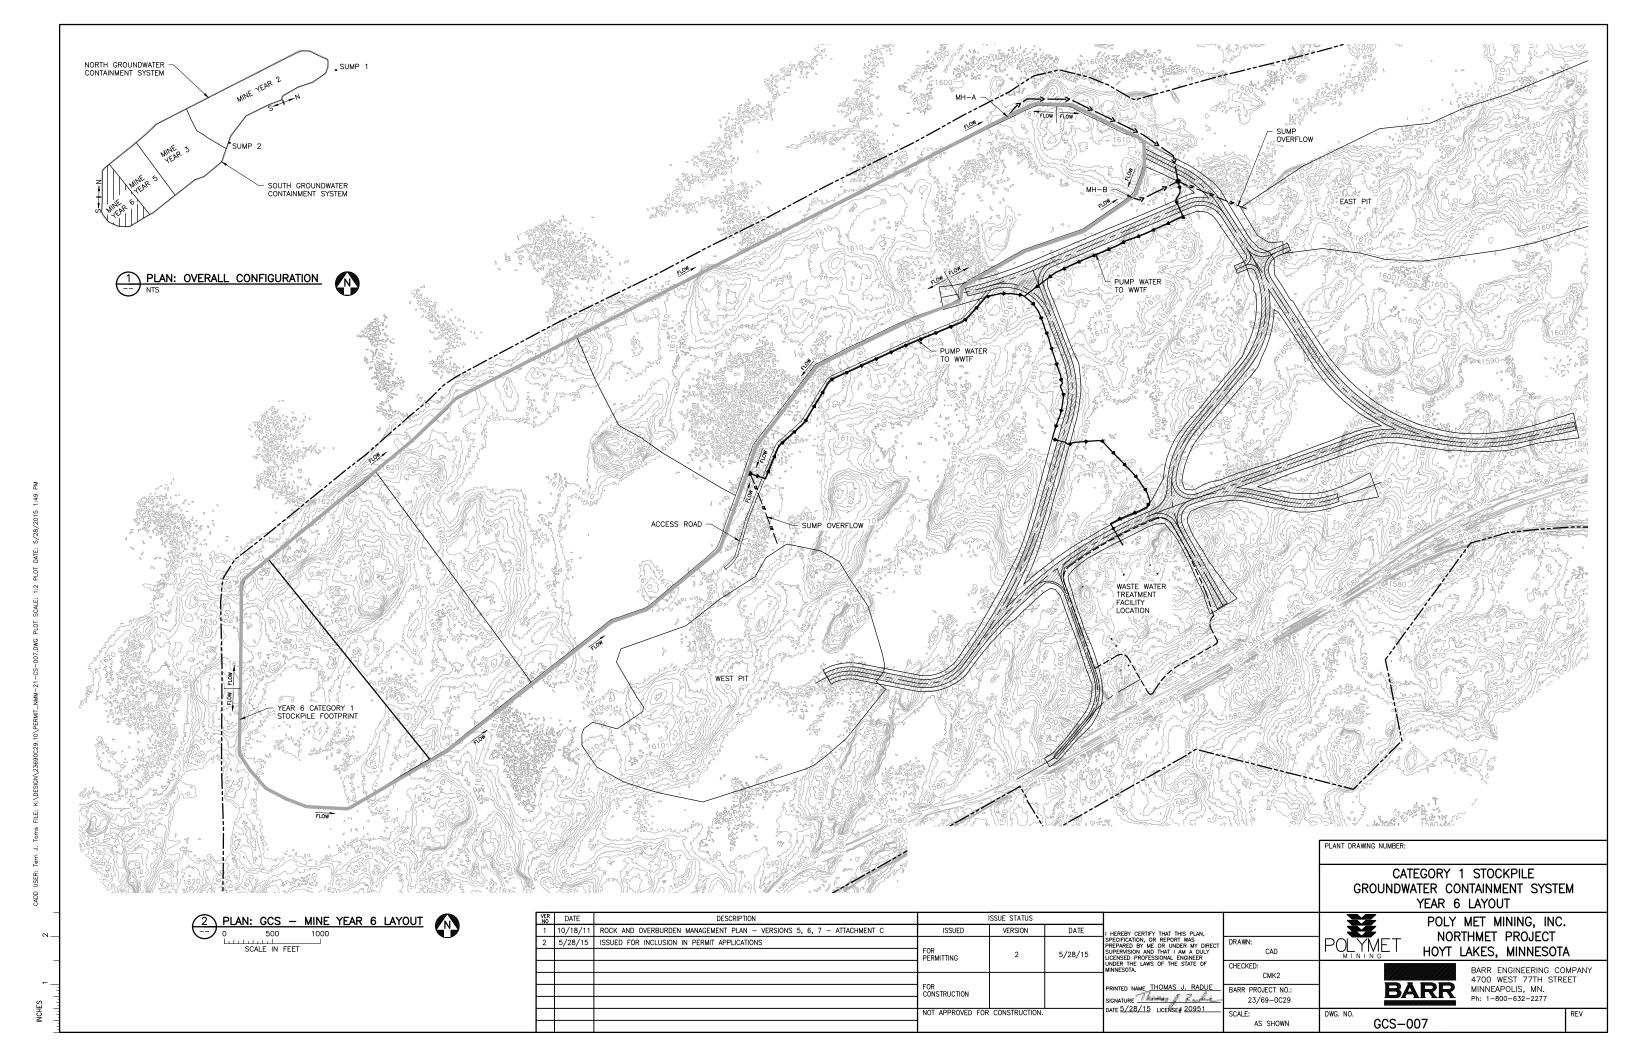

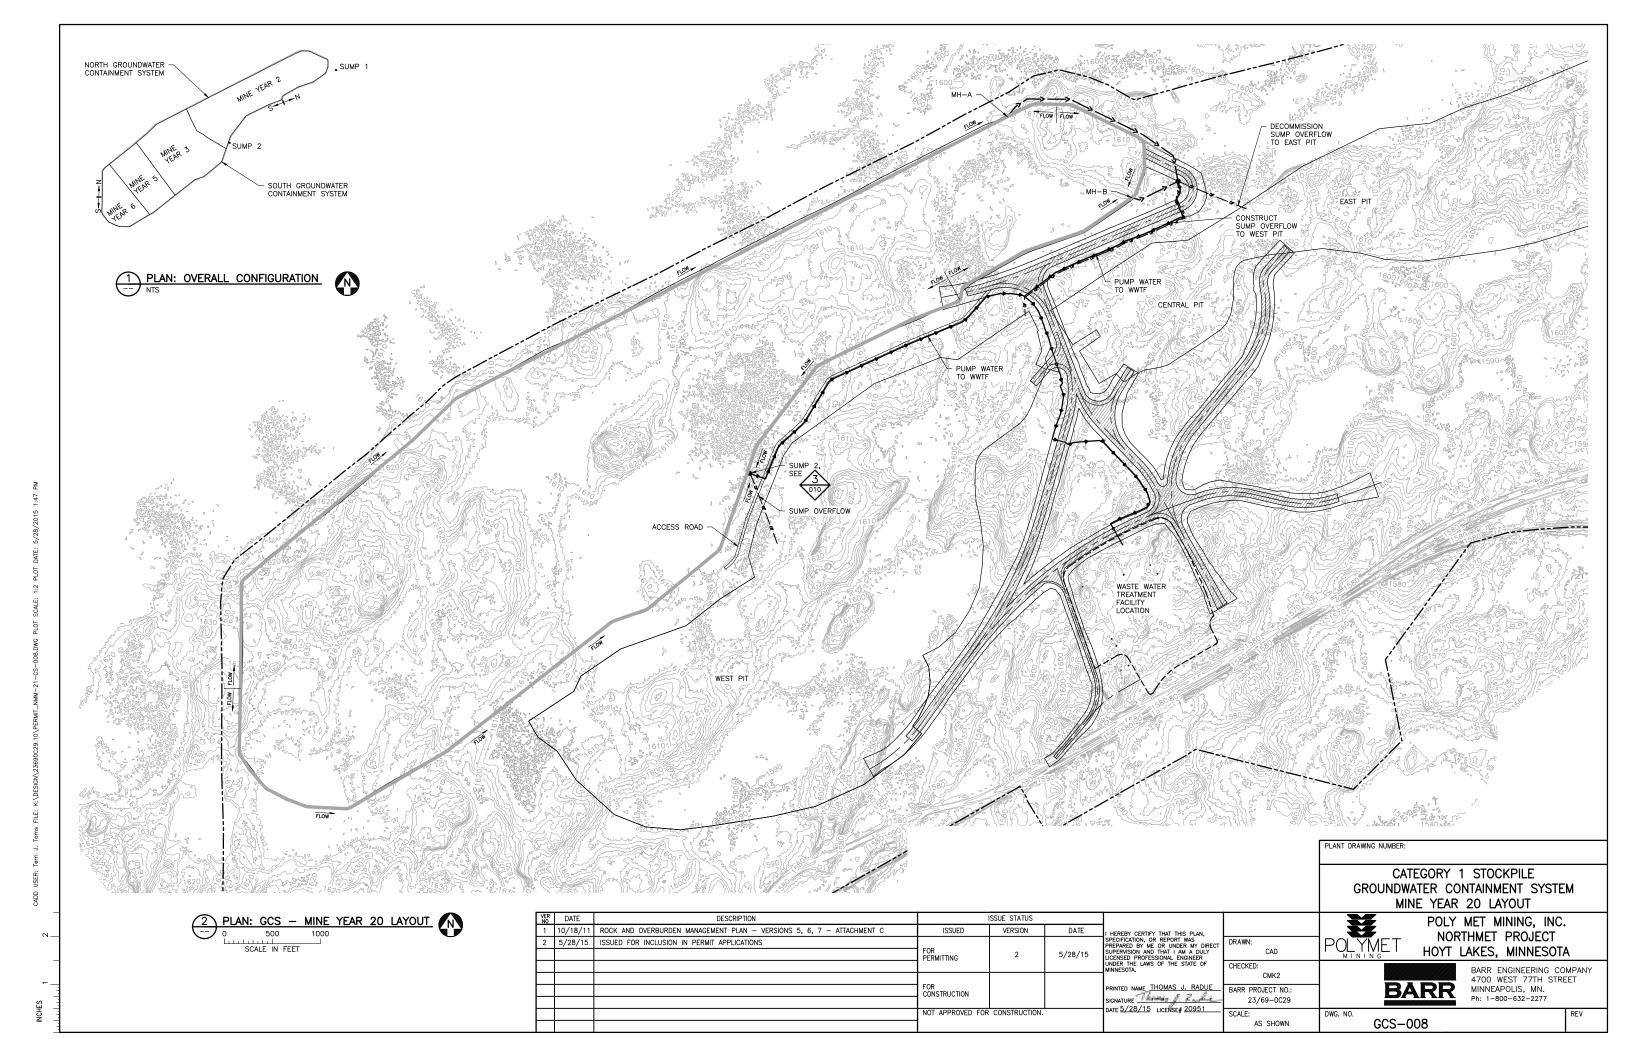

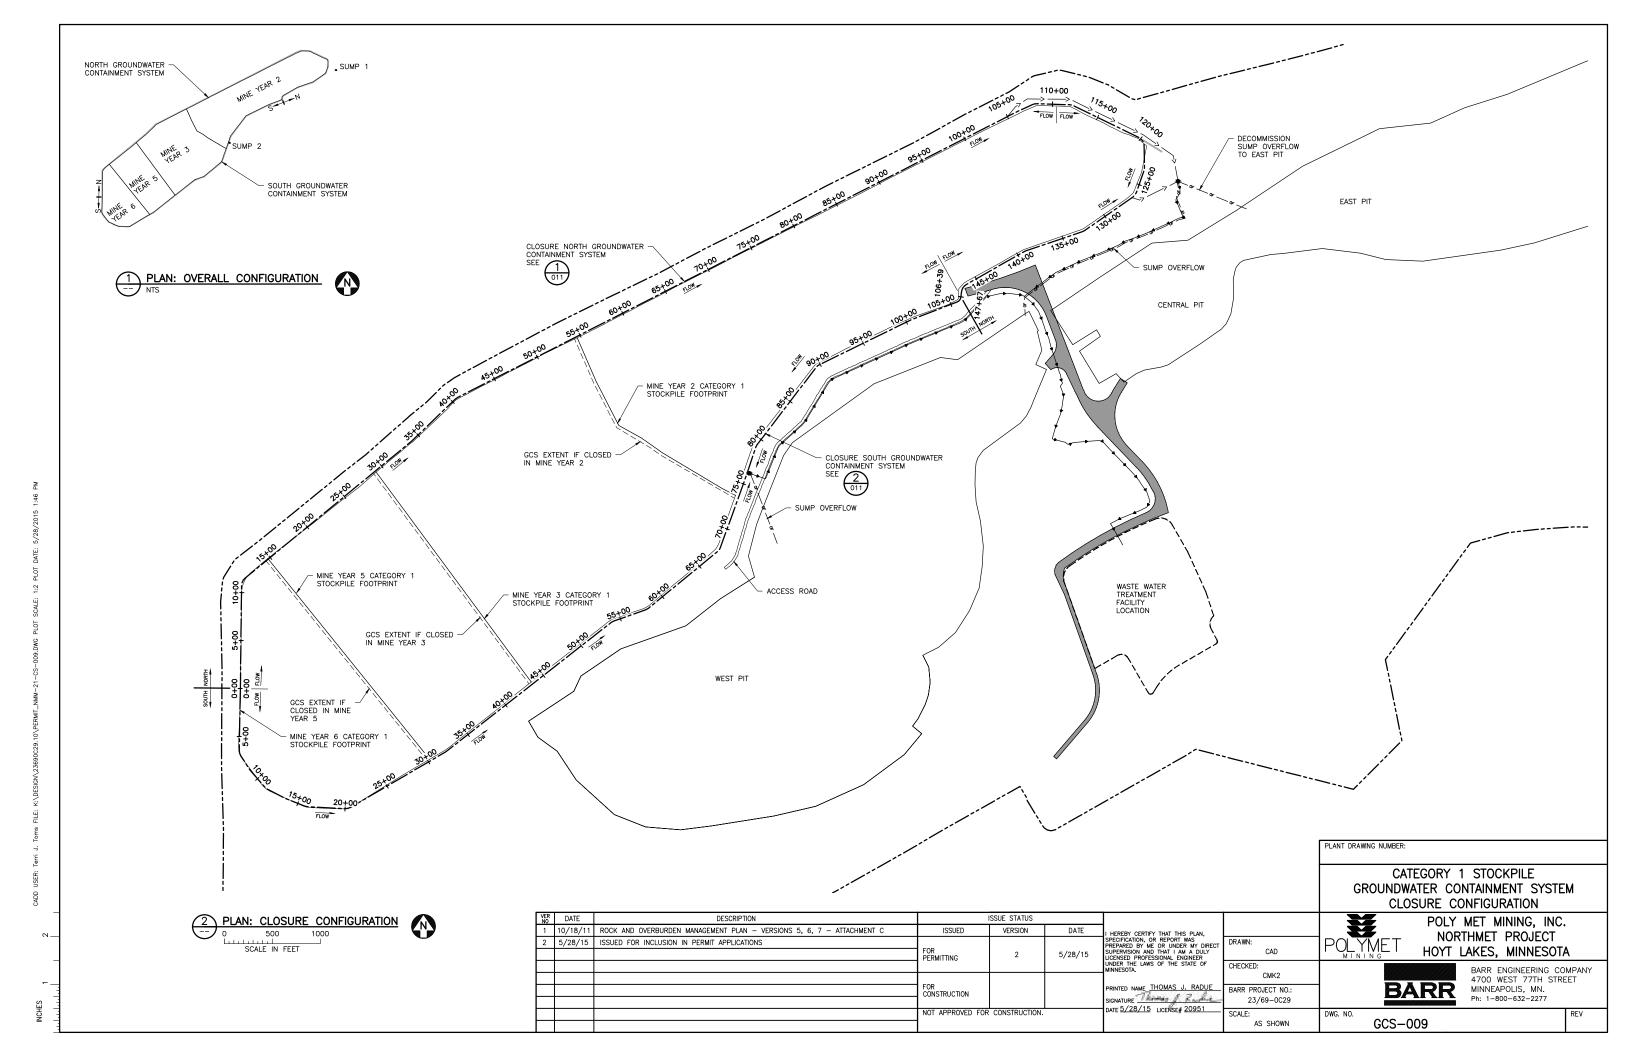

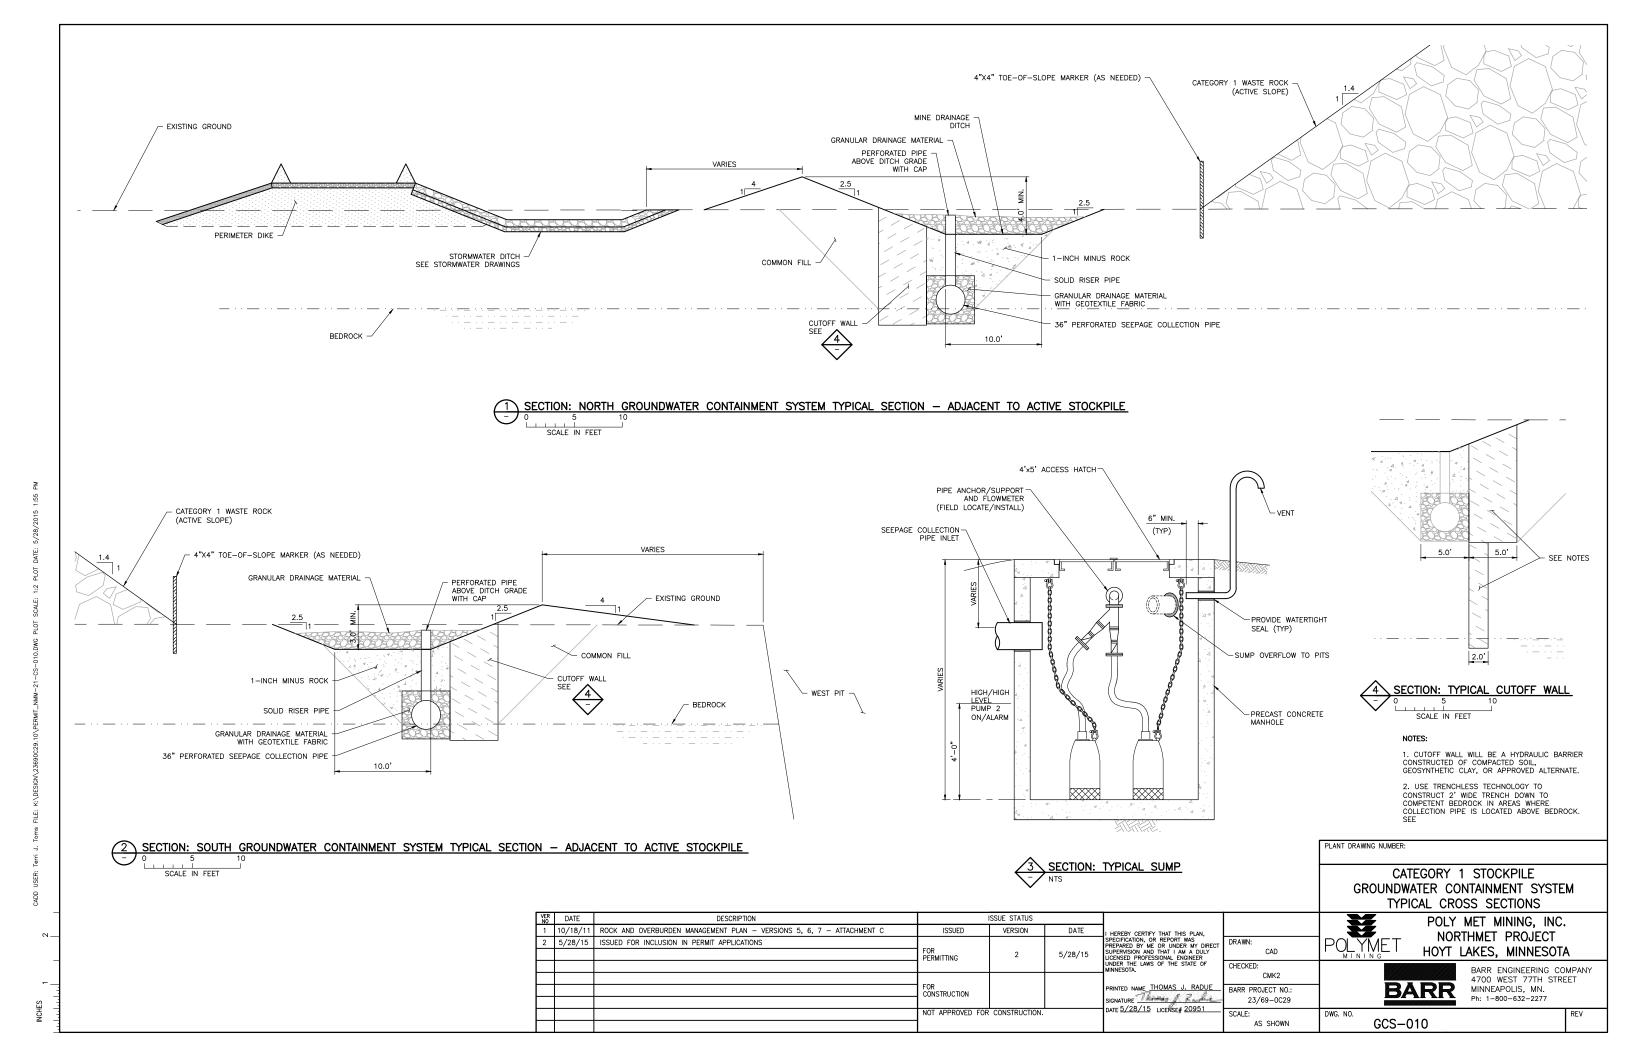

- EXISTING GROUND

CATEGORY 1 WASTE ROCK REGRADED TO FINAL GRADE

STOCKPILE COVER SEE STOCKPILE DRAWINGS

EXTEND SOLID PIPE TO FINISHED GROUND - MOVE CAP TO TOP OF PIPE

DRAIN ROCK TOE DRAIN -OVER GEOTEXTILE

VARIES

GEOMEMBRANE SEE STOCKPILE DRAWINGS

BARR ENGINEERING COMPANY 4700 WEST 77TH STREET MINNEAPOLIS, MN.

Ph: 1-800-632-2277


GROUNDWATER

MINE DRAINAGE WATER DITCH


STA = 0+00.00 EL = 1612.02

1630

- EXISTING GROUND

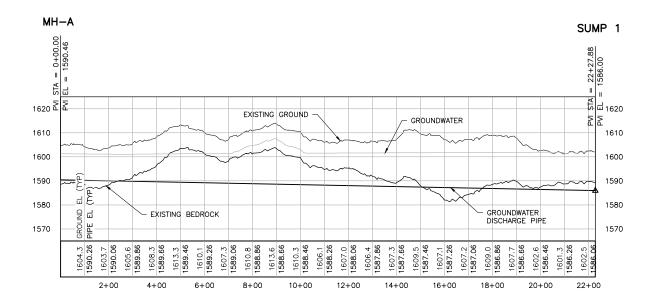

# PROFILE: MANHOLE A GROUNDWATER DISCHARGE PIPE TO SUMP 1

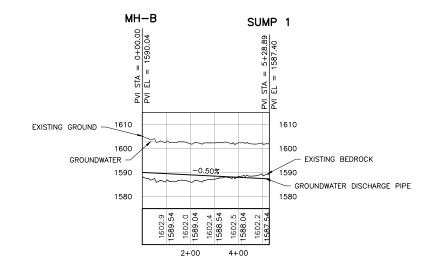

ALL GROUNDWATER AND BEDROCK PROFILES SHOWN ARE APPROXIMATE.

PLANT DRAWING NUMBER:

## PROFILE: MANHOLE B GROUNDWATER DISCHARGE PIPE TO SUMP 1

CATEGORY 1 STOCKPILE GROUNDWATER CONTAINMENT SYSTEM DISCHARGE PROFILES

VER NO	DATE	DESCRIPTION	ISSUE STATUS				
1	10/18/11	ROCK AND OVERBURDEN MANAGEMENT PLAN - VERSIONS 5, 6, 7 - ATTACHMENT C	ISSUED	VERSION	DATE	I HEREBY CERTIFY THAT THIS PLAN.	
2	5/28/15	ISSUED FOR INCLUSION IN PERMIT APPLICATIONS				SPECIFICATION, OR REPORT WAS PREPARED BY ME OR UNDER MY DIRECT SUPERVISION AND THAT I AM A DULY LICENSED PROFESSIONAL ENGINEER UNDER THE LAWS OF THE STATE OF MINNESOTA.	DRAWN:
			FOR PERMITTING	2	5/28/15		CAD
							CHECKED:
							CMK2
			FOR CONSTRUCTION			PRINTED NAME THOMAS J. RADUE	BARR PROJECT NO.:
						SIGNATURE	23/69-0C29
			NOT APPROVED FOR CONSTRUCTION.		DATE 3/26/13 LICENSE# 20951	SCALE:	
			1				AS SHOWN

POLYMET MINING POLY MET MINING, INC. NORTHMET PROJECT HOYT LAKES, MINNESOTA

GCS-014

BARR ENGINEERING COMPANY 4700 WEST 77TH STREET MINNEAPOLIS, MN. **BARR** Ph: 1-800-632-2277