## **Appendix 3**

Mine Site and Dunka Road Earthwork Permit Application Support
Drawings

### **Errata Sheet**

#### Poly Met Mining, Inc. NorthMet Project

# Permit Application Support Drawings: Mine Site and Dunka Road Earthwork November 2017 (version 4)

Engineering design is currently in progress. The table below lists changes that have been identified to-date and have not yet been incorporated in the attached permit application support drawings within this set. Final design will incorporate these changes along with additional site-specific information (e.g., supplementary geotechnical data); therefore, additional adjustments may be made during final design that will be incorporated into the final design drawing set.

Drawing Sheet(s)	Change		
Global change to all sheets, as needed	The terminology "mine drainage" as noted in these drawings will be changed to "mine water".		
EW-003	Temporary sedimentation basins or stormwater infiltration basins may be added to meet construction stormwater requirements along Dunka Road. These construction stormwater features require additional site-specific data and will be evaluated in final design.		
EW-008	All references to "pre-stripping" will be changed to "stripping"		
EW-002, EW-003, EW-005, EW-009, EW-010, EW-011	The "Mine Site Boundary" will be replaced by the "Mining Area Boundary" as shown on figures included in the Permit to Mine Application.		
EW-010, EW-011	Note 3 will be modified to read: "Reclamation of the Haul Roads will consist of removing safety berms through grading, seeding the regraded surface, and establishing a 15-foot-wide access road near the centerline of all haul roads."  Note 3 will be modified to read: "All active haul roads to be reclaimed."		

POLY MET MINING, INC. NORTHMET PROJECT

PERMIT APPLICATION SUPPORT DRAWINGS

**PROPOSED** 

PROPOSED ROADS

---1000----

PROPOSED CONTOUR - MAJOR

PROPOSED CONTOUR - MINOR

PROPOSED OTHER FACILITY

OTHER FACILITY PROPOSED CONTOUR - MAJOR

OTHER FACILITY PROPOSED CONTOUR - MINOR

**EXISTING** 

----- WATER EDGE/CREEK CENTER LINE

----R/W--- RIGHT OF WAY 

---- MINE SITE BOUNDARY EXISTING STRUCTURES

TREE LINE ₩ ) WETLAND BOUNDARY

 $-\!\!\!-\!\!\!-$  OE  $-\!\!\!\!-\!\!\!-$  EXISTING OVERHEAD ELECTRIC

--- UE --- EXISTING UNDERGROUND ELECTRIC

EXISTING VALVE > EXISTING CULVERT

PROPOSED MINE WATER CULVERT

#### **ABBREVIATIONS**

CATEGORY 1 STOCKPILE - CATEGORY 1 WASTE ROCK STOCKPILE CATEGORY 2/3 STOCKPILE - CATEGORY 2/3 WASTE ROCK STOCKPILE

CL CENTERLINE EW EARTHWORK

- MINE TO PLANT PIPELINES MPP ΟE - OVERHEAD ELECTRIC

STA STATION

SWPPP - STORMWATER POLLUTION PREVENTION PLAN

TYP TYPICAL

I, II, III, IV, V - ROMAN NUMERALS FOR RIPRAP CLASSIFICATION

#### SHEET INDEX


#### SHEET NO. TITLE

#### GENERAL DRAWINGS

AWINGS

LOCATION MAP AND SITE MAP
LEGEND AND SHEET INDEX
DUNKA ROAD UPGRADE GENERAL LAYOUT
DUNKA ROAD UPGRADE TYPICAL SECTION
HAUL ROADS GENERAL LAYOUT — MINE YEAR 11
HAUL ROADS TYPICAL SECTIONS AND DETAILS
HAUL ROADS TYPICAL SECTIONS AND DETAILS
PRE—STRIPPING PIT TYPICAL SECTION
OVERBURDEN STORAGE AND LAYDOWN AREA GRADING PLAN
HAUL ROAD CLOSURE PLAN MINE YEARS 1—11
HAUL ROAD CLOSURE PLAN MINE YEARS 11—20
RAIL TRANSFER HOPPER — PLEVATION VIEW
RAIL TRANSFER HOPPER — ELEVATION VIEW EW-001 EW-002 EW-003 EW-004 EW-005 EW-006 EW-007 EW-008 EW-009 EW-010 EW-010 EW-011 G-100-B G-101-B G-101-C

#### **DRAWING NUMBERING**

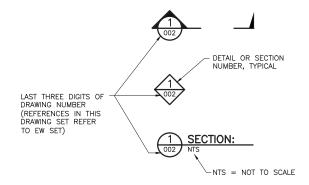

#### **NOTES**

- 1. COORDINATE SYSTEM IS MINNESOTA STATE PLANE NORTH ZONE,
- 2. ELEVATIONS ARE BASED ON MEAN SEA LEVEL (MSL), NAVD88.
- 3. EXISTING TOPOGRAPHIC INFORMATION SHOWN ON THE DRAWINGS WAS PREPARED BY AEROMETRIC, INC. FROM LIDAR DATA COLLECTED ON MARCH 17, 2010.

PLANT DRAWING NUMBER:

POLYMET

MINE SITE AND DUNKA ROAD EARTHWORK LEGEND AND SHEET INDEX

BARR

EW-002

POLY MET MINING, INC. NORTHMET PROJECT

HOYT LAKES, MINNESOTA

SUITE 200


MINNEAPOLIS, MN.


Ph: 1-800-632-2277

BARR ENGINEERING CO. 4300 MARKETPOINTE DRIVE


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VER NO	DATE	DESCRIPTION	ISSUE STATUS									
1	5/21/15	ISSUED FOR INCLUSION IN PERMIT APPLICATION	ISSUED	VERSION	DATE	I HEREBY CERTIFY THAT THIS PLAN.						
3	6/7/2017	PERMIT APPLICATION UPDATES	FOR PERMITTING				SPECIFICATION, OR REPORT WAS PREPARED BY ME OR UNDER MY DIRECT	DRAWN:				
										3	6///201/	SUPERVISION AND THAT I AM A DULY LICENSED PROFESSIONAL ENGINEER
						UNDER THE LAWS OF THE STATE OF MINNESOTA.	CHECKED:					
			FOR CONSTRUCTION				ATS					
									PRINTED NAME PAUL T. SWENSON	BARR PROJECT NO.:		
							SIGNATURE	23/69-0C29				
			NOT APPROVED FOR CONSTRUCTION.			DATE 5/26/17 LICENSE# 20533	SCALE:					
			1			l	AS SHOWN					



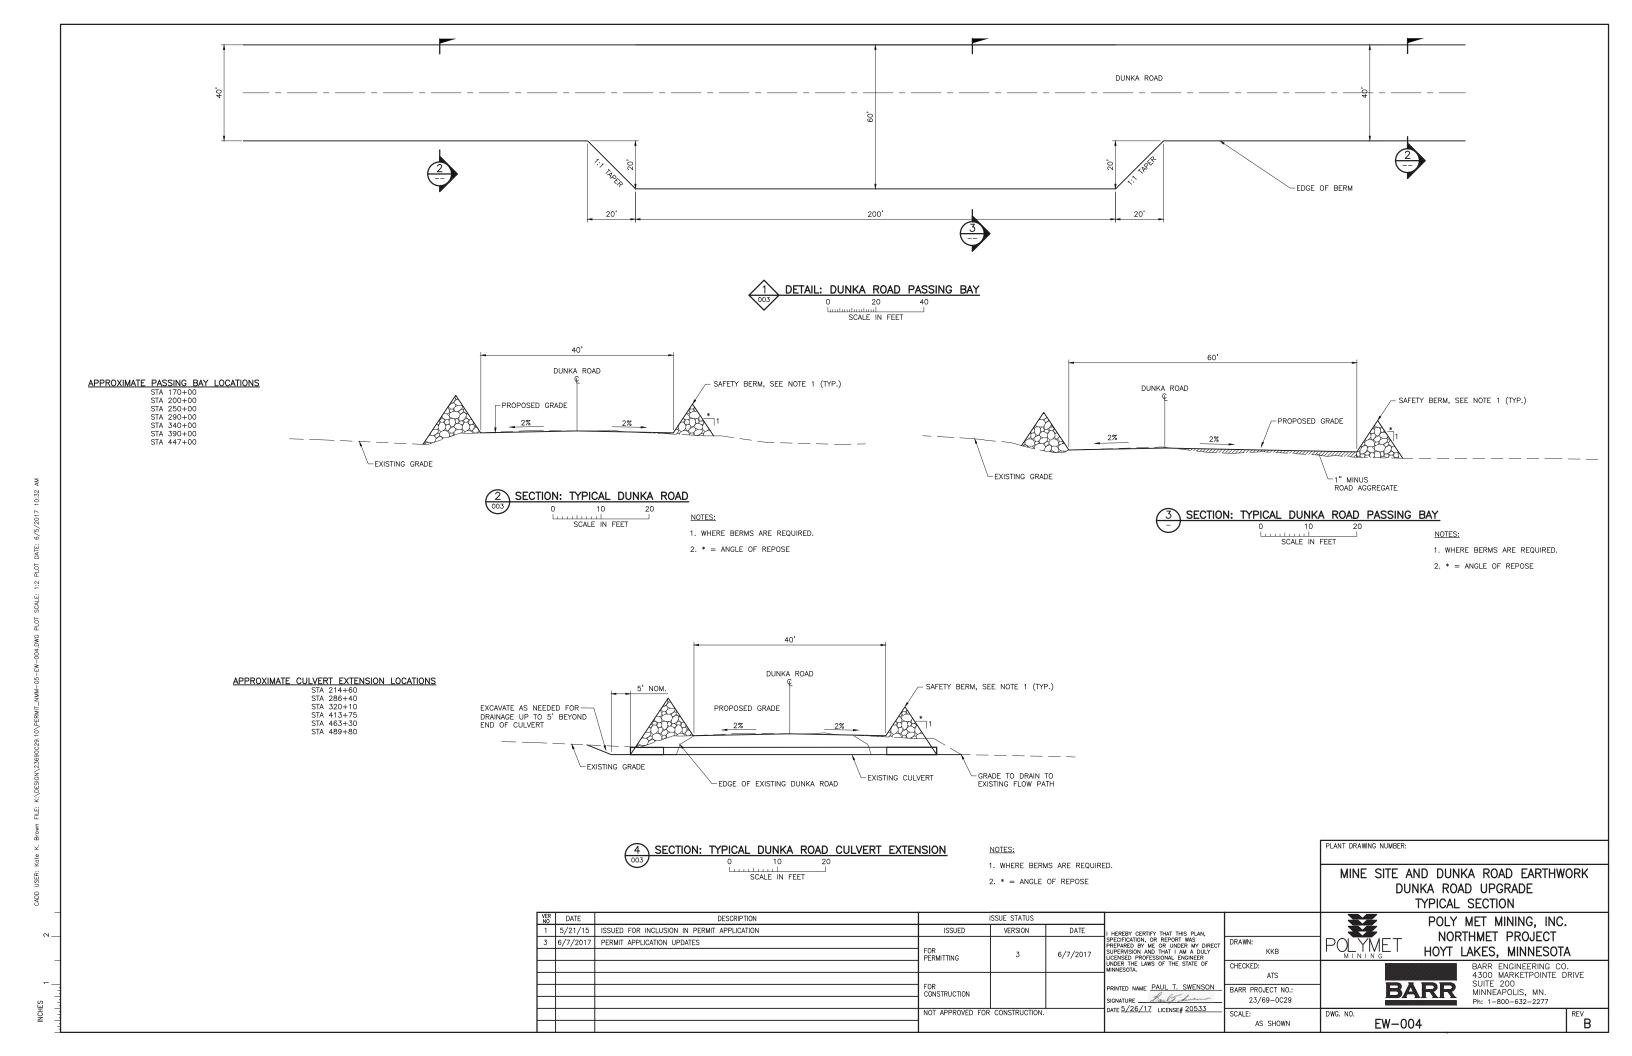

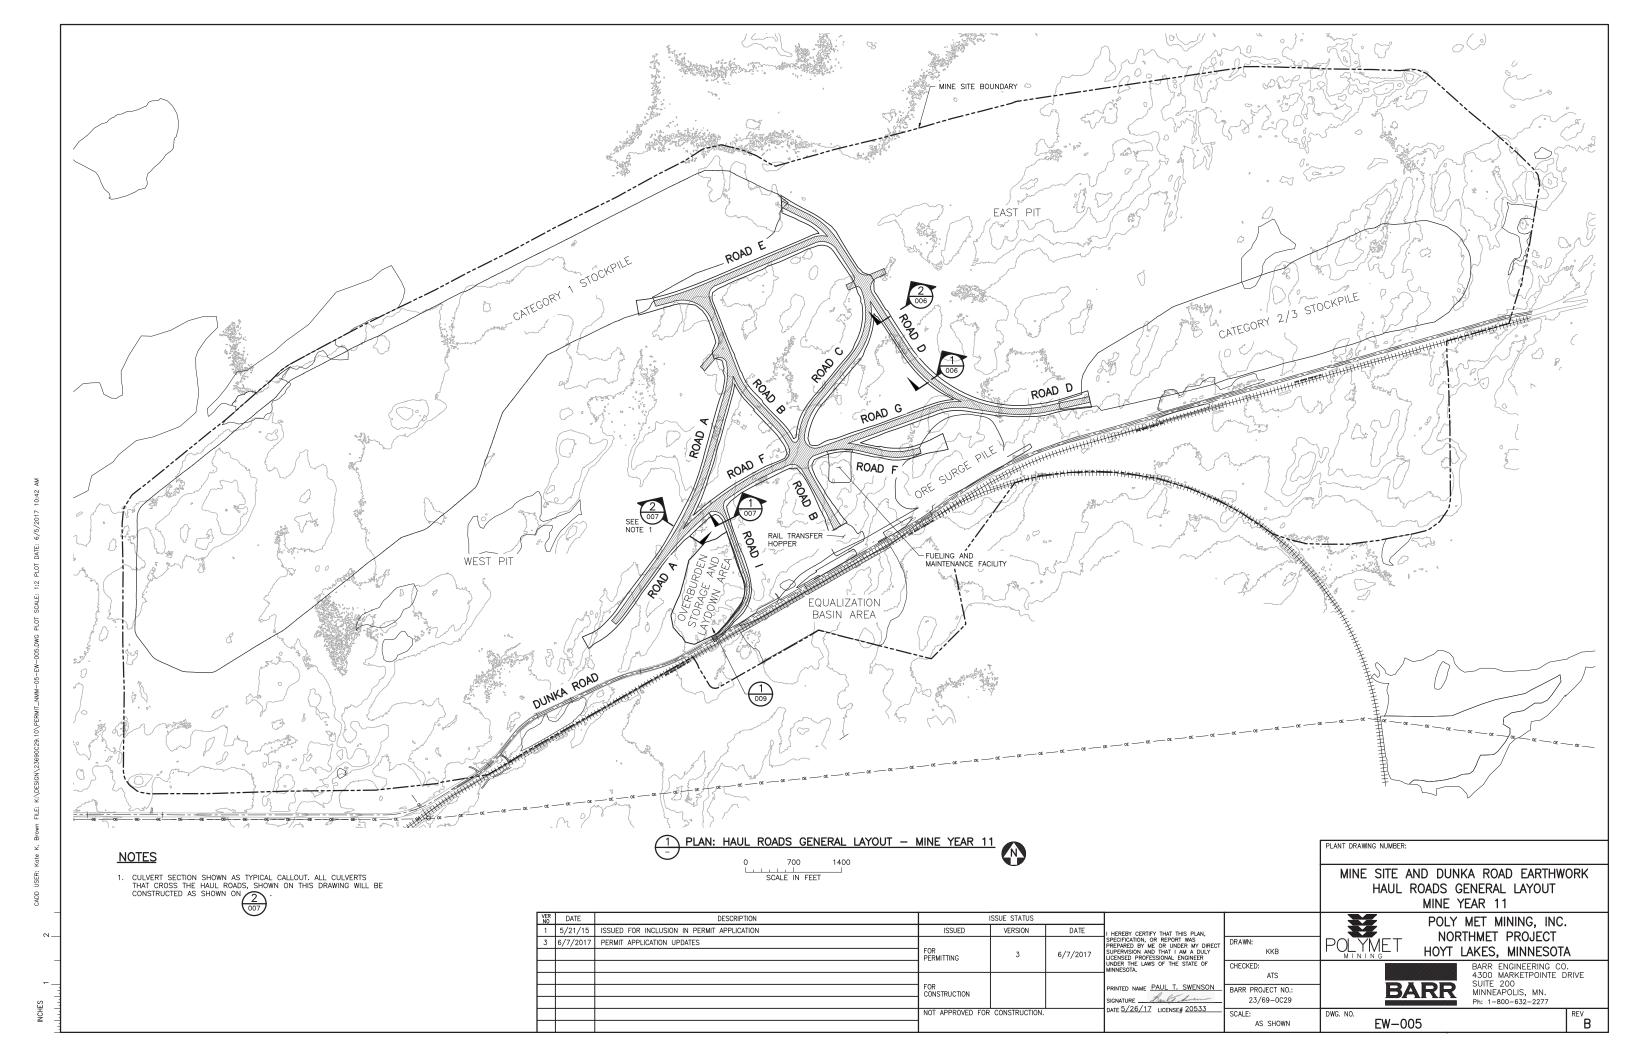40' ACCESS ROAD

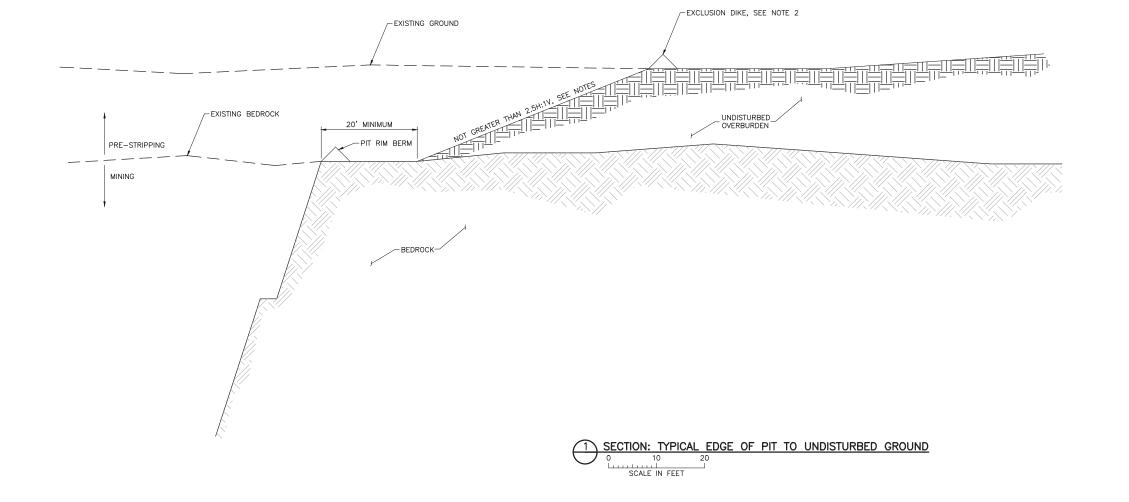

- PROPOSED FINISHED GRADE WITHIN PRE-STRIPPING AREA REFLECTS BEDROCK DATA PROVIDED BY POLYMET.
- 2. CONSTRUCT EXCLUSION DIKE AROUND PIT PERIMETER TO DIVERT SURFACE RUNOFF AWAY FROM PIT.
- FINAL PIT SLOPES SHALL ADHERE TO CHAPTER 6132.23 OVERBURDEN PORTION OF PITWALLS OF MINNESOTA DNR STANDARDS. AFTER GRADING IS COMPLETED, RECLAIM FINAL PIT SLOPES IN ACCORDANCE WITH MINE RECLAMATION PLAN.
- SLOPES IN AREAS WHERE ORGANIC SOILS AND WETLANDS ARE PRESENT MAY BE SLOPED AS NECESSARY TO MAINTAIN A STABLE SLOPE.
- 5. 20' BENCH SHALL BE ESTABLISHED FROM THE TOE OF THE OVERBURDEN TO THE FUTURE CREST OF ROCK IN ACCORDANCE WITH MINNESOTA DNR SIDEWALL DESIGN STANDARDS.
- CONTRACTOR SHALL LEAVE TEMPORARY HAUL ROADS WITHIN PRE-STRIPPING LIMITS IN PLACE FOR OWNER'S ACCESS.
- CONTRACTOR SHALL STOCKPILE OVERBURDEN IN LOCATIONS AND AT QUANTITIES TO BE APPROVED BY OWNER.

VE N	R DATE	DESCRIPTION	ISSUE STATUS				
	5/21/15	ISSUED FOR INCLUSION IN PERMIT APPLICATION	ISSUED	VERSION	DATE	I HEREBY CERTIFY THAT THIS PLAN.	
3	6/7/2017	PERMIT APPLICATION UPDATES	FOR PERMITTING	3	6/7/2017	SPECIFICATION, OR REPORT WAS PREPARED BY ME OR UNDER MY DIRECT SUPERVISION AND THAT I AM A DULY LICENSED PROFESSIONAL ENGINEER	DRAWN: KKB
			T EXMITTING			UNDER THE LAWS OF THE STATE OF MINNESOTA.	CHECKED:
$\vdash$			FOR CONSTRUCTION			PRINTED NAME PAUL T. SWENSON	BARR PROJECT NO.:
						SIGNATURE	23/69-0C29
$\vdash$			NOT APPROVED FOR CONSTRUCTION.			DATE 3/20/17 LICENSE# 20000	SCALE: AS SHOWN

MINE SITE AND DUNKA ROAD EARTHWORK PRE-STRIPPING PIT TYPICAL SECTION

POLY MET MINING, INC. NORTHMET PROJECT POLYMET HOYT LAKES, MINNESOTA

EW-008

PLANT DRAWING NUMBER:

AS SHOWN

BARR ENGINEERING CO. 4300 MARKETPOINTE DRIVE SUITE 200 MINNEAPOLIS, MN. Ph: 1–800–632–2277 BARR

REV B

