Appendix 8

Mechanical Infrastructure Permit Application Support Drawings

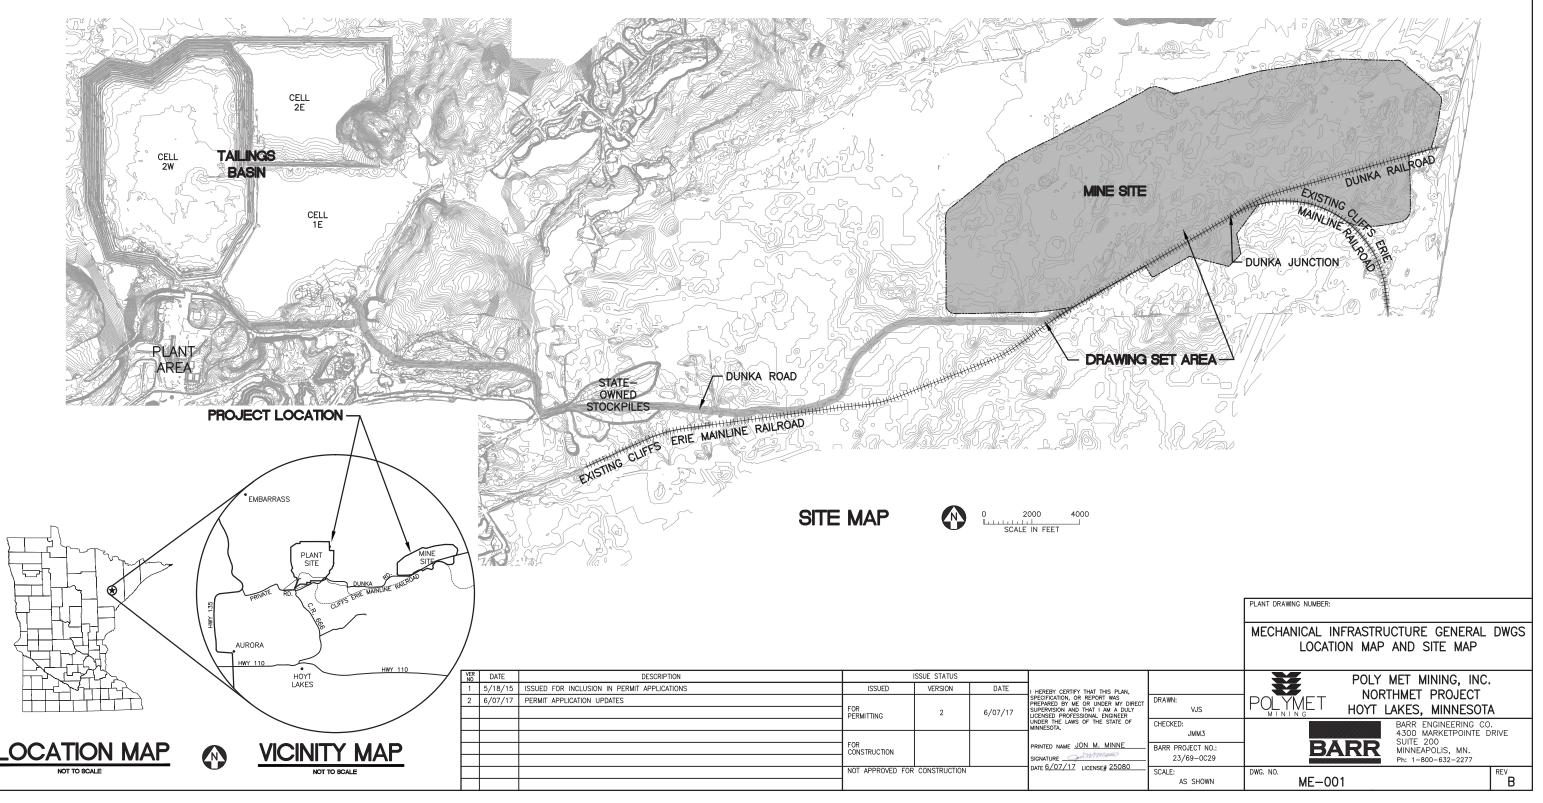
Errata Sheet

Poly Met Mining, Inc. NorthMet Project Permit Application Support Drawings: Mechanical Infrastructure November 2017 (version 4)

Engineering design is currently in progress. The table below lists changes that have been identified todate and have not yet been incorporated in the attached permit application support drawings within this set. Final design will incorporate these changes along with additional site-specific information (e.g., supplementary geotechnical data); therefore, additional adjustments may be made during final design that will be incorporated into the final design drawing set.

Drawing Sheet(s)	Change
Global change to all sheets, as needed	The terminology "mine drainage" as noted in these drawings will be changed to "mine water".
MPP-009	The berm over the MPP will be revised to match the contours of the road where it crosses the proposed access road near the Equalization Basin Area.
MPP-010	The option of 1" minus rock as the top berm surface was eliminated to minimize additional impervious surfaces. Remove "or 1" minus rock" text on Sections 1, 2, 4, & 5.
MW-001	An access road will be added adjacent to a Mine Water pipe for construction and maintenance purposes. This access road will follow the Mine Water pipe that connects the Category 1 Stockpile and Haul Road F (in a general north-south orientation).
MW-003	The grading for the access road from the Mine Site Fueling and Maintenance Facility (MSFMF) to Pond MW-SOSP & Sump SOSP will be revised to optimize drainage.
ME-002, MPP-001, MPP-007, MPP-008, MPP-009, MW-001, MW-002, MW-007, MW-008, MW- 016	The "Mine Site Boundary" will be replaced by the "Mining Area Boundary" as shown on figures included in the Permit to Mine Application.
MW-016	Note 4 will be changed to: "Reclamation of the mine water sumps and ponds will require cleanout and removal of the geomembrane liner. Sediment removed from the ponds will be disposed of in the East Pit. The geomembrane liners will be recycled or properly disposed of at a permitted solid waste facility."
MW-016	Note 6 will be added: "Mine water pipes and pumps needed in the reclamation, closure and postclosure maintenance phases include those used by the Category 1 Stockpile Groundwater Containment System and those used for the flooding of the West Pit or cycling of the East Pit water."
ME-003	All references to "pre-stripping" will be changed to "stripping"

POLY MET MINING, INC. NORTHMET PROJECT PERMIT APPLICATION SUPPORT DRAWINGS MECHANICAL INFRASTRUCTURE HOYT LAKES, MINNESOTA



MECHANICAL INFRASTRUCTURE LEGEND

MINE WATER DRAWINGS

GENERAL

	EXISTING CONTOUR - MAJOR		PROPOSED MINE WATER PIPE
	EXISTING CONTOUR - MINOR		TOP OF DIKE BENCH PROPOSED MINE WATER CULVERT
	PROPOSED CONTOUR - MAJOR	Ó	PROPOSED SUMP MANHOLE
	PROPOSED CONTOUR - MINOR	MPP MPP	PROPOSED MINE TO PLANT PIPELINES
			PROPOSED HAUL ROAD MINE WATER DITCH
—1000—	OTHER FACILITY PROPOSED CONTOUR - MAJOR		PROPOSED STOCKPILE LINER OUTLET PIPE
	OTHER FACILITY PROPOSED CONTOUR - MINOR		PROPOSED MINE WATER WATERSHED
+++++++++++++++++++++++++++++++++++++++	PROPOSED RAILROAD		
+++++++++++++++++++++++++++++++++++++++	EXISTING RAILROAD		
	PROPOSED ACCESS ROADS		
	EXISTING ROAD		
	MINE SITE BOUNDARY		
<u>_</u>	WETLAND BOUNDARY		
	HAUL ROAD		
	MINE TO PLANT PIPELINES DRAWINGS		
8	EXISTING POWER POLE		
	EXISTING TRAIL		
=====	EXISTING UNIMPROVED TRAIL		
—— R/W—	RIGHT OF WAY		
	EXISTING STRUCTURES		
$\sim \sim \sim$	TREE LINE		
OE	EXISTING OVERHEAD ELECTRIC		
	EXISTING UNDERGROUND ELECTRIC		
	PROPOSED MINE TO PLANT PIPELINES		

- PROPOSED CULVERT (NON-MINE WATER) \succ
 - PROPOSED MINE WATER PIPE -

<u>NOTES</u>

1. COORDINATE SYSTEM IS MINNESOTA STATE PLANE NORTH ZONE, NAD83.

2. ELEVATIONS ARE MEAN SEA LEVEL (MSL), NAVD88.

3. EXISTING TOPOGRAPHIC INFORMATION SHOWN ON THE DRAWINGS WAS PREPARED BY AEROMETRIC, INC. FROM LIDAR DATA COLLECTED ON MARCH 17, 2010.

SHEET NO. TITLE

MECHANICAL INFRASTRUCTURE GENERAL DRAWINGS

	LOCATION MAP AND SITE MAP
ME-002	LEGEND & SHEET INDEX
ME-003	MINE SITE - MINE WATER FLOW DIAGRAM
ME-004	MINE SITE - SUMP, POND AND PIPE DETAIL TABL

MINE TO PLANT PIPELINES DRAWINGS

MPP-001	GENERA	L LAYOUT	AND SHE	EET INDE>	(
MPP-002A	PLAN S	TATION 10	+00 TO	77+68		
MPP-002B	PLAN &	: PROFILE	STATION	113+70	TO	130+00
MPP-003	PLAN &	: PROFILE	STATION	130+00	TO	190+00
MPP-004	PLAN &	: PROFILE	STATION	190+00	TO	250+00
MPP-005	PLAN &	: PROFILE	STATION	250+00	TO	310+00
MPP-006	PLAN &	: PROFILE	STATION	310+00	TO	370+00
MPP-007	PLAN &	: PROFILE	STATION	370+00	TO	430+00
MPP-008	PLAN &	: PROFILE	STATION	430+00	TO	490+00
MPP-009	PLAN &	: PROFILE	STATION	490+00	TO	512+50
MPP-010	PIPELIN	E INSTALL	ATION TYP	PICAL SEC	CTIO	NS
MPP-011	DETAILS					
MPP-012	DETAILS	IN CLOSU	JRE			

ABBREVIATIONS

AC-FT	_	ACRE-FEET
AVE	_	AVERAGE
CAT	-	CATEGORY
Ф.	_	CENTERLINE
СMР	-	CORRUGATED METAL PIPE
CPS	-	CENTRAL PUMPING STATION
DIP	-	DUCTILE IRON PIPE
DV	_	DRAIN VALVE
DWG	_	DRAWING
EL.	_	ELEVATION
GAL	_	GALLONS
GCL	-	
GPM	_	GALLONS PER MINUTE
HDPE	_	HIGH-DENSITY POLYETHYLENE
HRC	_	HAUL ROAD CENTRAL
HRE	_	HAUL ROAD EAST
HRN	_	HAUL ROAD NORTH
HRW	_	HAUL ROAD WEST
INV	_	INVERT
LF	_	LINEAR FEET
MG	_	MILLION GALLONS
МН	_	MANHOLE
MIL	_	MEASUREMENT OF LINER THICKNESS: A MIL I
MIN	_	MINIMUM
MnDOT	_	MINNESOTA DEPARTMENT OF TRANSPORTATION
MPP	-	MINE TO PLANT PIPELINES
MW	_	MINE WATER
OSLA	_	OVERBURDEN STORAGE AND LAYDOWN AREA
OSP	_	ORE SURGE PILE
PL	_	PIPELINE
PSI	-	
RTH	-	RAIL TRANSFER HOPPER
SDR	-	STANDARD DIMENSION RATIO
STA	-	STATION
STOCKPIL	E—	WASTE ROCK STOCKPILE
TDH	-	TOTAL DESIGN HEAD
TYP	-	TYPICAL
V/A	-	VACUUM/AIR RELIEF
WWTS	-	WASTE WATER TREATMENT SYSTEM

VER NO	DATE	DESCRIPTION		SSUE STATUS		
1	5/18/15	ISSUED FOR INCLUSION IN PERMIT APPLICATIONS	ISSUED	VERSION	DATE	I HEREBY CERTIFY THAT THIS PLAN,
2	6/07/17	PERMIT APPLICATION UPDATES	FOR PERMITTING	2	6/07/17	SPECIFICATION, OR REPORT WAS PREPARED BY ME OR UNDER MY DIRE SUPERVISION AND THAT I AM A DULY LICENSED PROFESSIONAL ENGINEER UNDER THE LAWS OF THE STATE OF MINNESOTA.
			FOR CONSTRUCTION			
			NOT APPROVED FOR	CONSTRUCTION		DATE <u>6/07/17</u> LICENSE# <u>25080</u>

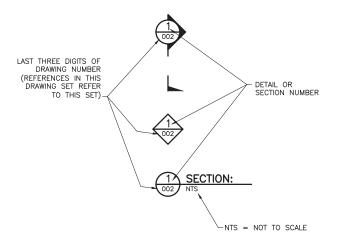
SHEET INDEX

SHEET NO. TITLE

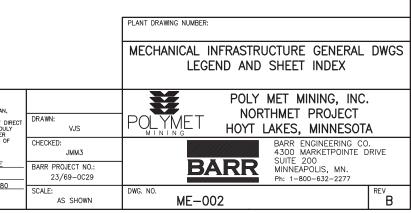
MINE WATER DRAWINGS

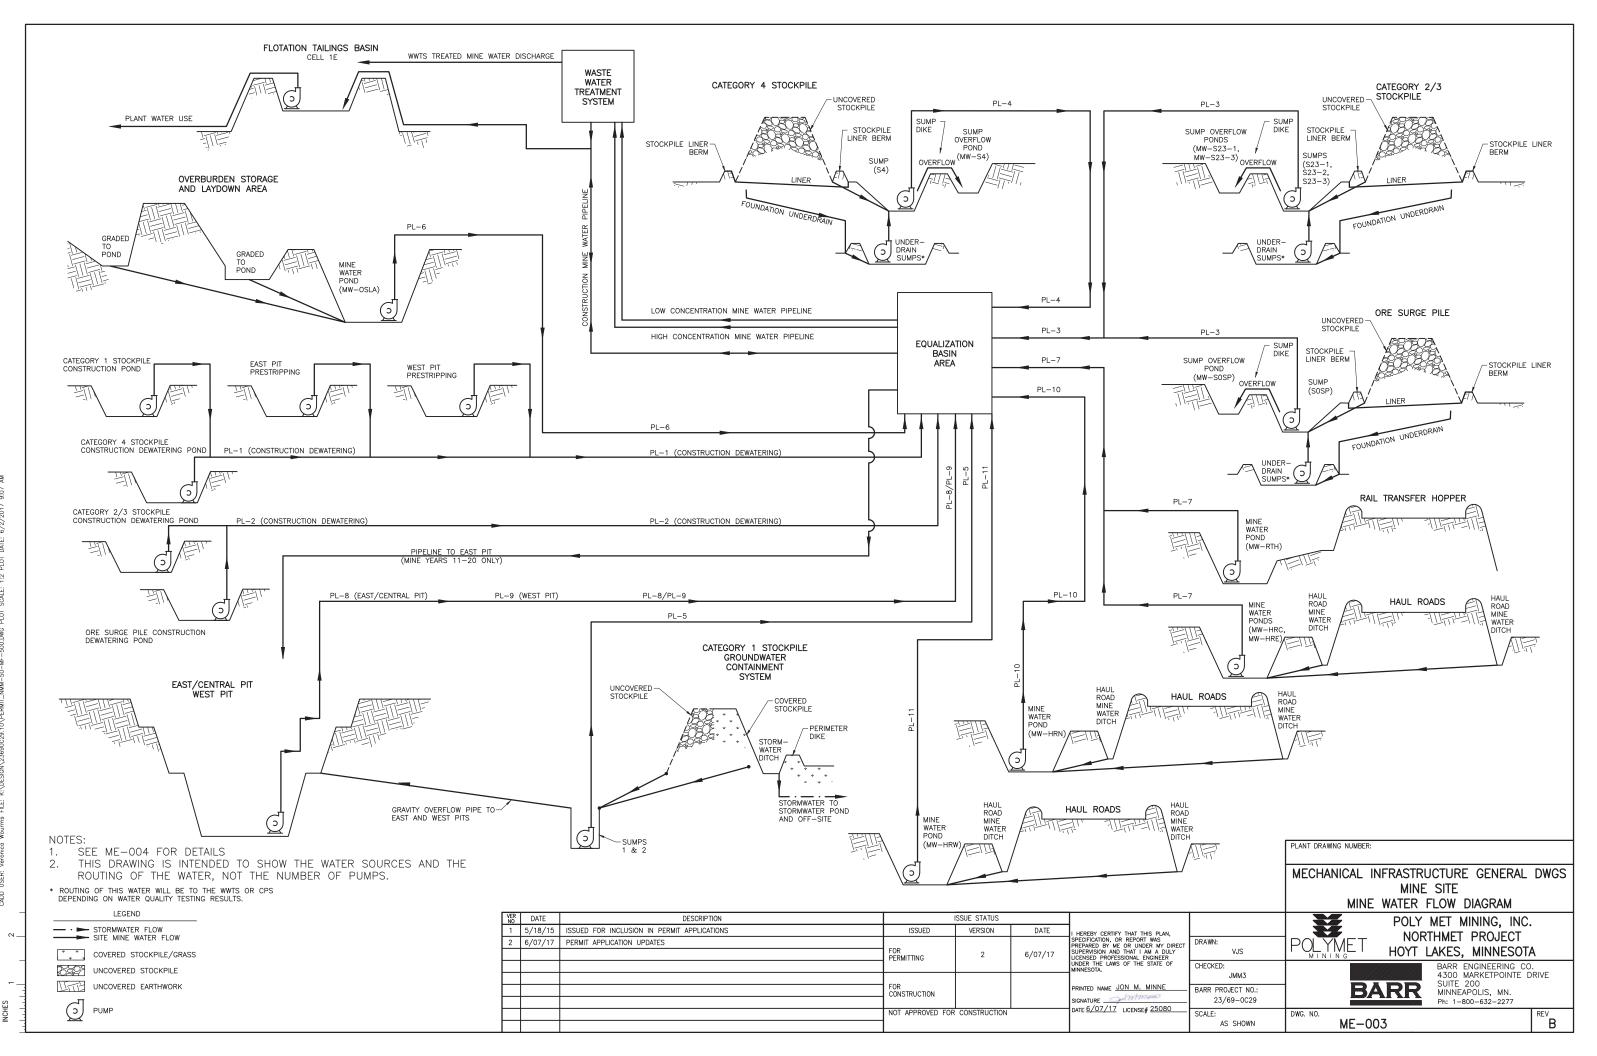
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-	20

DRAWING NUMBERING



MIL IS A THOUSANDTH OF AN INCH ATION





<u>SUMPS – TEMPORARY</u>

				DESIGN	APPROXIMA CAPA			ACTUAL		
ID	DESCRIPTION	OBJECTIVES	MINE YEARS	VOLUME* (GAL)	GPM	TDH (FT)	LINER TYPE	VOLUME* (GAL)	OVERFLOWS TO	SHOWN ON SHEET #
S23-1	CATEGORY 2/3 STOCKPILE SUMP	PROVIDE RUNOFF STORAGE FOR THE 10 YEAR 24 HOUR EVENT	1-19	4,855,000	190	210	MINE WATER SUMP LINER	4,855,000	MW-S23-1	MW-005
S23–2	CATEGORY 2/3 STOCKPILE SUMP	PROVIDE RUNOFF STORAGE FOR THE 10 YEAR 24 HOUR EVENT	3–17	3,878,000	150	230	MINE WATER SUMP LINER	3,910,000	MW-S23-1	MW-006
S23–3	CATEGORY 2/3 STOCKPILE SUMP	PROVIDE RUNOFF STORAGE FOR THE 10 YEAR 24 HOUR EVENT	6-16	2,151,000	90	270	MINE WATER SUMP LINER	2,151,000	MW-S23-3	MW-007
S4	CATEGORY 4 STOCKPILE SUMP	PROVIDE RUNOFF STORAGE FOR THE 10 YEAR 24 HOUR EVENT	1-11	3,291,000	130	50	MINE WATER SUMP LINER	4,073,000	MW-S4	MW-004
SOSP	ORE SURGE PILE SUMP	PROVIDE RUNOFF STORAGE FOR THE 10 YEAR 24 HOUR EVENT	1-20	2,770,000	80	90	MINE WATER SUMP LINER	2,835,000	MW-SOSP	MW-003

* DESIGN VOLUME REFLECTS THE VOLUME REQUIRED BASED ON THE DESIGN NEEDS; WHEREAS ACTUAL VOLUME REFLECTS THE VOLUME SHOWN IN THE ATTACHED DRAWING SET. ACTUAL VOLUME DOES NOT INCLUDE ADDITIONAL VOLUME FROM 3 FEET OF FREEBOARD

MINE PIT SUMPS

				INITIAL SUMP		APPROXIMATE P – INITIAL YEAR YEA		
ID	DESCRIPTION	OBJECTIVES	MINE YEARS	CAPACITY (AC-FT)	MAXIMUM SUMP CAPACITY (AC-FT)	GPM	TDH (FT)	OVERFLOWS TO
WP-W	WEST PIT - WEST SUMP	*COLLECTION IN PIT	2-20	6.6	14.0	YEAR 2: 820 YEAR 20: 1,590	YEAR 2: 120 YEAR 20: 740	NONE
WP-E	WEST PIT – EAST SUMP	*COLLECTION IN PIT	10-20	4.7	9.4	YEAR 10: 530 YEAR 20: 1,050	YEAR 10: 110 YEAR 20: 350	NONE
EP	EAST PIT	*COLLECTION IN PIT	1-20	11.6	19.5	YEAR 1: 1,520 YEAR 11: 2,340		NONE
CP	CENTRAL PIT	*COLLECTION IN PIT	11-20	3.8	3.8	YEAR 11: 440 YEAR 16: 440	YEAR 1: 60 YEAR 16: 390	NONE

+ PIT COLLECTION IS BASED ON 40% OF THE AVERAGE ANNUAL SNOW MELT OCCURRING WITHIN ONE DAY AND THE PUMP CAPACITY DESIGNED TO REMOVE THAT SNOW MELT EVENT WITHIN 3 DAYS

<u>SUMPS – PERMANENT</u>

						ATE PUMP			
ID	DESCRIPTION	OBJECTIVES	MINE YEARS	(GAL)	GPM	TDH (FTI)	LINER TYPE	OVERFLOWS TO	SHOWN ON SHEET #
SUMP 1	CATEGORY 1 STOCKPILE SUMP – EAST	COLLECTION FOR GROUNDWATER CONTAINMENT SYSTEM	1-20+	NA – MANHOLE	7,200	50	NA – MANHOLE	EAST PIT	SEE CATEGORY 1 STOCKPILE CONTAINMENT SYSTEM
SUMP 2	CATEGORY 1 STOCKPILE SUMP - WEST	COLLECTION FOR GROUNDWATER CONTAINMENT SYSTEM	1-20+	NA – MANHOLE	7,200	50	NA – MANHOLE	WEST PIT	DRAWING SET

NOTES:

ACTUAL PUMP, PIPE, AND POND SIZES WILL BE OPTIMIZED IN FINAL DESIGN
 STANDARDIZED PUMP SIZE TO BE DETERMINED DURING FINAL DESIGN
 MINE WATER SUMP LINER IS SHOWN IN DETAIL 1 ON SHEET MW-014
 MINE WATER POND LINER IS SHOWN IN DETAIL 2 ON SHEET MW-014
 ALL PUMP CAPACITY FLOWS AND TDH VALUES HAVE BEEN ROUNDED

MINE WATER PONDS

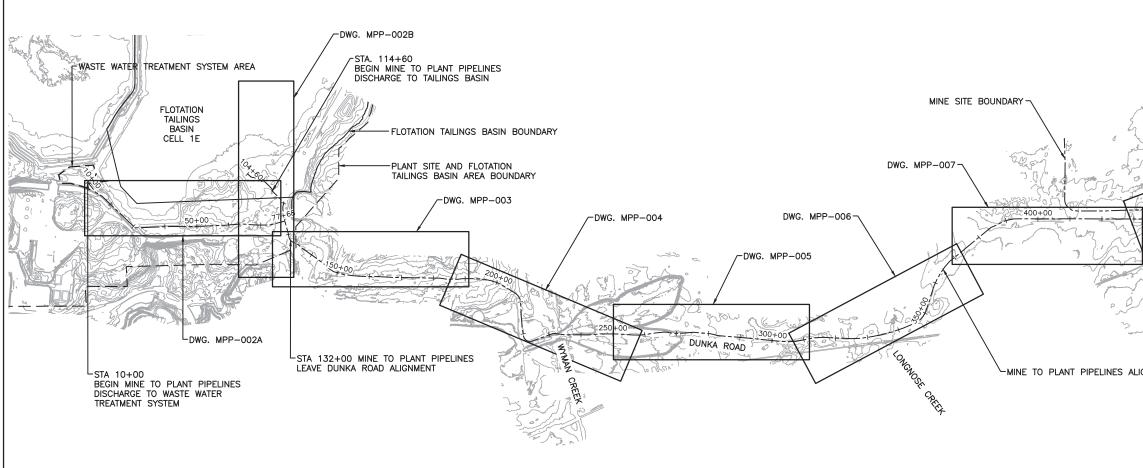
MINE WA	ATER PONDS		-							
				DESIGN		APPROXIMATE PUMP CAPACITY		ACTUAL		
ID	DESCRIPTION	OBJECTIVES	MINE YEARS	VOLUME* (GAL)			LINER TYPE	VOLUME* (GAL)	OVERFLOWS TO	SHOWN ON SHEET #
MW-S23-1	CATEGORY 2/3 STOCKPILE SUMP OVERFLOW POND	PROVIDE SUMP OVERFLOW STORAGE UP TO THE 100 YEAR 24 HOUR EVENT	1-19	6,973,000	NA	NA	MINE WATER POND LINER	7,006,000	NONE	MW-005/ MW-006
MW-S23-3	CATEGORY 2/3 STOCKPILE SUMP OVERFLOW POND	PROVIDE SUMP OVERFLOW STORAGE UP TO THE 100 YEAR 24 HOUR EVENT	6-16	1,727,000	NA	NA	MINE WATER POND LINER	1,727,000	NONE	MW-007
MW-S4	CATEGORY 4 STOCKPILE SUMP OVERFLOW POND	PROVIDE SUMP OVERFLOW STORAGE UP TO THE 100 YEAR 24 HOUR EVENT	1-11	2,639,000	NA	NA	MINE WATER POND LINER	3,226,000	NONE	MW-004
MW-SOSP	ORE SURGE PILE SUMP OVERFLOW POND	PROVIDE SUMP OVERFLOW STORAGE UP TO THE 100 YEAR 24 HOUR EVENT	1-20	1,564,000	NA	NA	MINE WATER POND LINER	1,727,000	NONE	MW-003
MW-HRC	HAUL ROAD RUNOFF POND	PROVIDE FLOOD STORAGE UP TO THE 100 YEAR 24 HOUR EVENT AND REDUCE TSS	1-20	1,988,000	40	80	MINE WATER POND LINER	2,248,000	NONE	MW-011
MW-HRE	HAUL ROAD RUNOFF POND	PROVIDE FLOOD STORAGE UP TO THE 100 YEAR 24 HOUR EVENT AND REDUCE TSS	1-20	3,487,000	70	110	MINE WATER POND LINER	3,487,000	NONE	MW-010
MW-HRW	HAUL ROAD RUNOFF POND	PROVIDE FLOOD STORAGE UP TO THE 100 YEAR 24 HOUR EVENT AND REDUCE TSS	2-20	1,206,000	30	70	MINE WATER POND LINER	1,303,000	NONE	MW-012
MW-HRN	HAUL ROAD RUNOFF POND	PROVIDE FLOOD STORAGE UP TO THE 100 YEAR 24 HOUR EVENT AND REDUCE TSS	2-20	1,434,000	30	110	MINE WATER POND LINER	1,499,000	NONE	MW-013
MW-RTH	RAIL TRANSFER HOPPER RUNOFF POND	PROVIDE FLOOD STORAGE UP TO THE 100 YEAR 24 HOUR EVENT AND REDUCE TSS	1-20	228,000	200	60	MINE WATER SUMP LINER	228,000	NONE	MW-009
MW-OSLA	OVERBURDEN STORAGE & LAYDOWN AREA RUNOFF POND	PROVIDE FLOOD STORAGE UP TO THE 25 YEAR 24 HOUR EVENT AND REDUCE TSS	1-20	3,487,000	100	90	NONE	4,725,000	NONE	MW-008
TEMP (VARIOUS)	STOCKPILE CONSTRUCTION RUNOFF PONDS AND PIT STRIPPING	TEMPORARY POND TO COLLECT RUNOFF DURING CONSTRUCTION	VARIES	VARIES	VARIES	VARIES	NONE	VARIES	NONE	NONE

VOLUME REFLECTS THE VOLUME REQUIRED BASED ON THE DESIGN NEEDS; WHEREAS ACTUAL VOLUME REFLECTS THE VOLUME SHOWN IN THE ATTACHED DRAWING SET. ACTUAL VOLUME DOES NOT INCLUDE ADDITIONAL VOLUME FROM 3 FEET OF FREEBOARD (1 FOOT FOR MW-RTH)

<u>PIPING</u>

D DESCRIPTION DOBJECTIVES WATER SOURCE SUZESS' (M) MPP MPP (TO PLANT TRANSPORT WATER FROM THE CPS TO LOSATION TAULINGS BASIN CPS 2.0 PL-1 PPELINE NUMBER 1 TRANSPORT WATER TO THE WITS TEMP - CAT 2/3 2 TO 8 PL-2 PPELINE NUMBER 2 TRANSPORT CONSTRUCTION WATER TO THE WITS CAT 2/3 2 TO 8 PL-3 PPELINE NUMBER 3 TRANSPORT MATER TO THE CAT 2/3 2 TO 8 PL-4 PPELINE NUMBER 4 TRANSPORT MATE WATER TO THE CAT 2/3 2 TO 8 PL-4 PPELINE NUMBER 4 TRANSPORT MARK WATER TO THE CAT 1 28 TO 42 PL-4 PPELINE NUMBER 5 TRANSPORT MARK WATER TO THE CAT 1 28 TO 42 PL-2 PPELINE NUMBER 6 TRANSPORT MARK WATER TO THE CAT 1 28 TO 42 PL-4 PPELINE NUMBER 6 TRANSPORT MARK WATER TO THE CAT 1 28 TO 42 PL-1 PPELINE NUMBER 6 TRANSPORT MARK WATER TO THE CAT 1 20 TO 22 PL-1 PPELINE NUMBER 6 TRANSPORT MARK WATER TO THE WATER TO															
IMP PIPELINES FLOTATION TAILINGS BASIN USS ZJ PL-1 PPELINE NUMBER TRANSPORT CONSTRUCTION WATER TO THE WYTS TEMP - CAT ; d. 4 (AST PTT 4 eVEST PTT 4 eVEST 2 TO 8 PL-2 PPELINE NUMBER 3 TRANSPORT UNE WATER TO THE WYTS TO EAP - CAT ; d. 4 (AST PTT 4 eVEST 2 TO 8 PL-3 PPELINE NUMBER 3 TRANSPORT UNE WATER TO THE WYTS CAT 2/3 & 0 OP 3 TO 8 3 PL-4 PPELINE NUMBER 4 TRANSPORT MINE WATER TO THE WYTS CAT 2/3 & 0 OP 3 TO 8 3 PL-5 PPELINE NUMBER 5 TRANSPORT MINE WATER TO THE WYTS CAT 1 2 80 TO 42 PL-6 PPELINE NUMBER 6 TRANSPORT MINE WATER TO THE WYTS CAT 1 2 80 TO 42 PL-6 PPELINE NUMBER 7 TRANSPORT MINE WATER TO THE WYTS CAT 1 2 80 TO 20 PL-6 PPELINE NUMBER 6 TRANSPORT MINE WATER TO THE WYTS MWT HR 1 To 10 Z2 PL-1 PPELINE NUMBER 7 TRANSPORT MINE WATER TO THE WYTS MW HR 2 PL-1 PPELINE NUMBER 8 TRANSPORT MINE WATER TO THE WYTS MW HR 2 PL-10 PIPELINE NUMBER 8	ID	DESCRIPTION		OBJE	ECTIVES	WATER SOURCE									
PL-1 PIPELINE NUMBER 1 IMMOSPURI TO UNITY MILE TO CAT 4, EAST PT 4, WEST PT THE WITS 2 TO 8 WEST PT 4, OSP 2, 2 2 TO 8 PL-2 PIPELINE NUMBER 2 TRANSPORT MILE WITE TO THE WITS CAT 2/3 4, OSP 3, TO 8 3 PL-3 PIPELINE NUMBER 3 TRANSPORT MILE WITE TO THE WITS CAT 4, 4 4 PL-4 PIPELINE NUMBER 4 TRANSPORT MINE WITE TO THE WITS CAT 4, 4 4 PL-5 PIPELINE NUMBER 5 TRANSPORT MINE WITE TO THE WITS CAT 1, 28 TO 42 2 PL-6 PIPELINE NUMBER 6 TRANSPORT MINE WITE TO THE WITS CAT 1, 128 TO 42 2 PL-7 PIPELINE NUMBER 7 TRANSPORT MINE WATER TO THE WITS CAT 1, 12 TO 20 12 TO 20 PL-8 PIPELINE NUMBER 8 TRANSPORT MINE WATER TO THE WITS EAST PT 4, 12 TO 20 2 10 TO 22 PL-10 PIPELINE NUMBER 9 TRANSPORT MINE WATER TO THE WITS WITS TO THE WITS TO THE WITS TO THE WITS TO THE WITS TO THE WITS TO THE WITS TO THE WITS TO T	MPP		TR/			TO CPS	2	0							
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(FTI)	LINER TY	PE OVERFLOWS TO	SHOWN ON SHEET #						NOMINAL P					
				ID	DESCRIPTION	OBJECTIV	ES	WATER SOURCE	SIZES* (I	N)				
50	NA – MANI	HOLE EAST PIT	SEE CATEGORY 1 STOCKPILE CONTAINMENT SYSTEM	MPP	MINE TO PLANT PIPELINES	TRANSPORT WATER FRO FLOTATION TAILIN		ro cps	20					
50	NA – MANI	HOLE WEST PIT	DRAWING SET	PL-1	PIPELINE NUMBER 1	TRANSPORT CONSTRUC THE WW		O TEMP - CAT 1, CAT 4, EAST PIT & WEST PIT	2 TO 8					
				PL-2	PIPELINE NUMBER 2	TRANSPORT CONSTRUC THE WW		0 TEMP - CAT 2/3 + OSP	2 TO 8					
				PL-3	PIPELINE NUMBER 3	TRANSPORT MINE W WWTS		CAT 2/3 & OSP	3 TO 8					
				PL-4	PIPELINE NUMBER 4	TRANSPORT MINE W WWTS		CAT 4	4					
				PL-5	PIPELINE NUMBER 5	TRANSPORT MINE W WWTS		CAT 1	28 TO 4	2				
				PL-6	PIPELINE NUMBER 6	TRANSPORT MINE WATE	ER TO THE CP	PS OSLA	3					
				PL-7	PIPELINE NUMBER 7	TRANSPORT MINE W WWTS		RTH, MW-HRE & MW-HRC	2 TO 6					
				PL-8	PIPELINE NUMBER 8	TRANSPORT MINE W WWTS		EAST PIT & CENTRAL PIT	12 TO 2	0				
				PL-9	PIPELINE NUMBER 9	TRANSPORT MINE W WWTS		WEST PIT	10 TO 2	2				
				PL-10	PIPELINE NUMBER 10	TRANSPORT MINE W WWTS		MW-HRN	2					
				PL-11	PIPELINE NUMBER 11	TRANSPORT MINE W WWTS		MW-HRW	2		PLANT DRAWING NUMBER:			
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VER NO	DATE		DESCRIPTION			ISSUE STATUS						POLY MET I	MINING. INC.	
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							sic	RINTED NAME JON M. MIN	2 0/	ARR PROJECT NO.: 23/69-0C29	B /			
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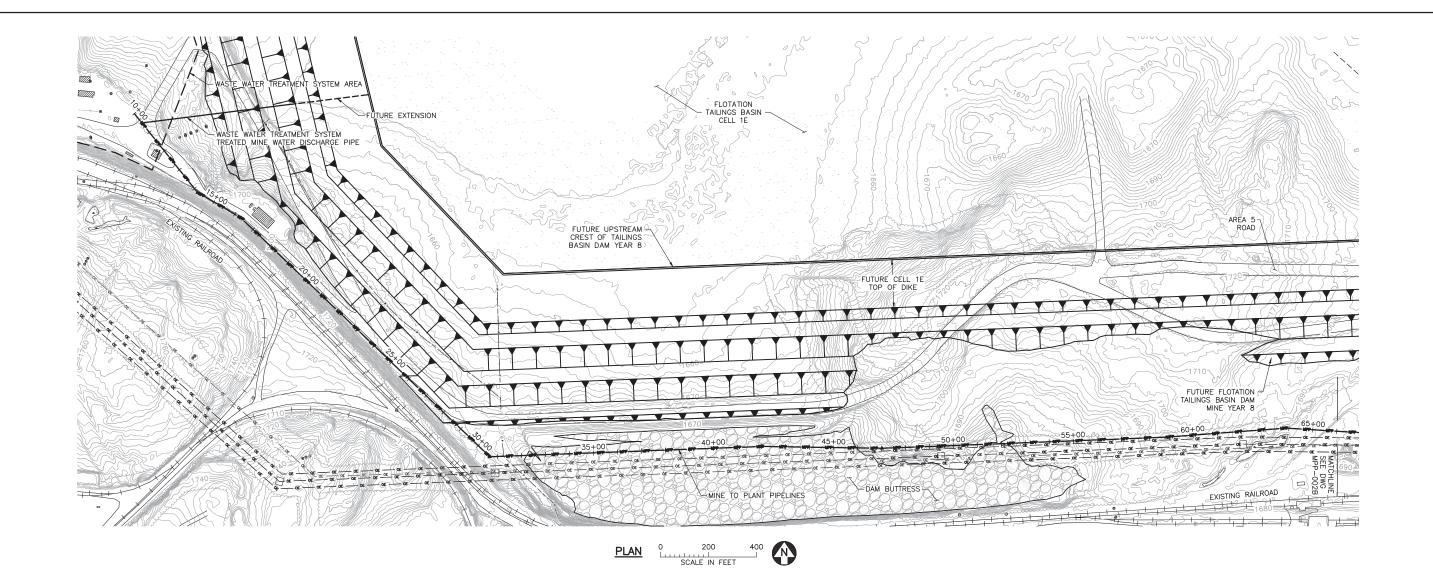
1 PLAN: SHEET INDEX



VER NO	DATE	DESCRIPTION		ISSUE STATUS			
1	5/18/15	ISSUED FOR INCLUSION IN PERMIT APPLICATIONS	ISSUED	VERSION	DATE	I HEREBY CERTIFY THAT THIS PLAN,	
2	6/07/17	PERMIT APPLICATION UPDATES				SPECIFICATION, OR REPORT WAS PREPARED BY ME OR UNDER MY DIR	
			FOR PERMITTING	2	6/07/17	SUPERVISION AND THAT I AM A DULY LICENSED PROFESSIONAL ENGINEER	
						UNDER THE LAWS OF THE STATE OF MINNESOTA.	
			FOR CONSTRUCTION			PRINTED NAME JON M. MINNE	
						SIGNATURE	
			NOT APPROVED FOR CONSTRUCTION			DATE 07 07 77 LICENSE# 23080	

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	EQUALIZATION BASIN AREA	U
IND MINE TO PLANT P	WG. MPP-009	
	PLANT DRAWING NUMBER: MINE TO PLANT PIPELINES	
	GENERAL LAYOUT AND SHEET INDE	EX
AN, pirect DULY OF OF CHECKED:	POLYMET MINING, INC NORTHMET PROJECT HOYT LAKES, MINNESOT	- A
E BARR PROJECT NO.: 23/69-0C29	BARRR HINNEAPOLIS, MN. Ph: 1-800-632-2277	
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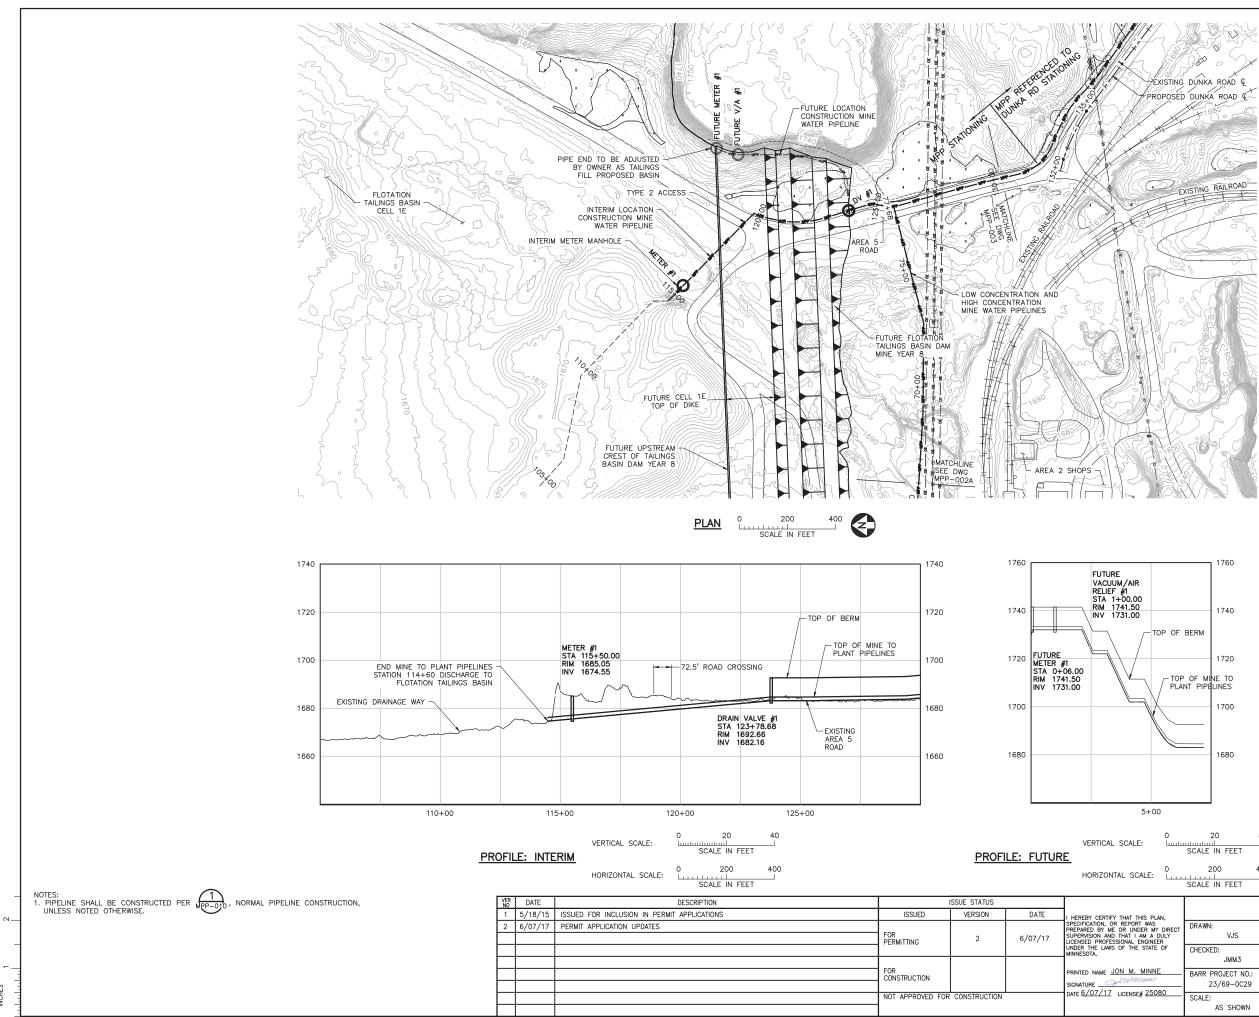
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NOTES: 1. PIPELINE SHALL BE CONSTRUCTED PER (1), NORMAL PIPELINE CONSTRUCTION, UNLESS NOTED OTHERWISE.

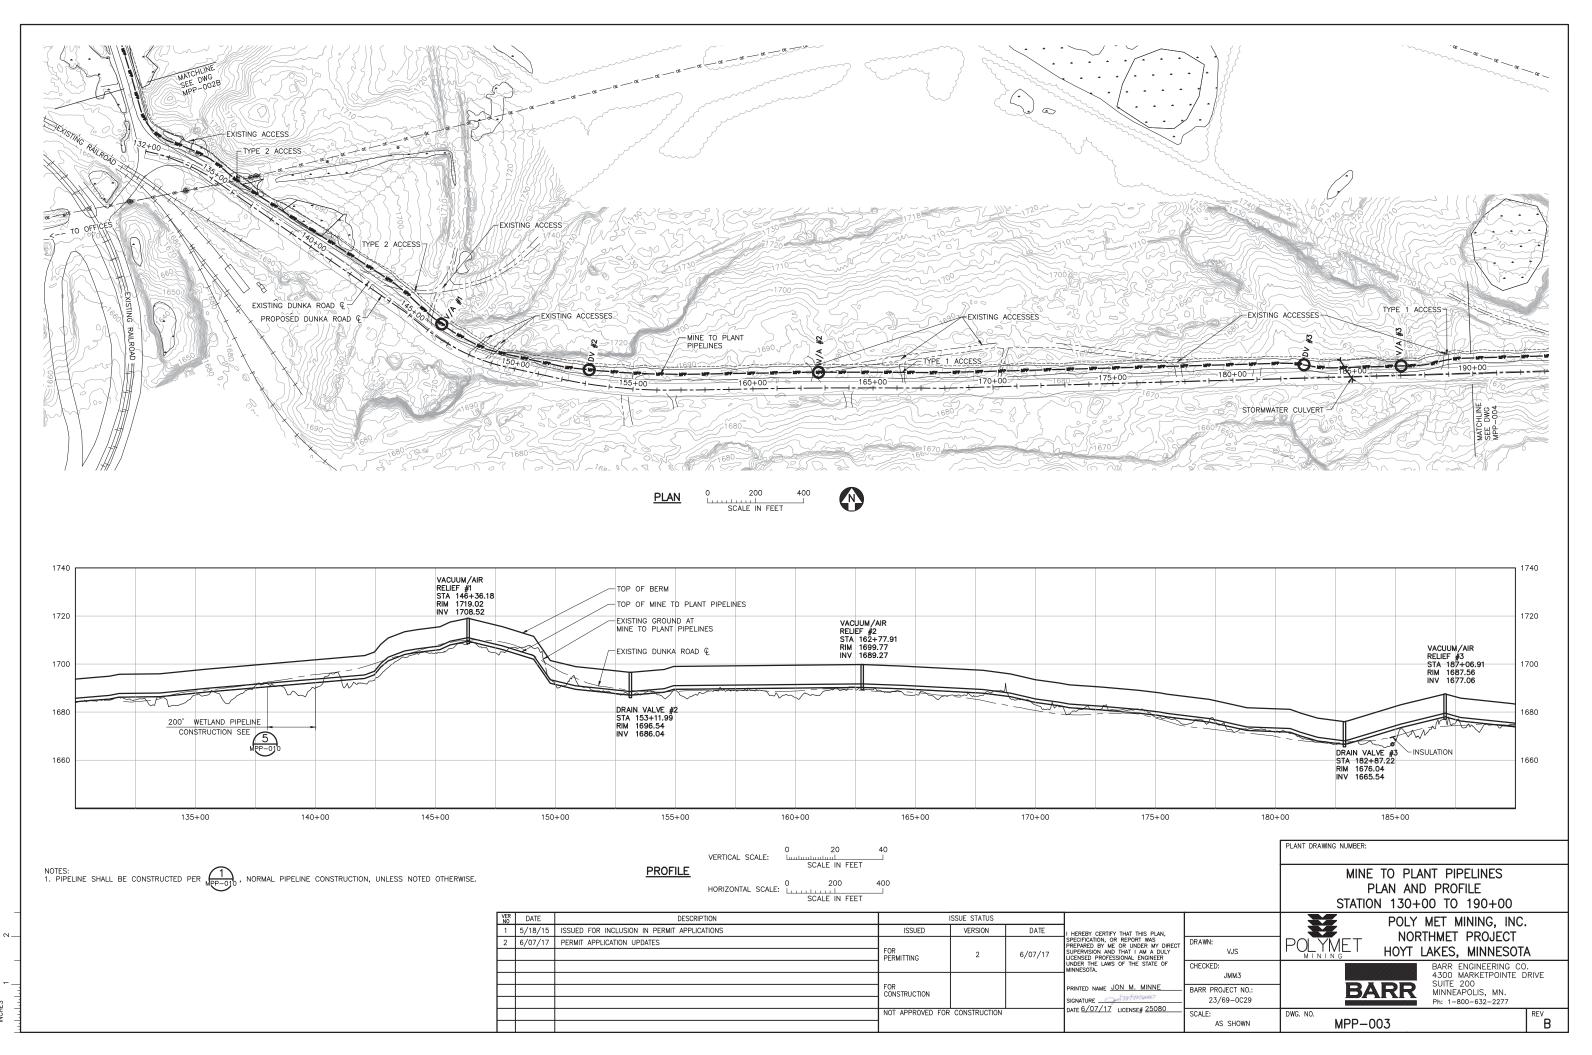
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			NOT APPROVED FOR	CONSTRUCTION		DATE 07 07 777 LICENSE# 20080	

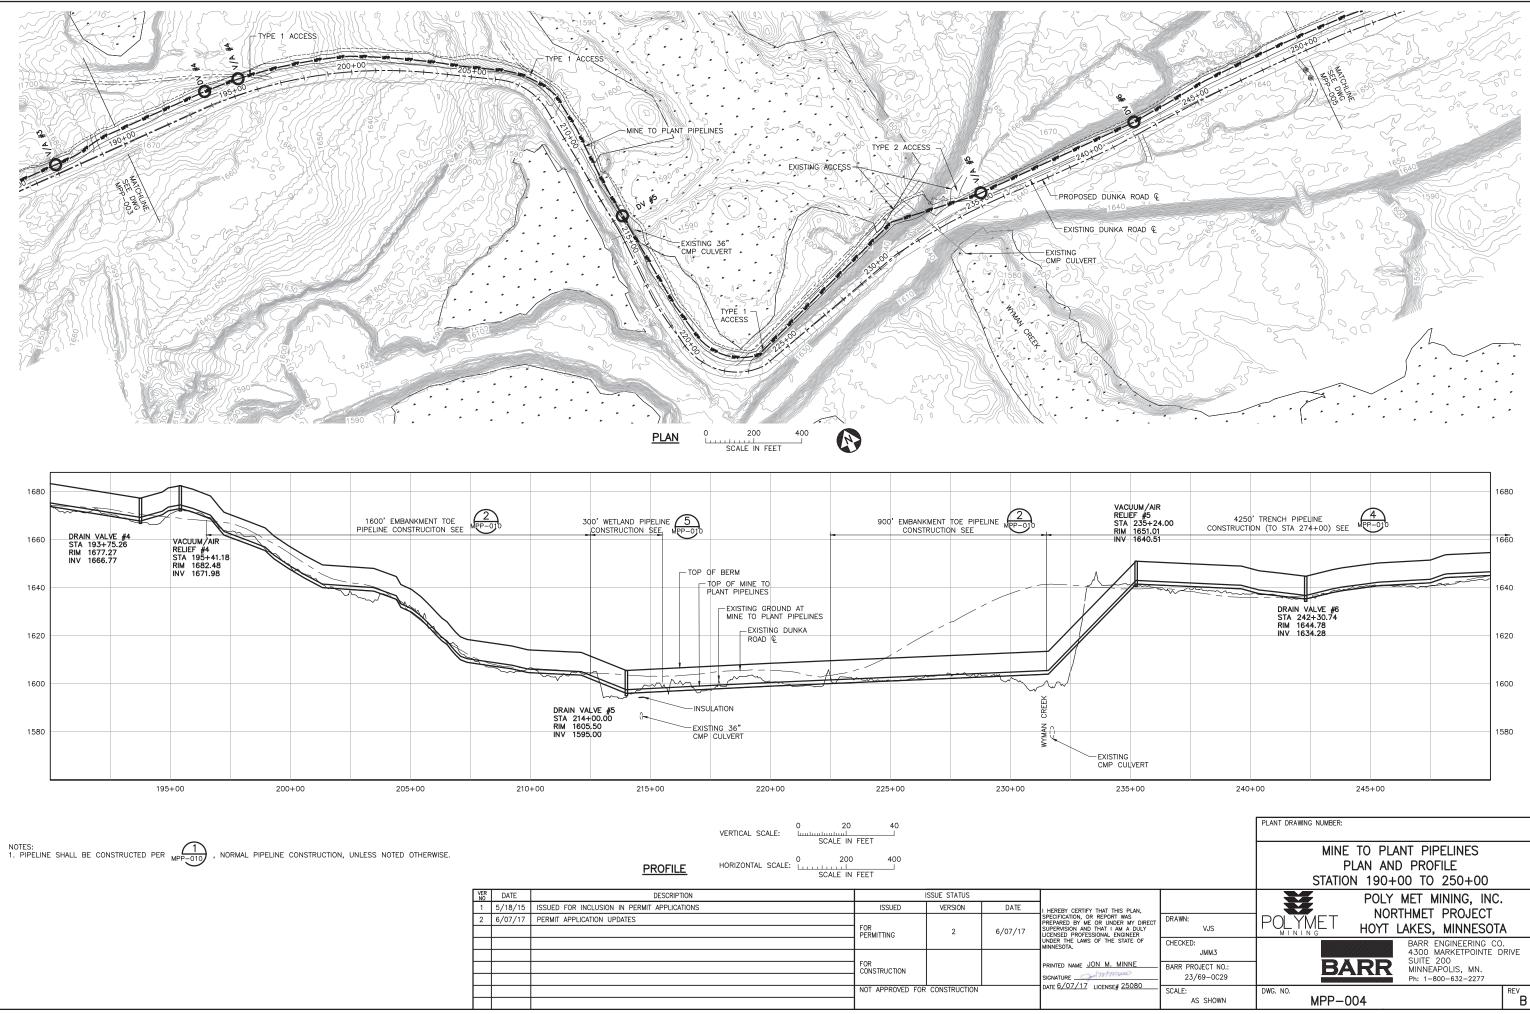
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	VJS CHECKED: JMM3	HOYT LAKES, MINNESOTA BARR ENGINEERING CO 4300 MARKETPOINTE D	
	BARR PROJECT NO.: 23/69-0C29	BARR SUITE 200 MINNEAPOLIS, MN. Ph: 1-800-632-2277	
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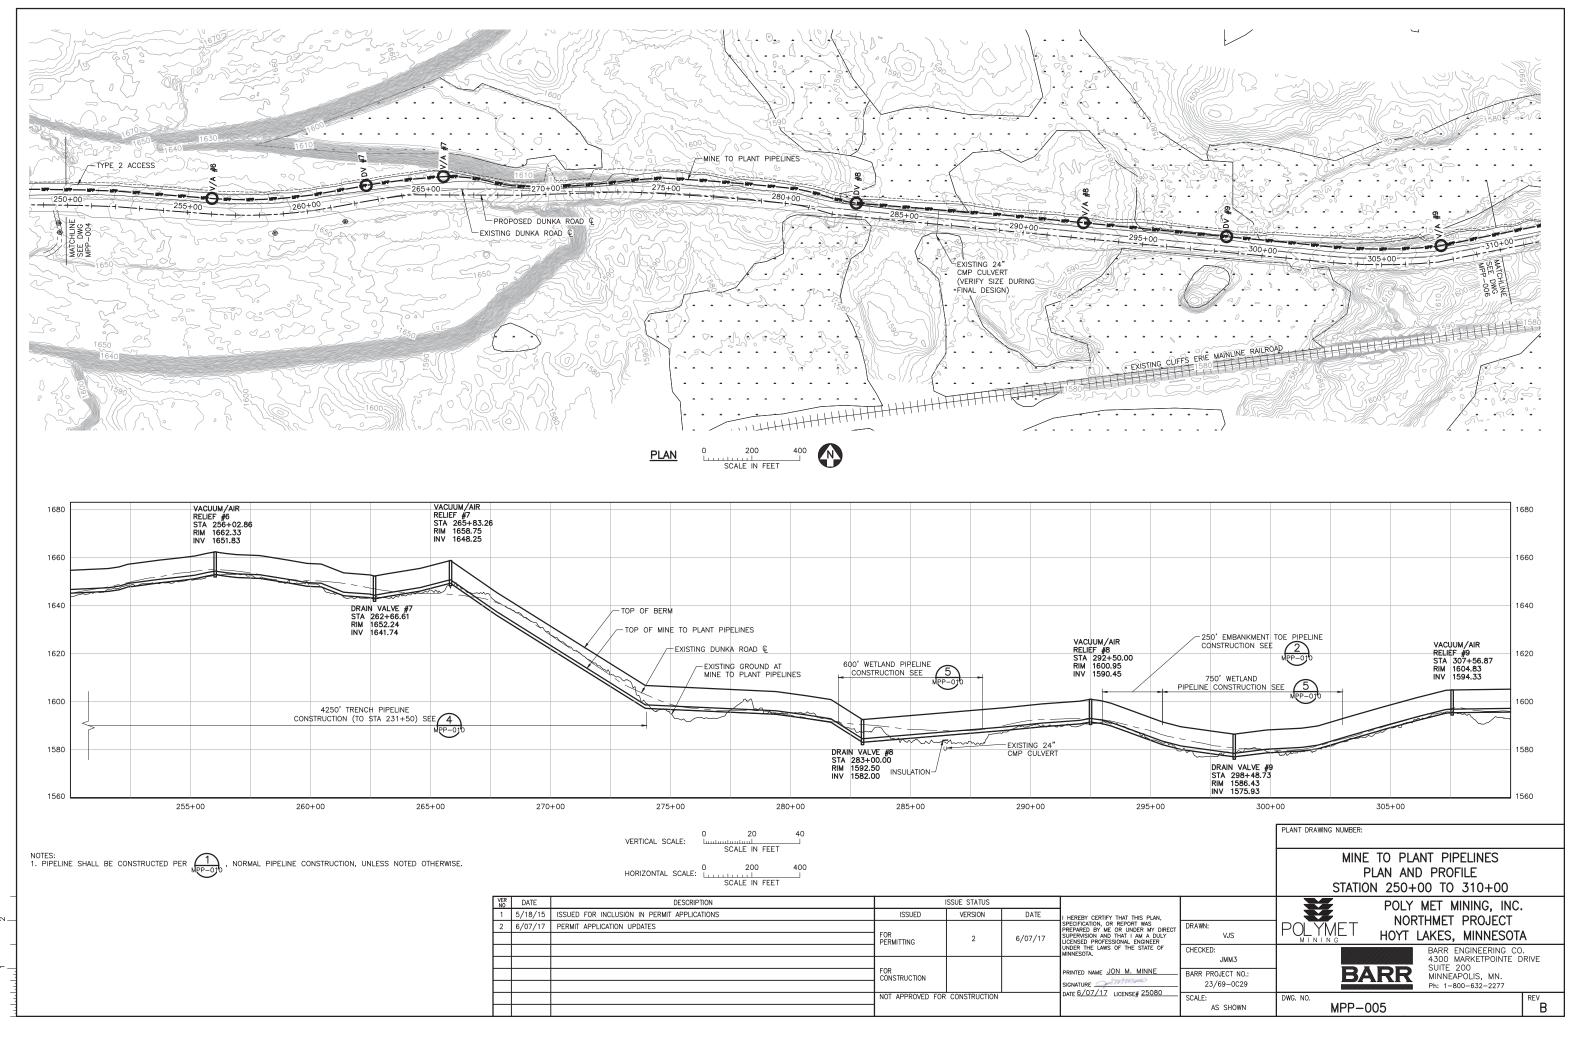


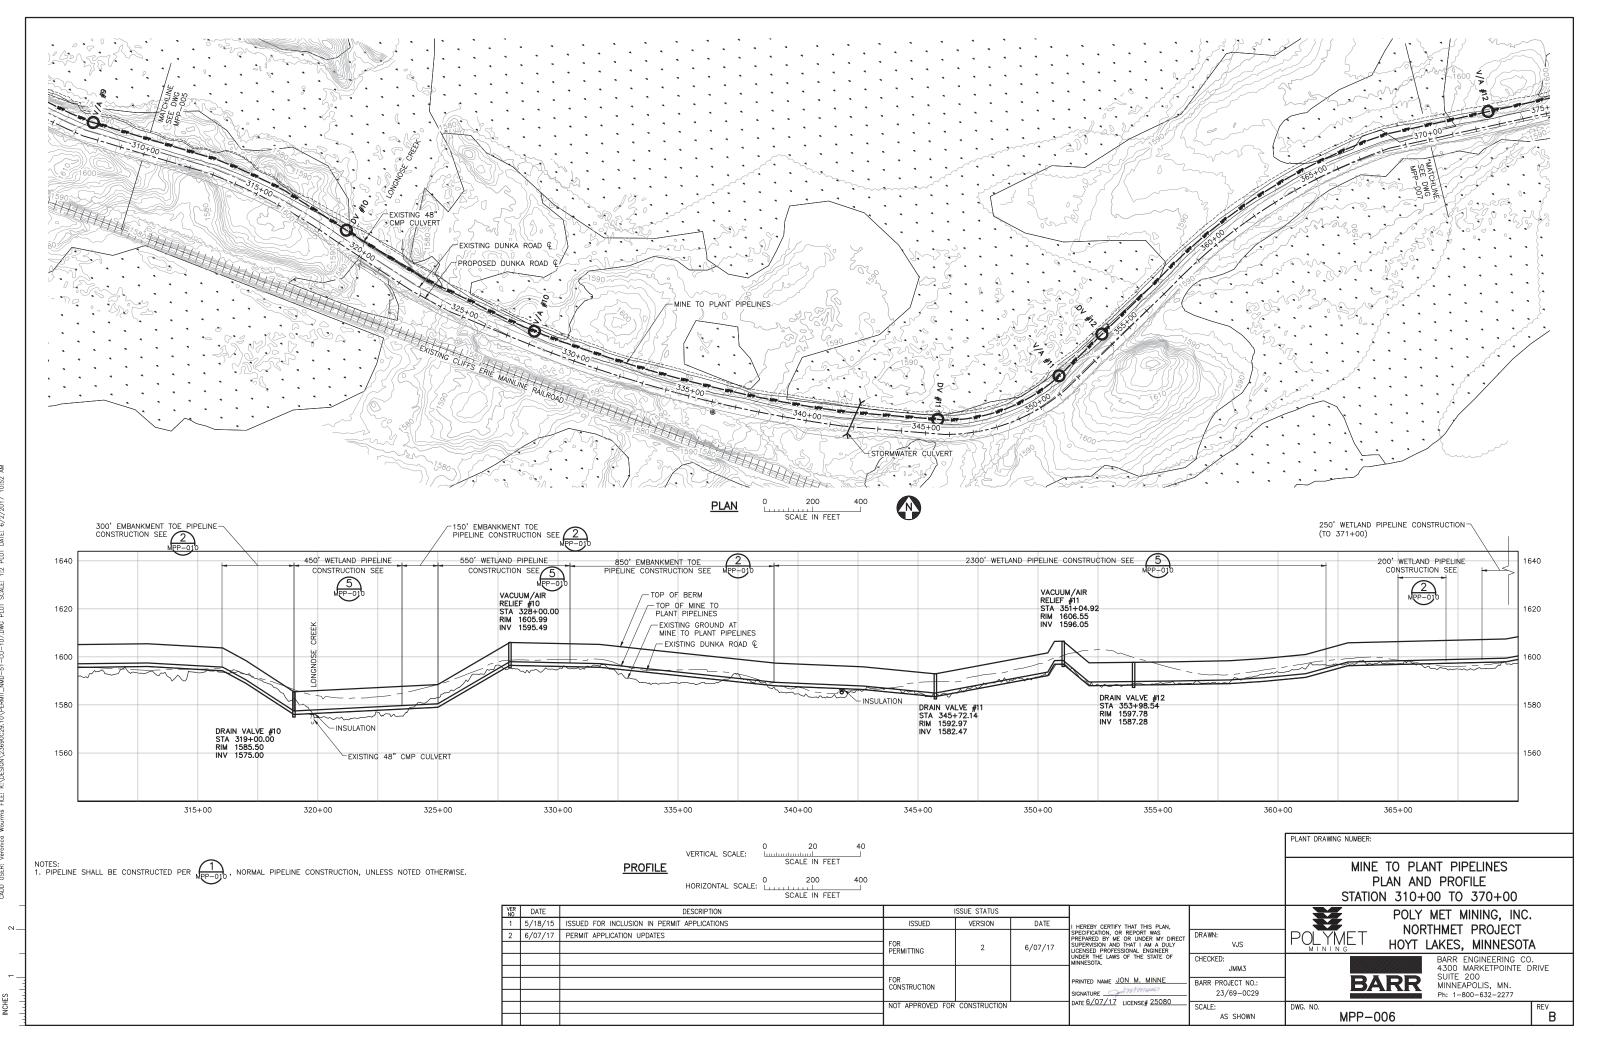
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	200 400 SCALE IN FEET	PLAN AND PROFILE				
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E OF	CHECKED: JMM3	BARR ENGINEERING CO 4300 MARKETPOINTE D				
NE 080	BARR PROJECT NO.: 23/69-0C29	BARR SUITE 200 MINNEAPOLIS, MN. Ph: 1-800-632-2277				
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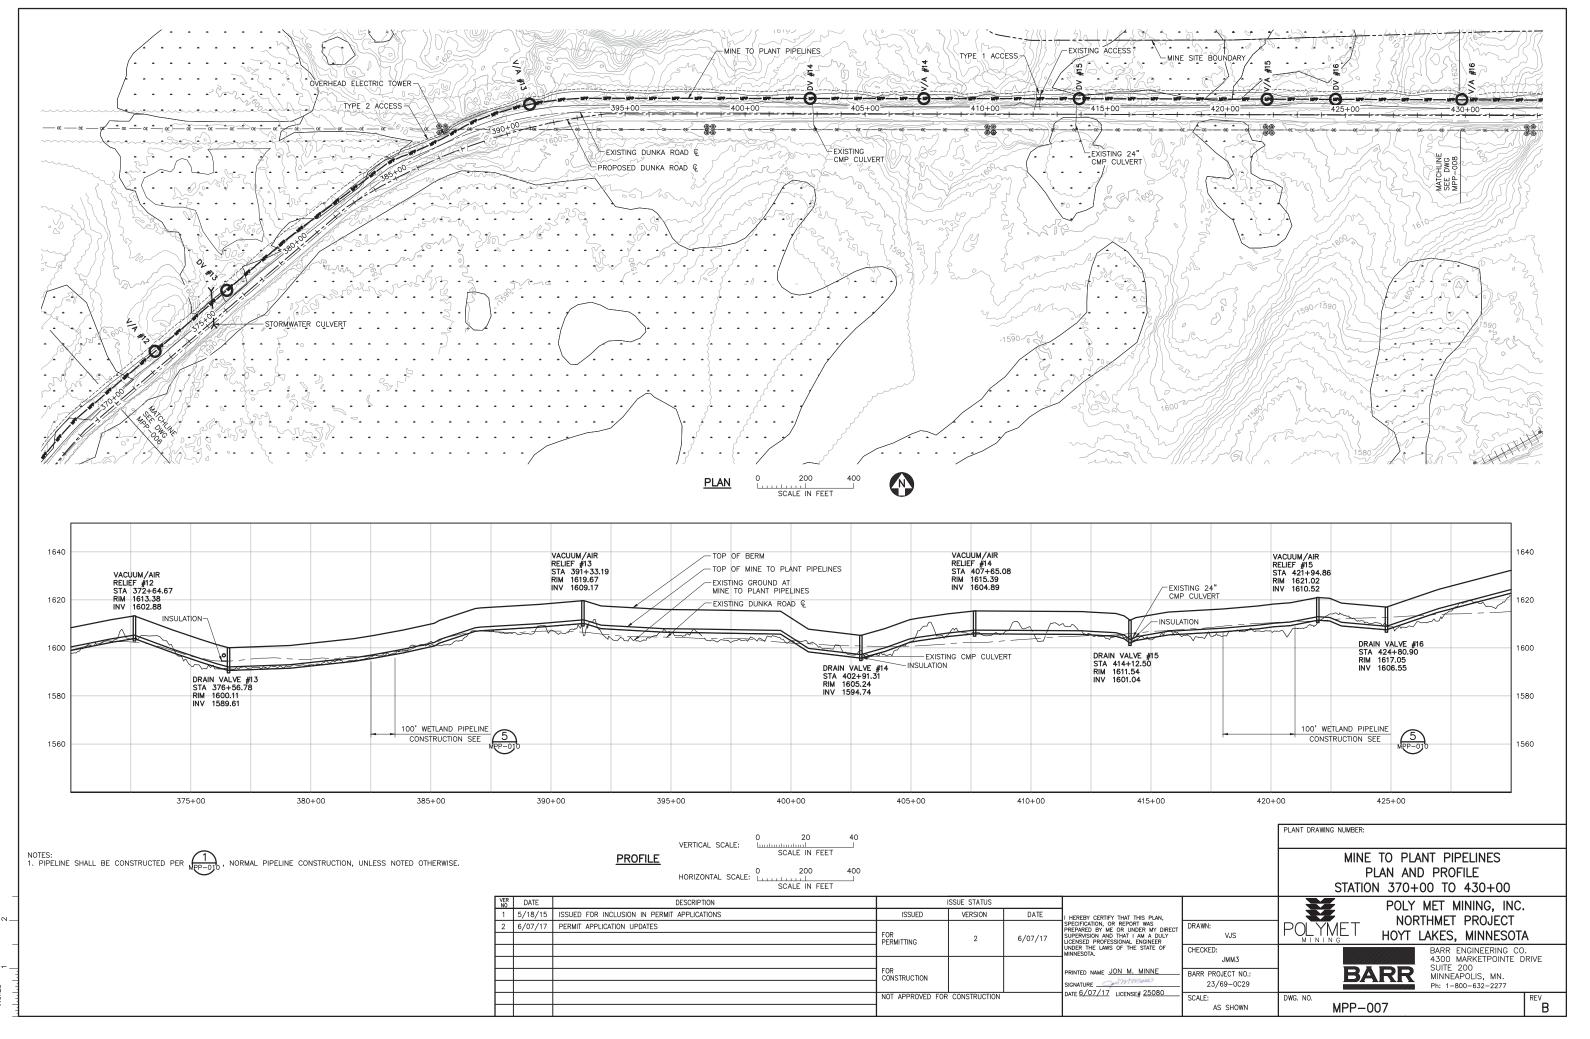




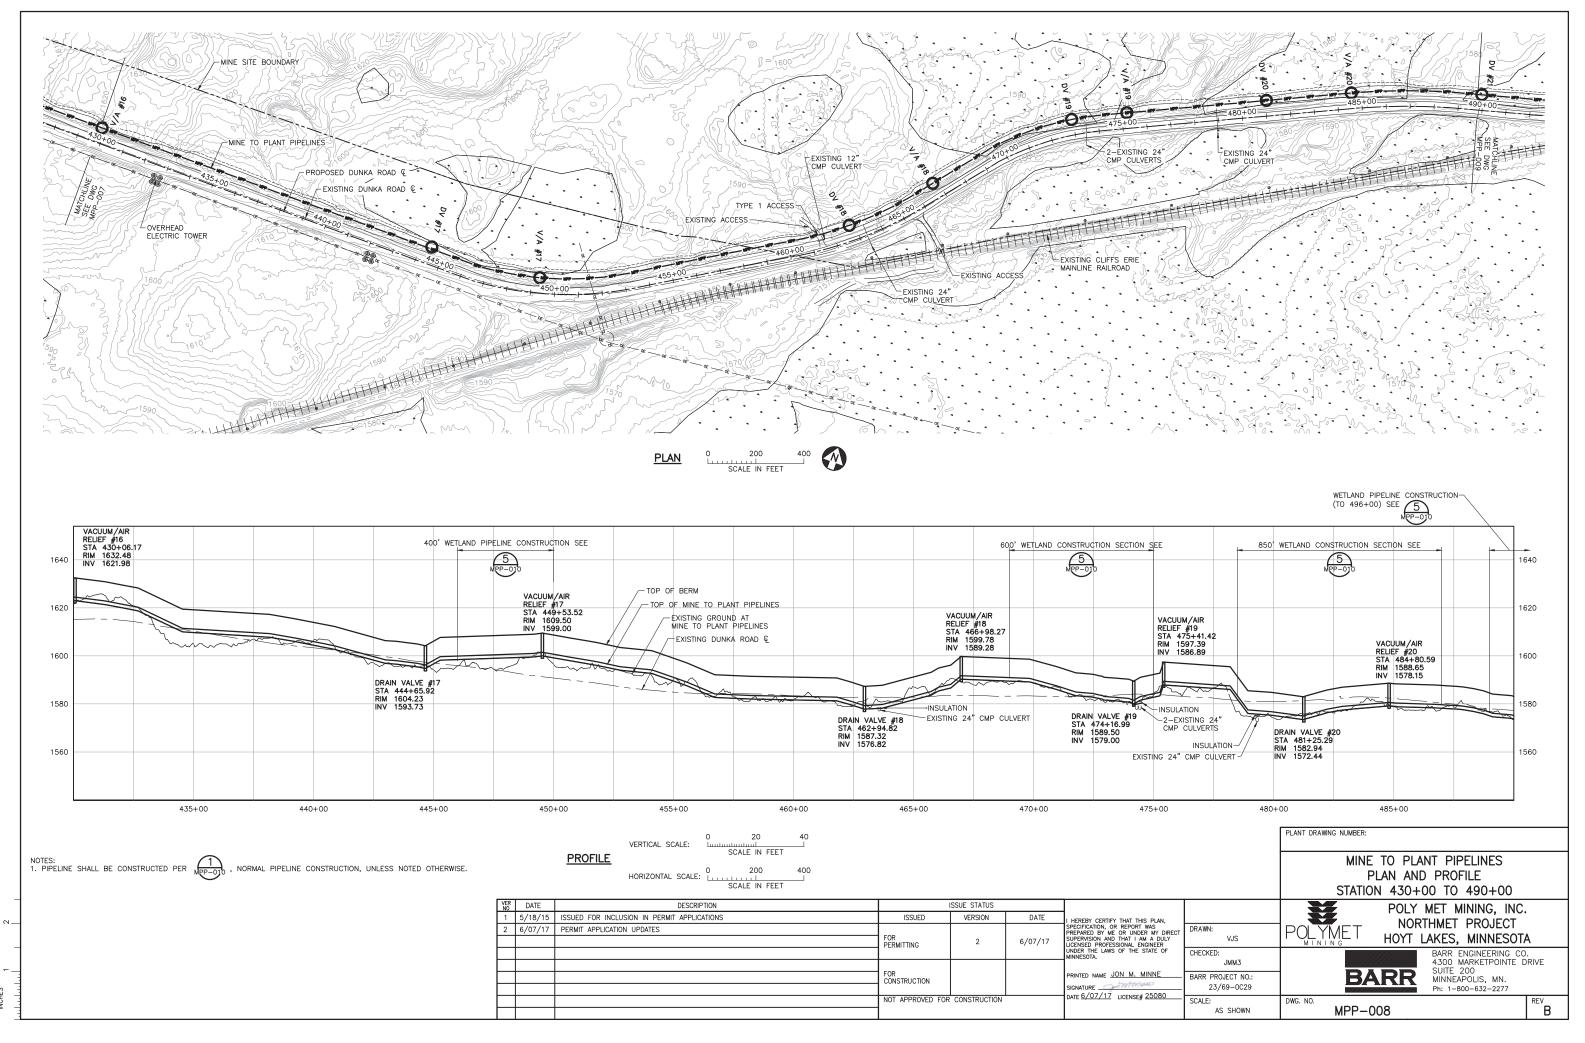
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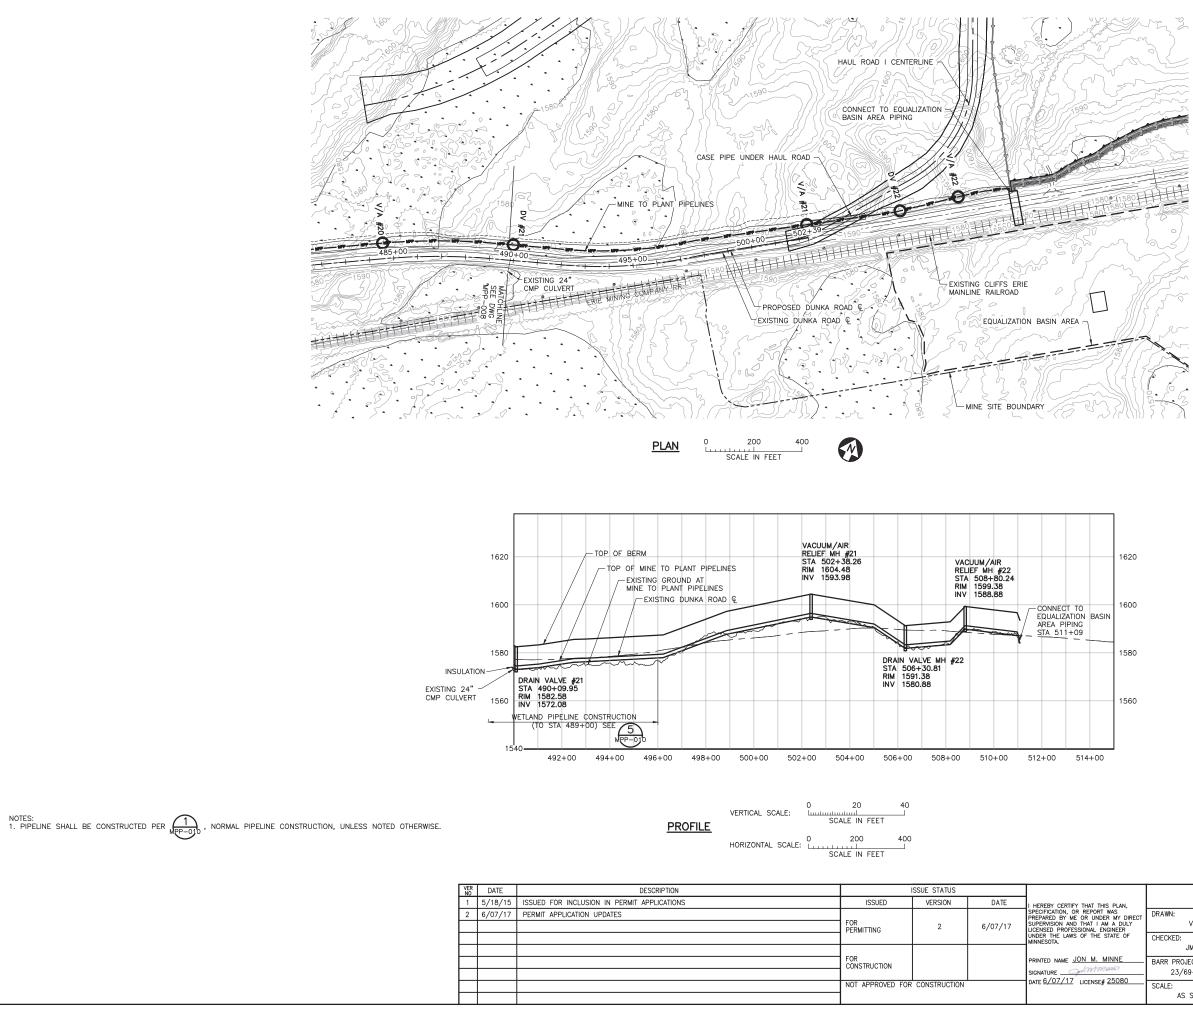






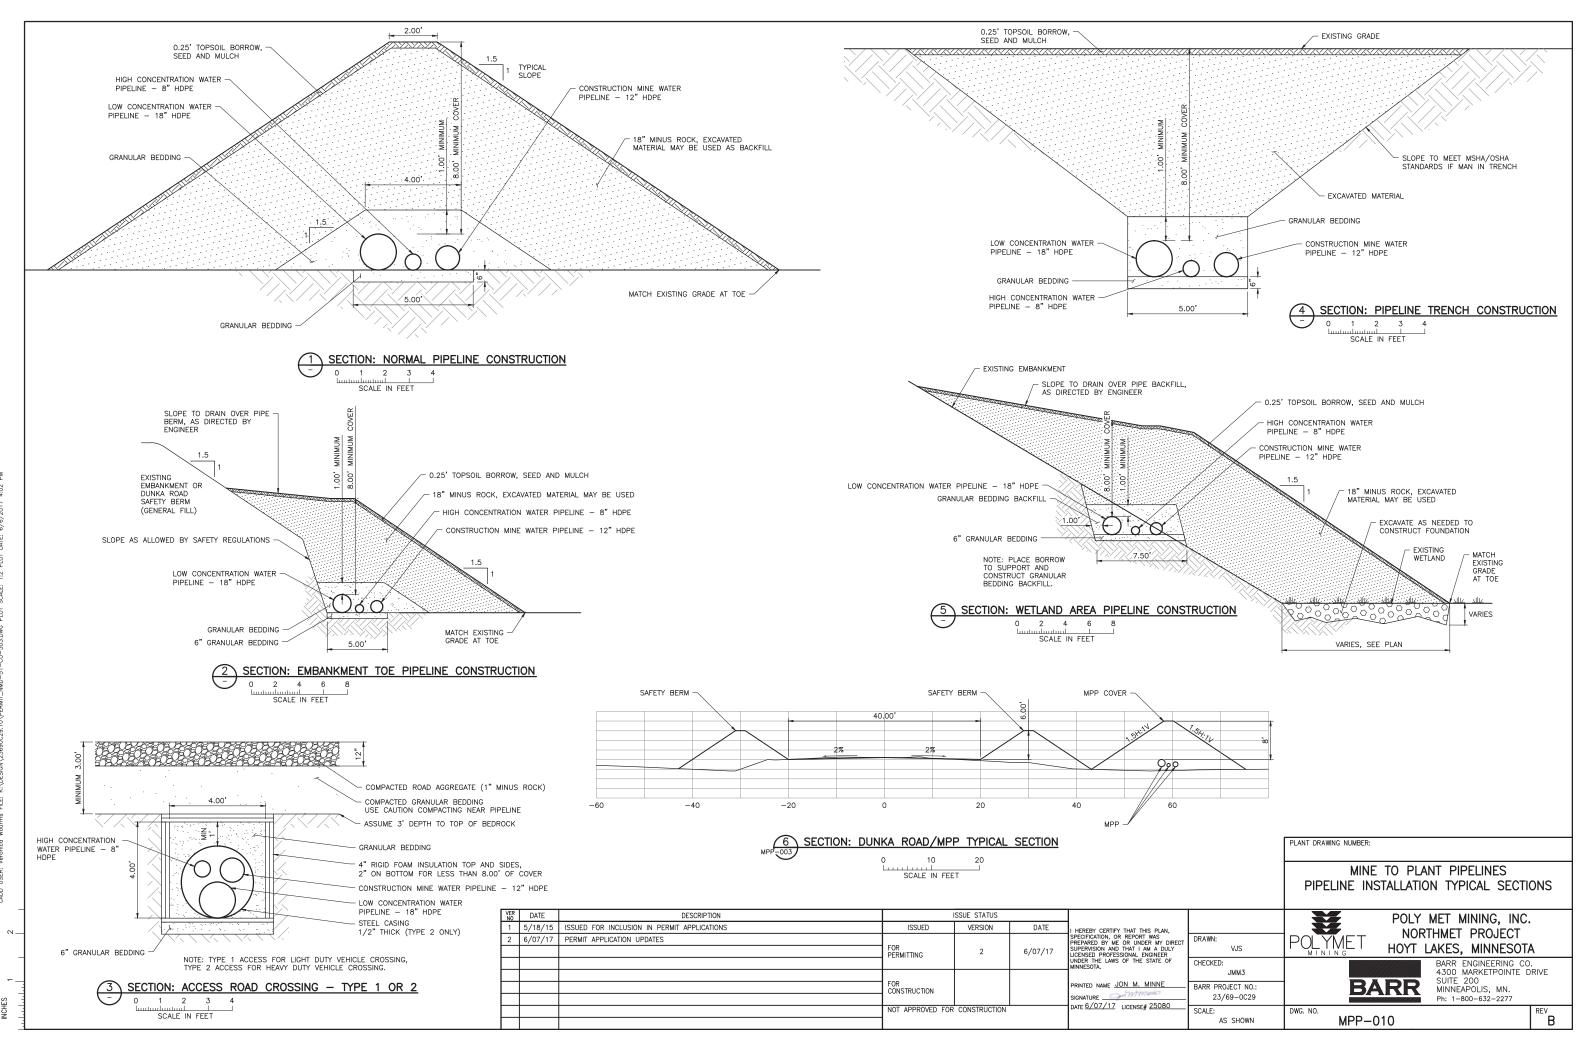
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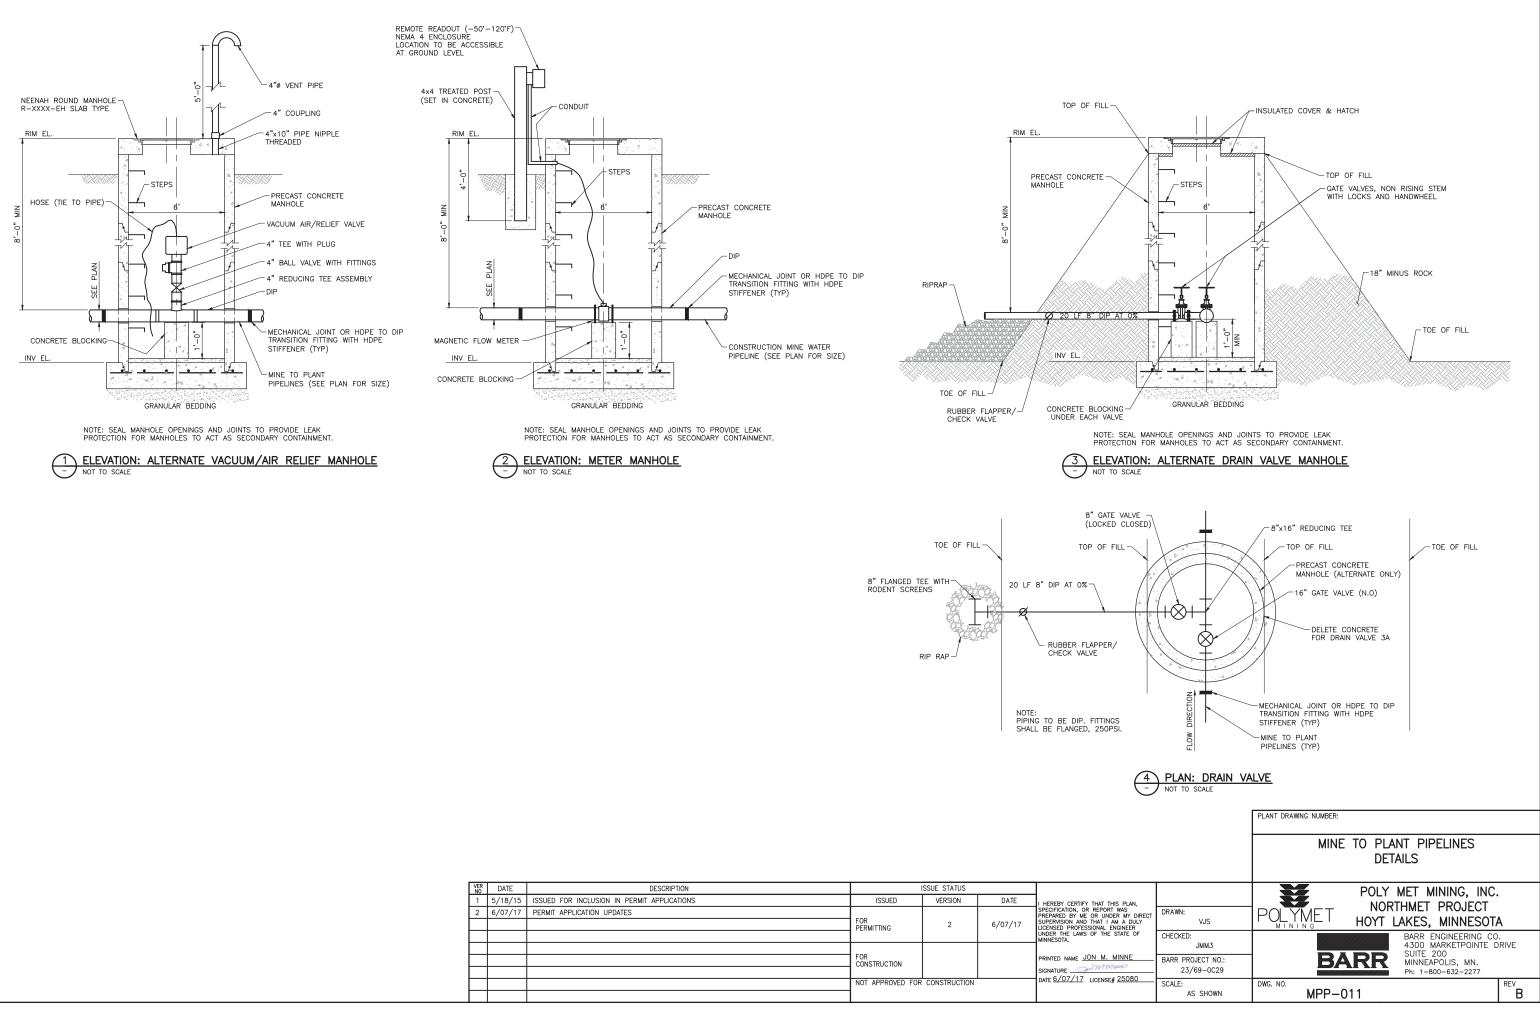




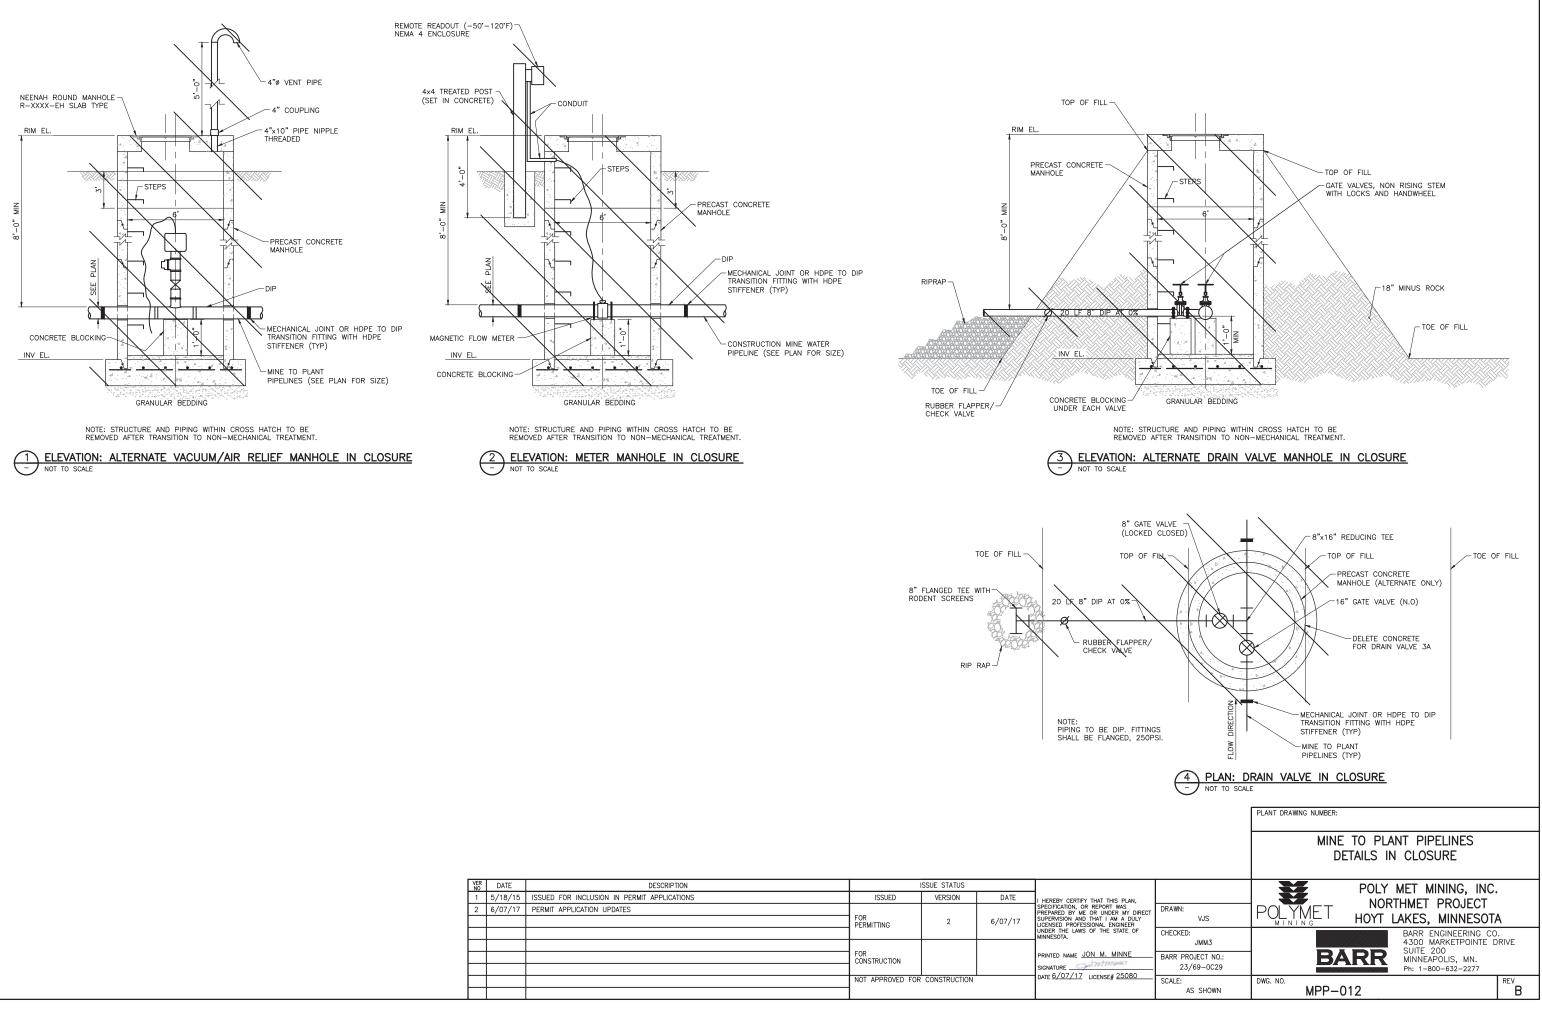
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	CHECKED: JMM3 BARR PROJECT NO.: 23/69-0C29	BARR ENGINEERING CO. 4300 MARKETPOINTE DRIVE SUITE 200 MINNEAPOLIS, MN. Ph: 1-800-632-2277	
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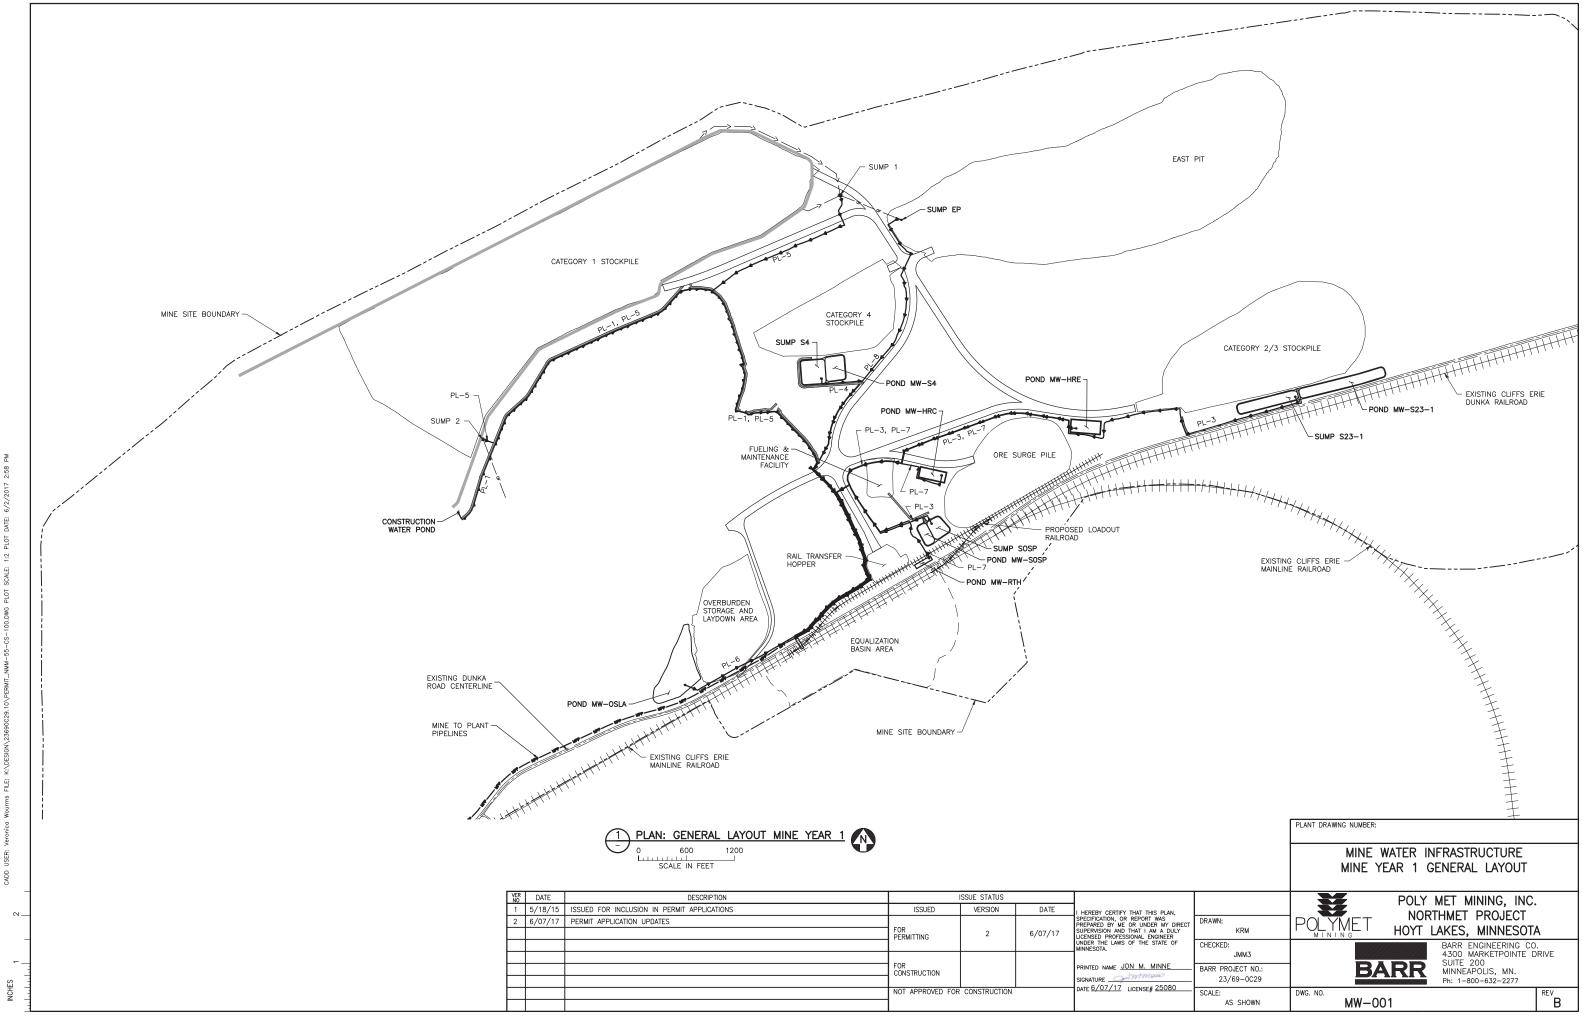


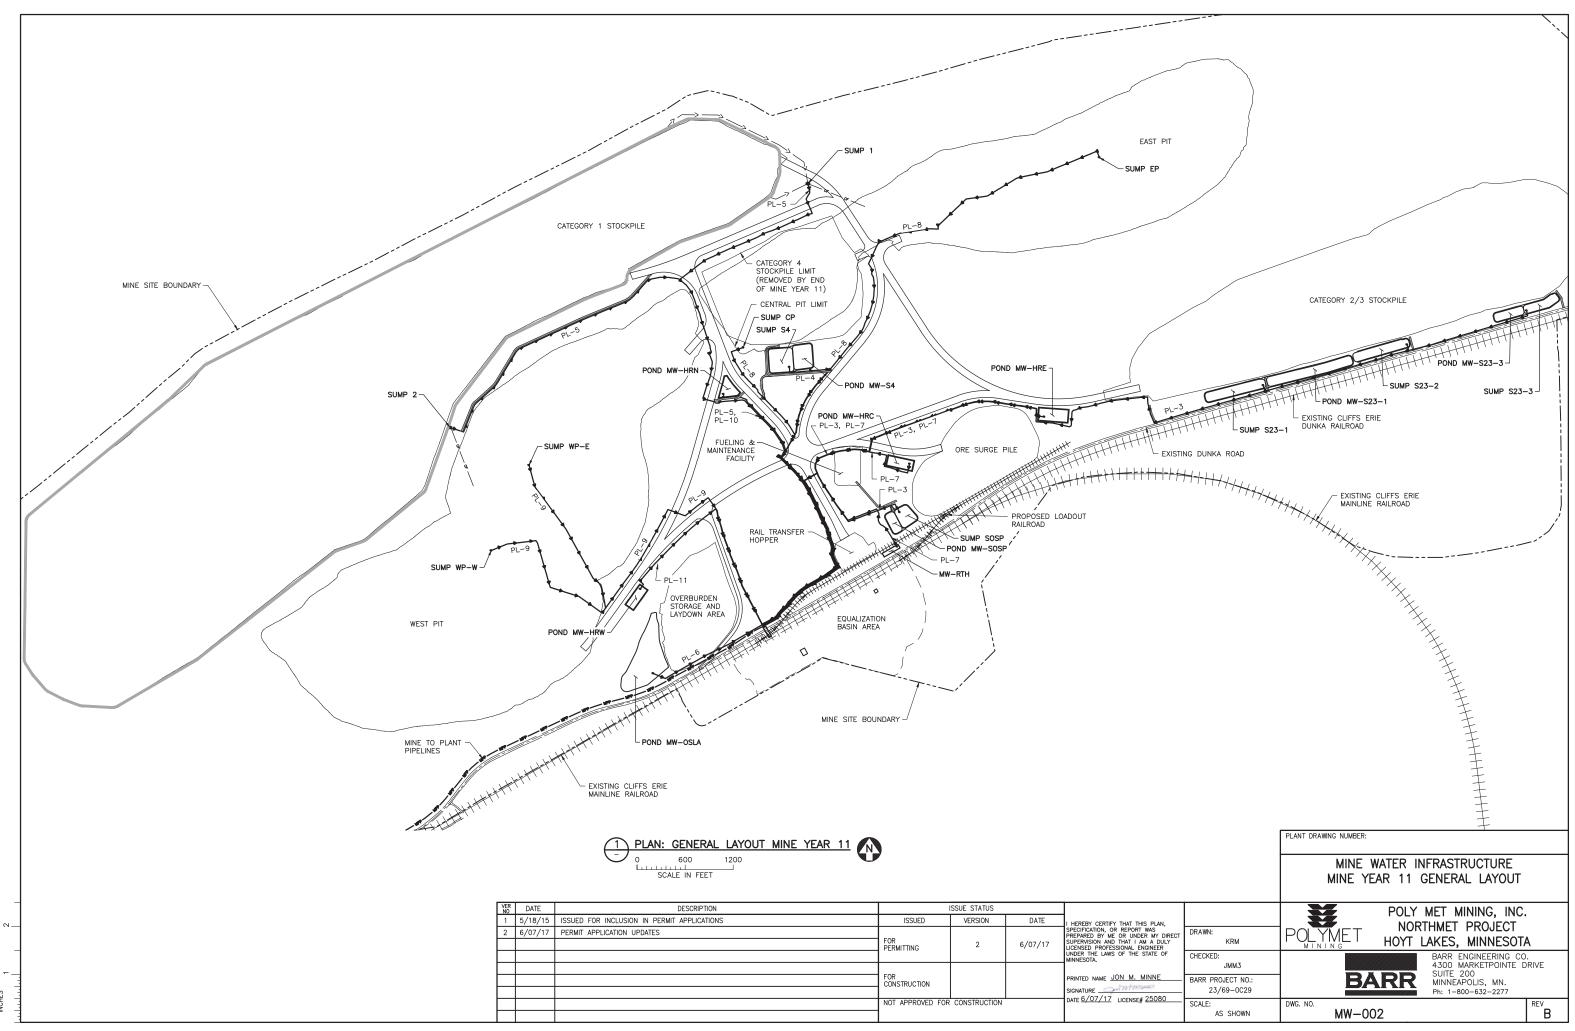


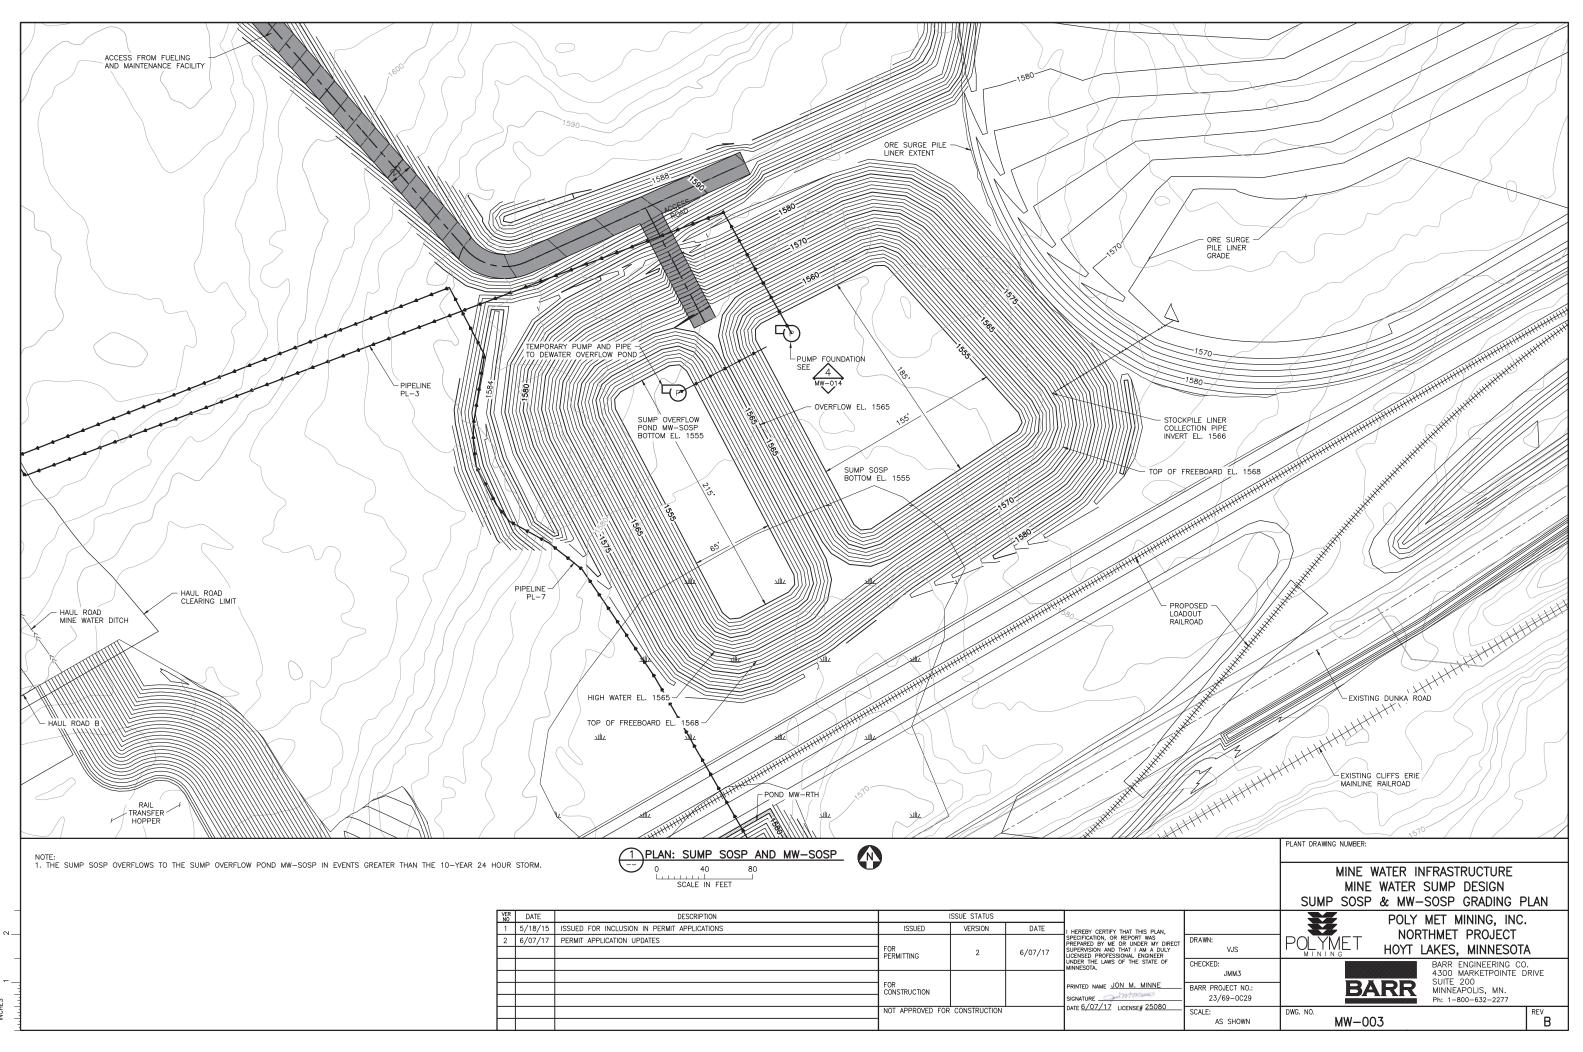
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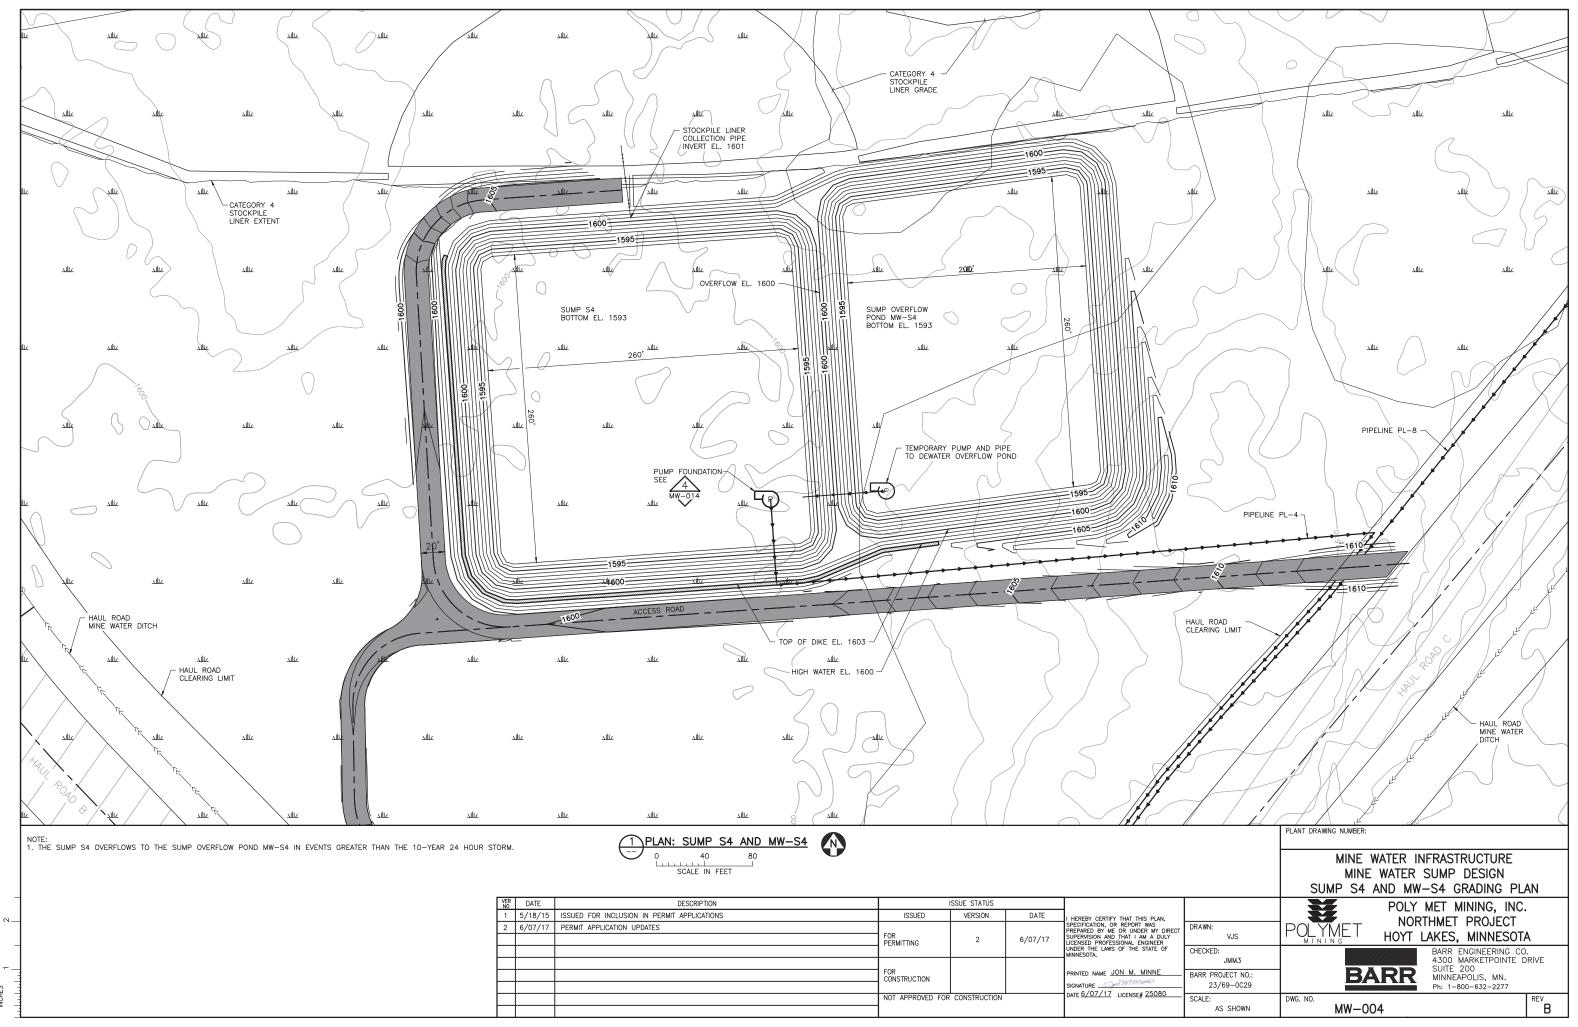
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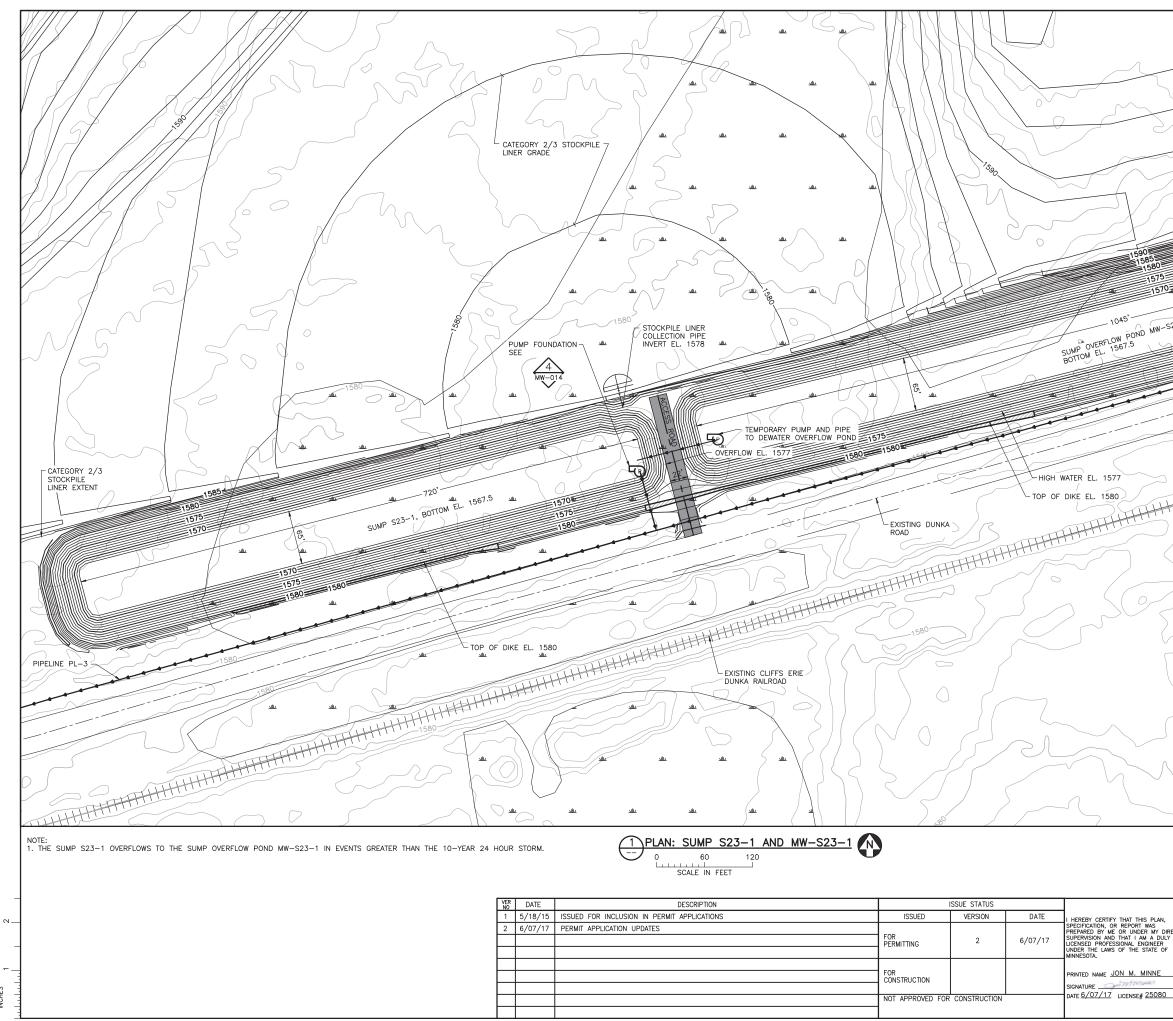
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				FOR			PRINTED NAME JON M. MINNE
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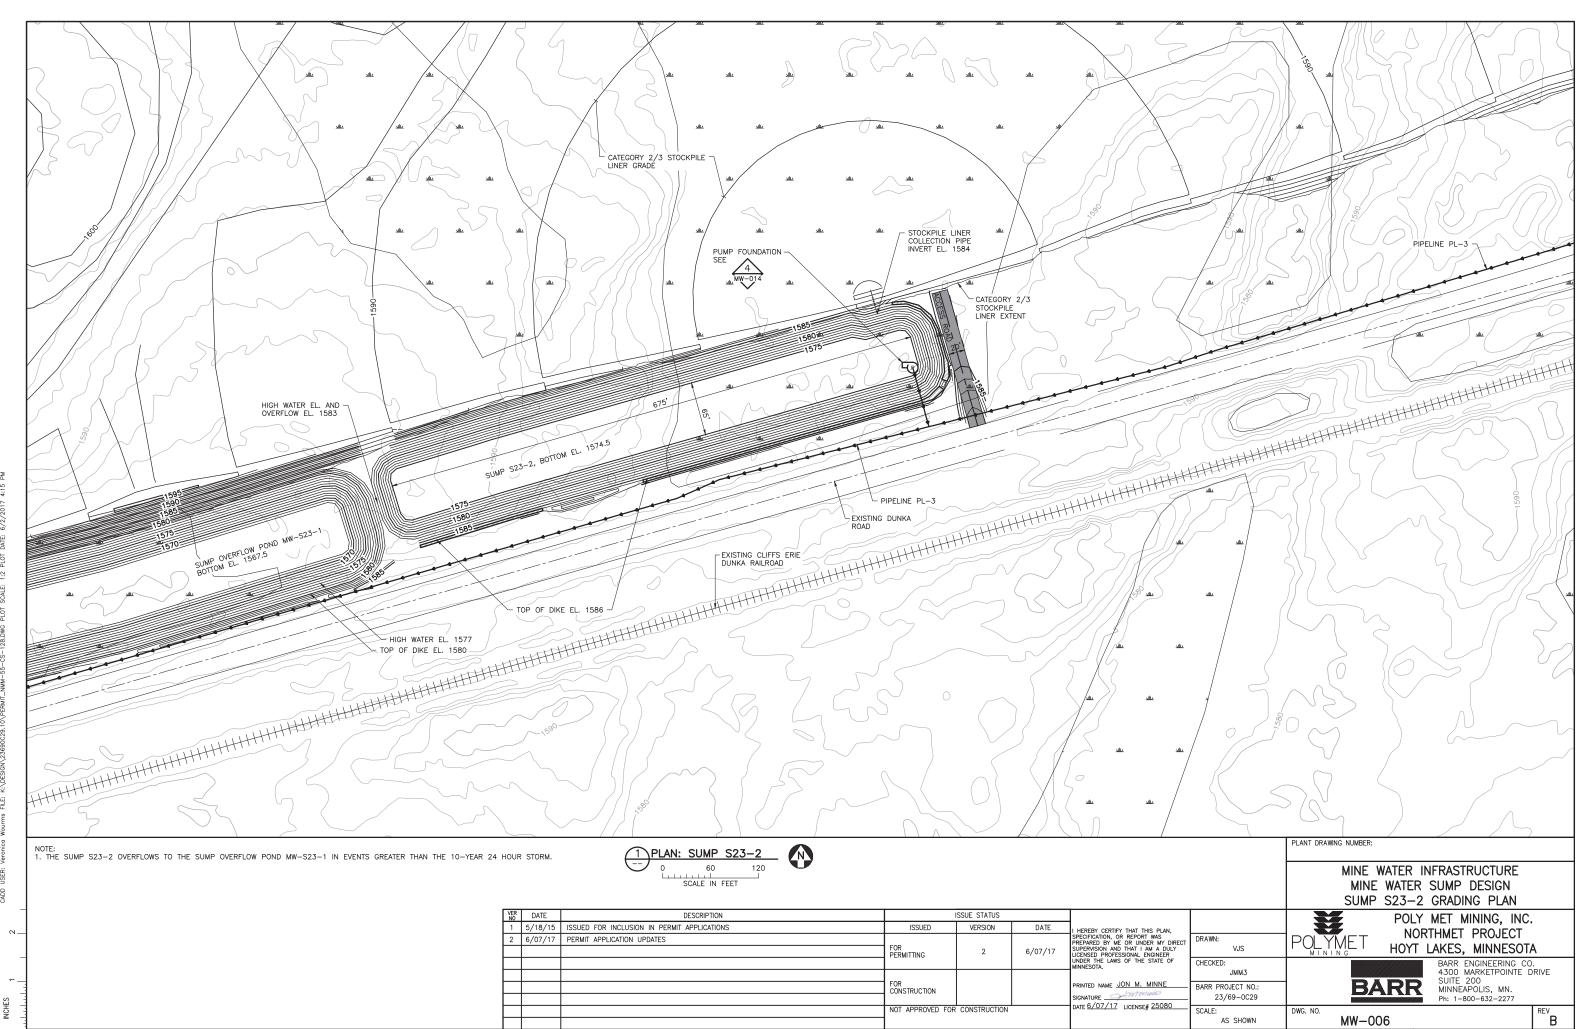


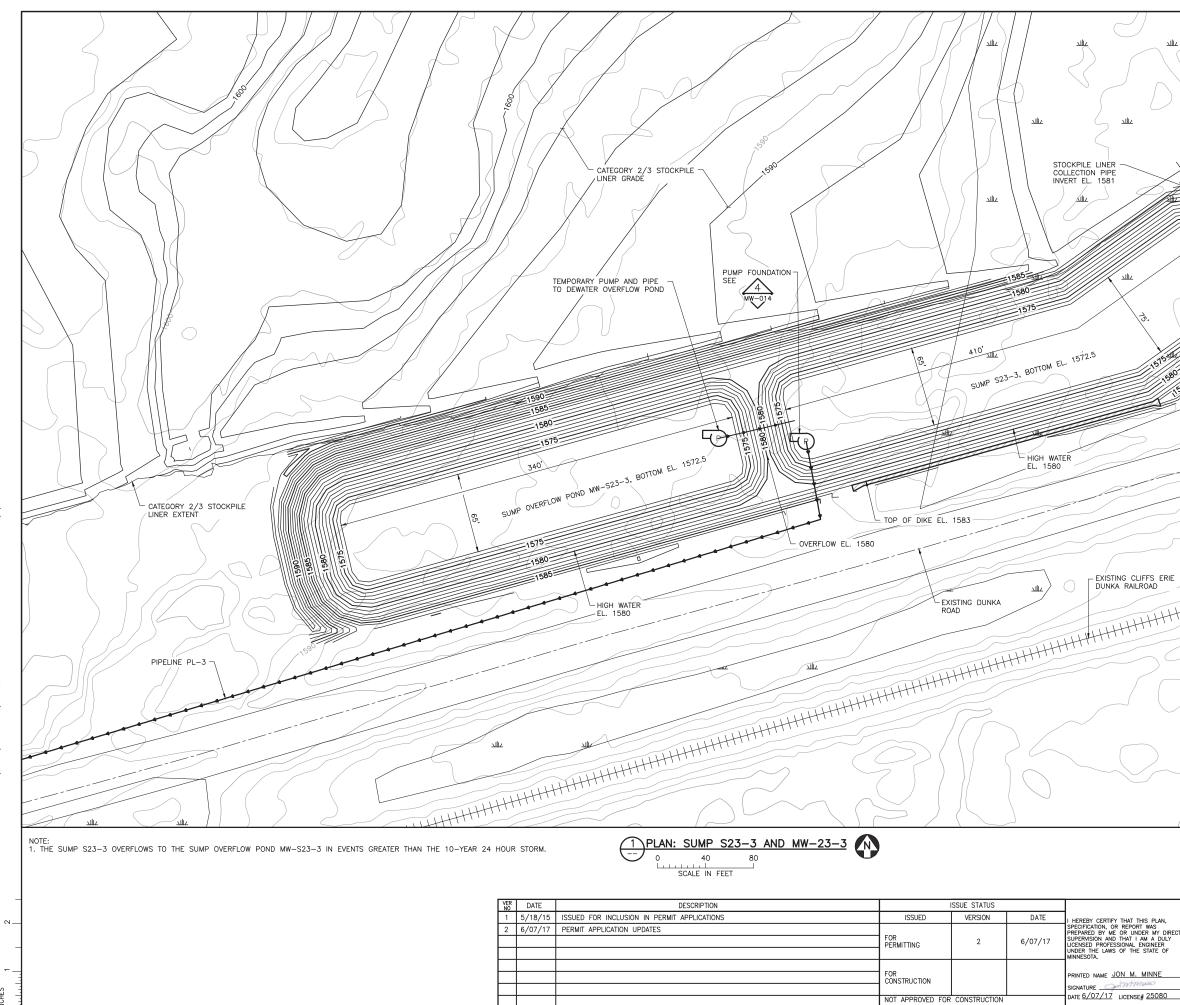
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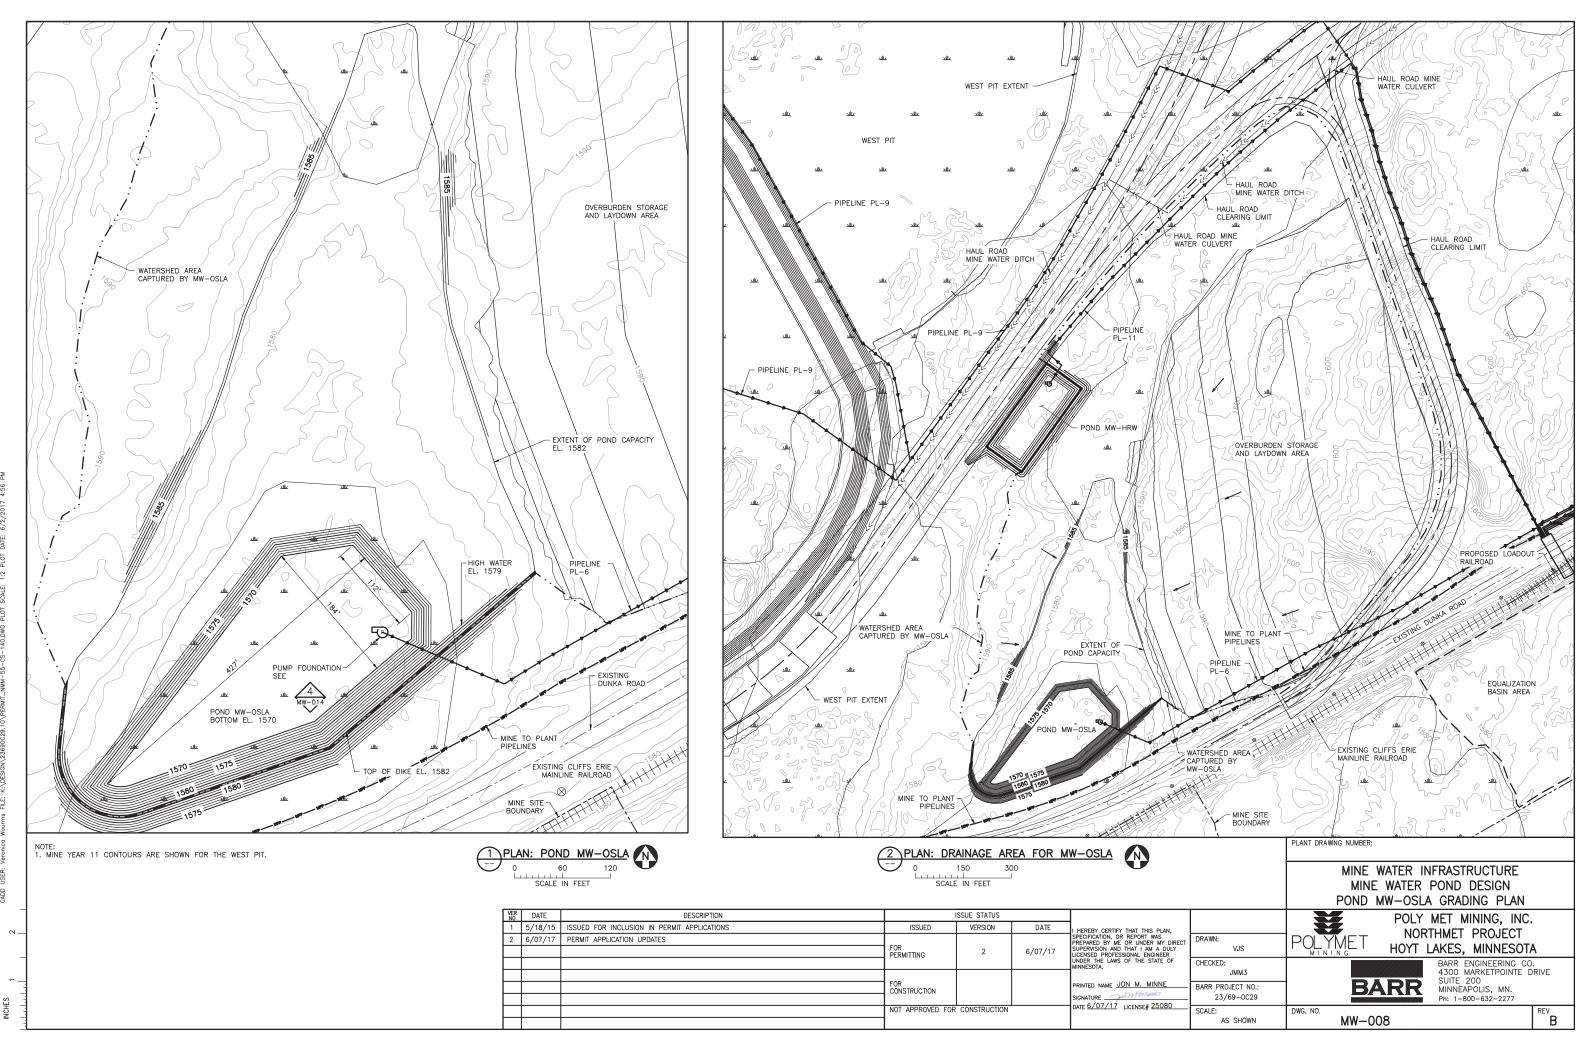
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.	JMM3	4300 MARKETPOINTE D	RIVE
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30	SCALE:	DWG. NO.	REV
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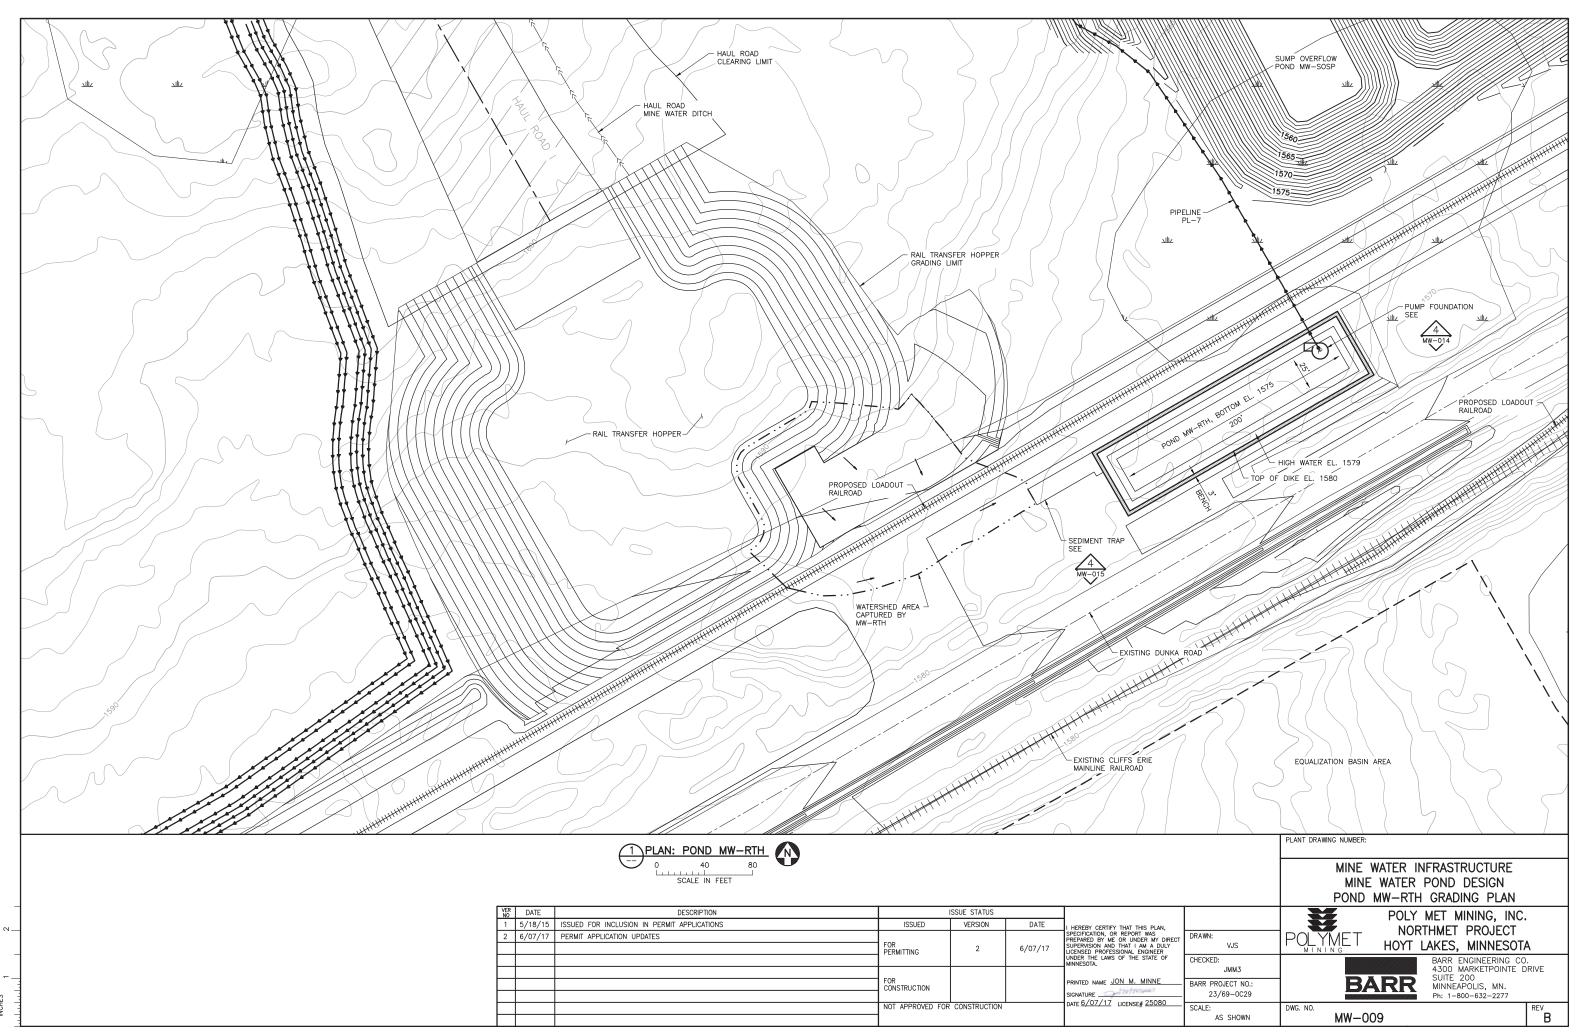


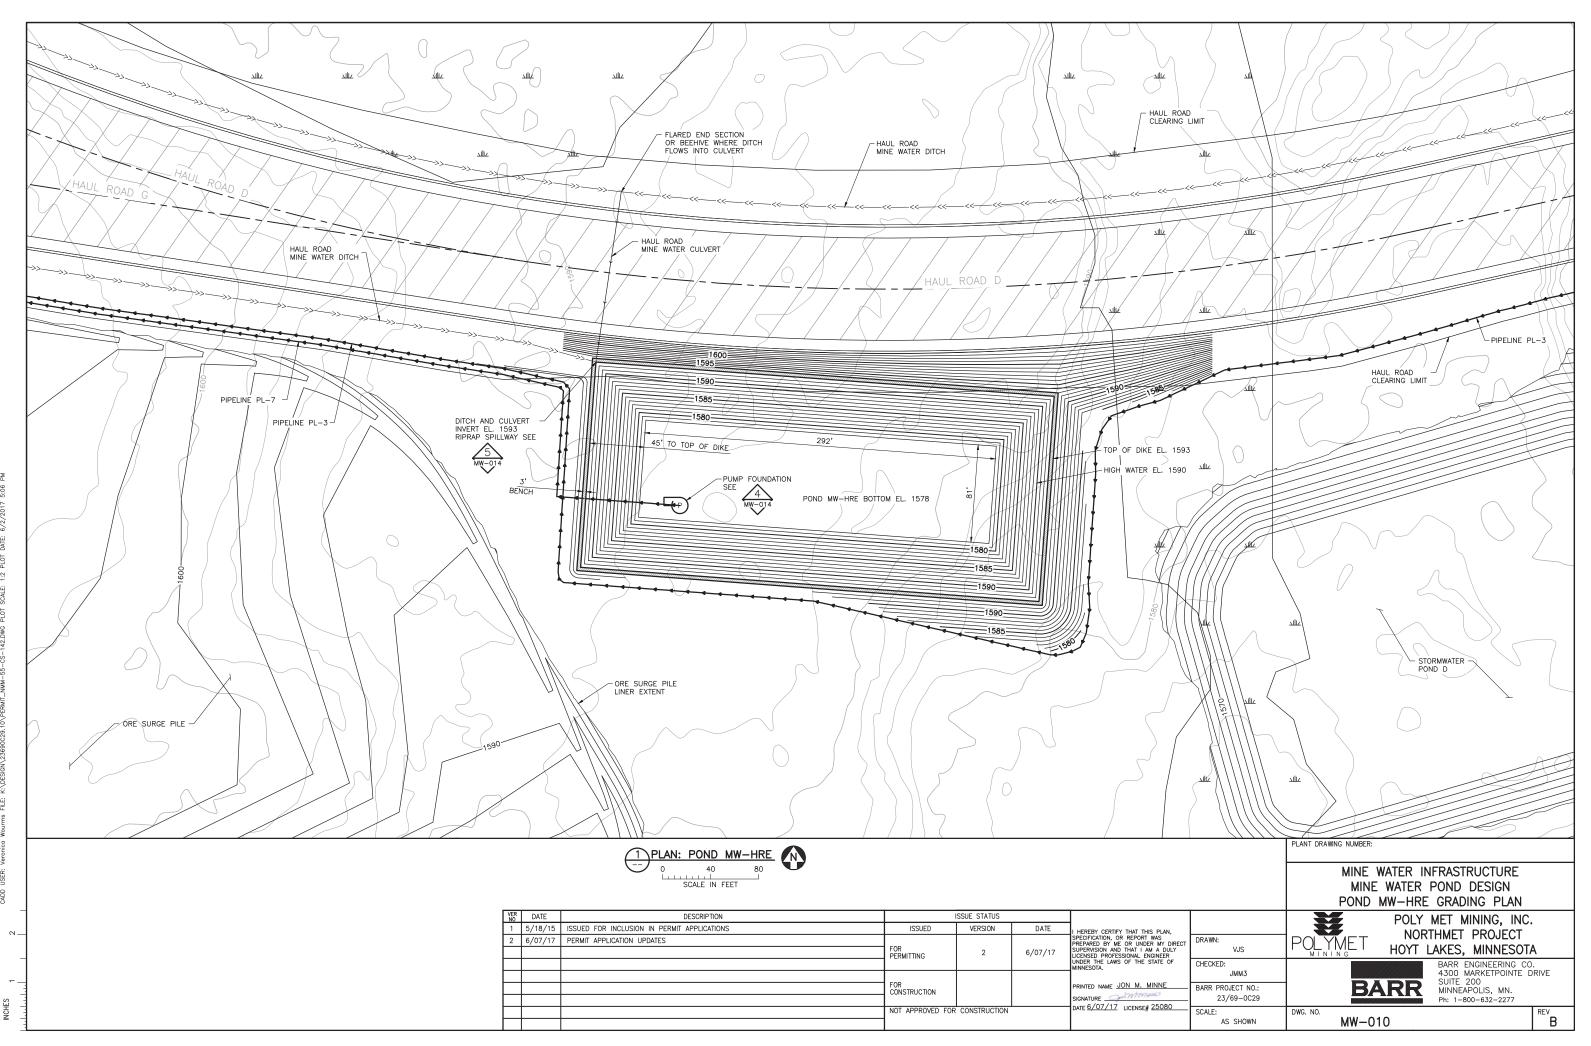


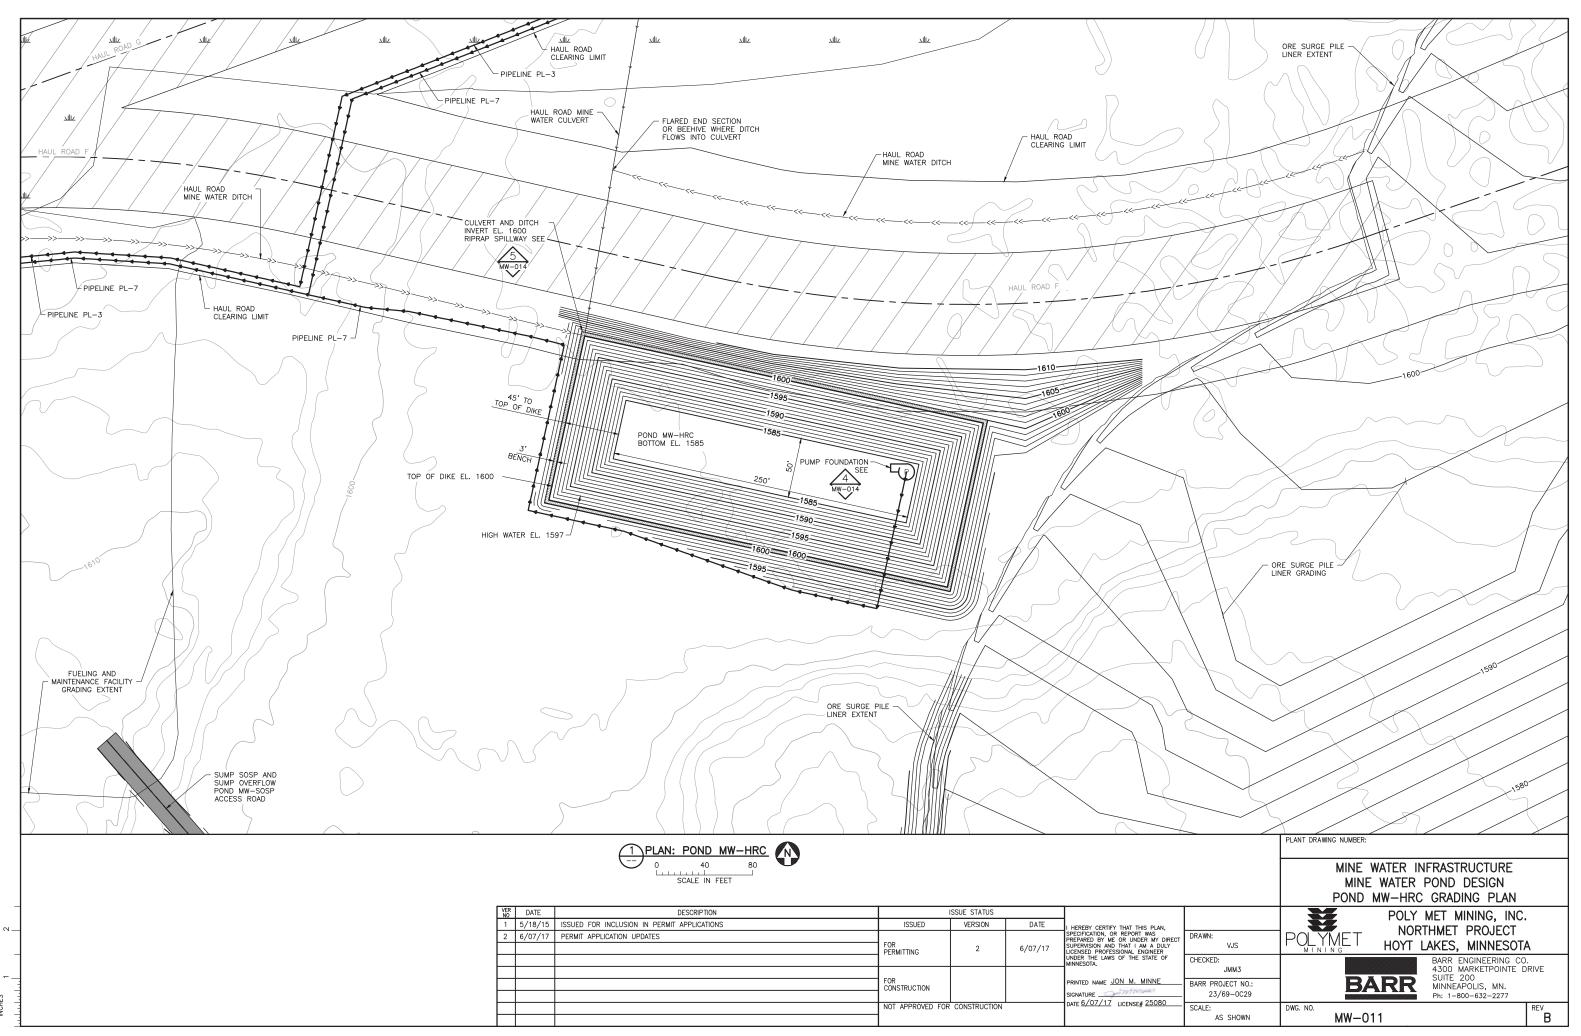
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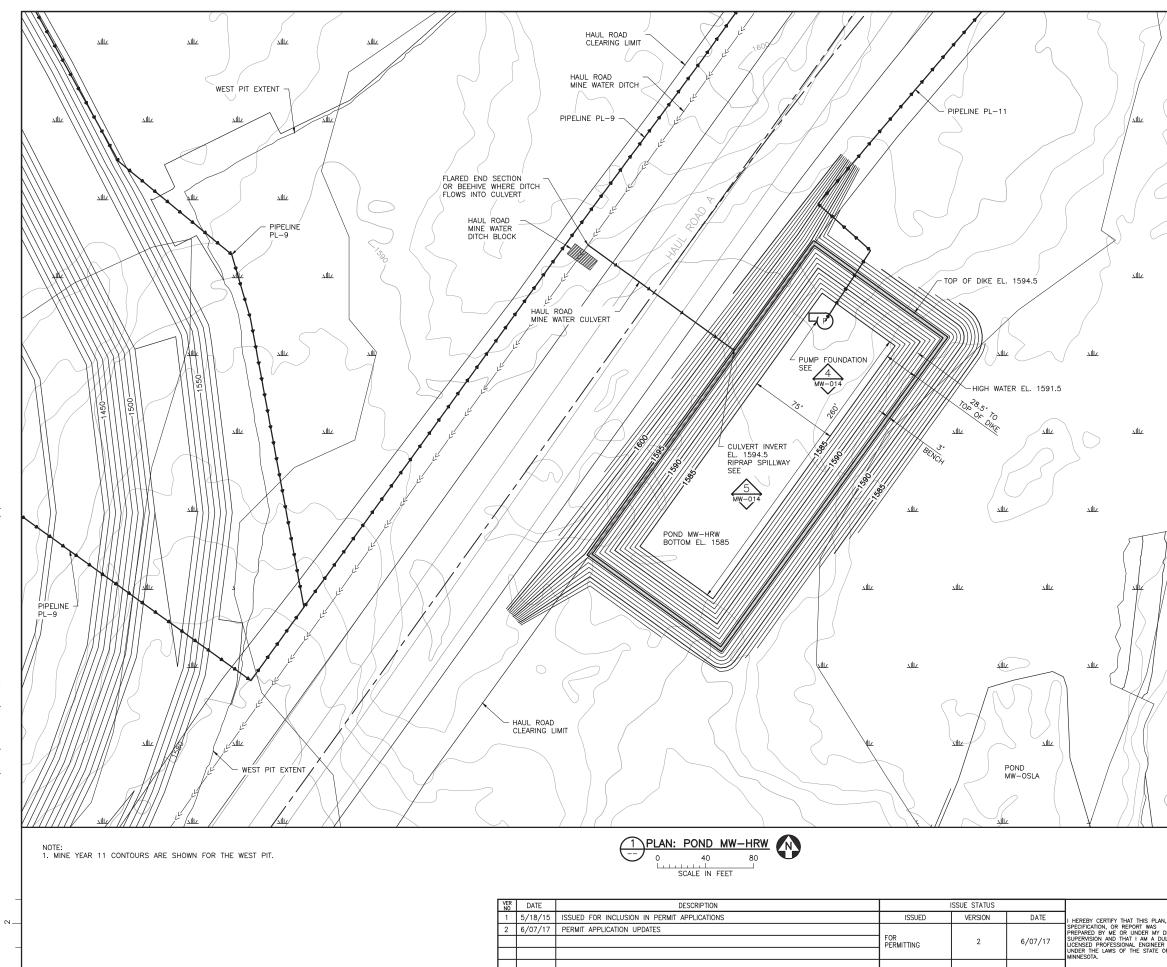
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	JMM3 BARR PROJECT NO.:	4300 MARKETPOINTE D SUITE 200 MINNEAPOLIS, MN.	RIVE
<u>30</u>	23/69-0C29 SCALE: AS SHOWN	Ph: 1-800-632-2277	REV B







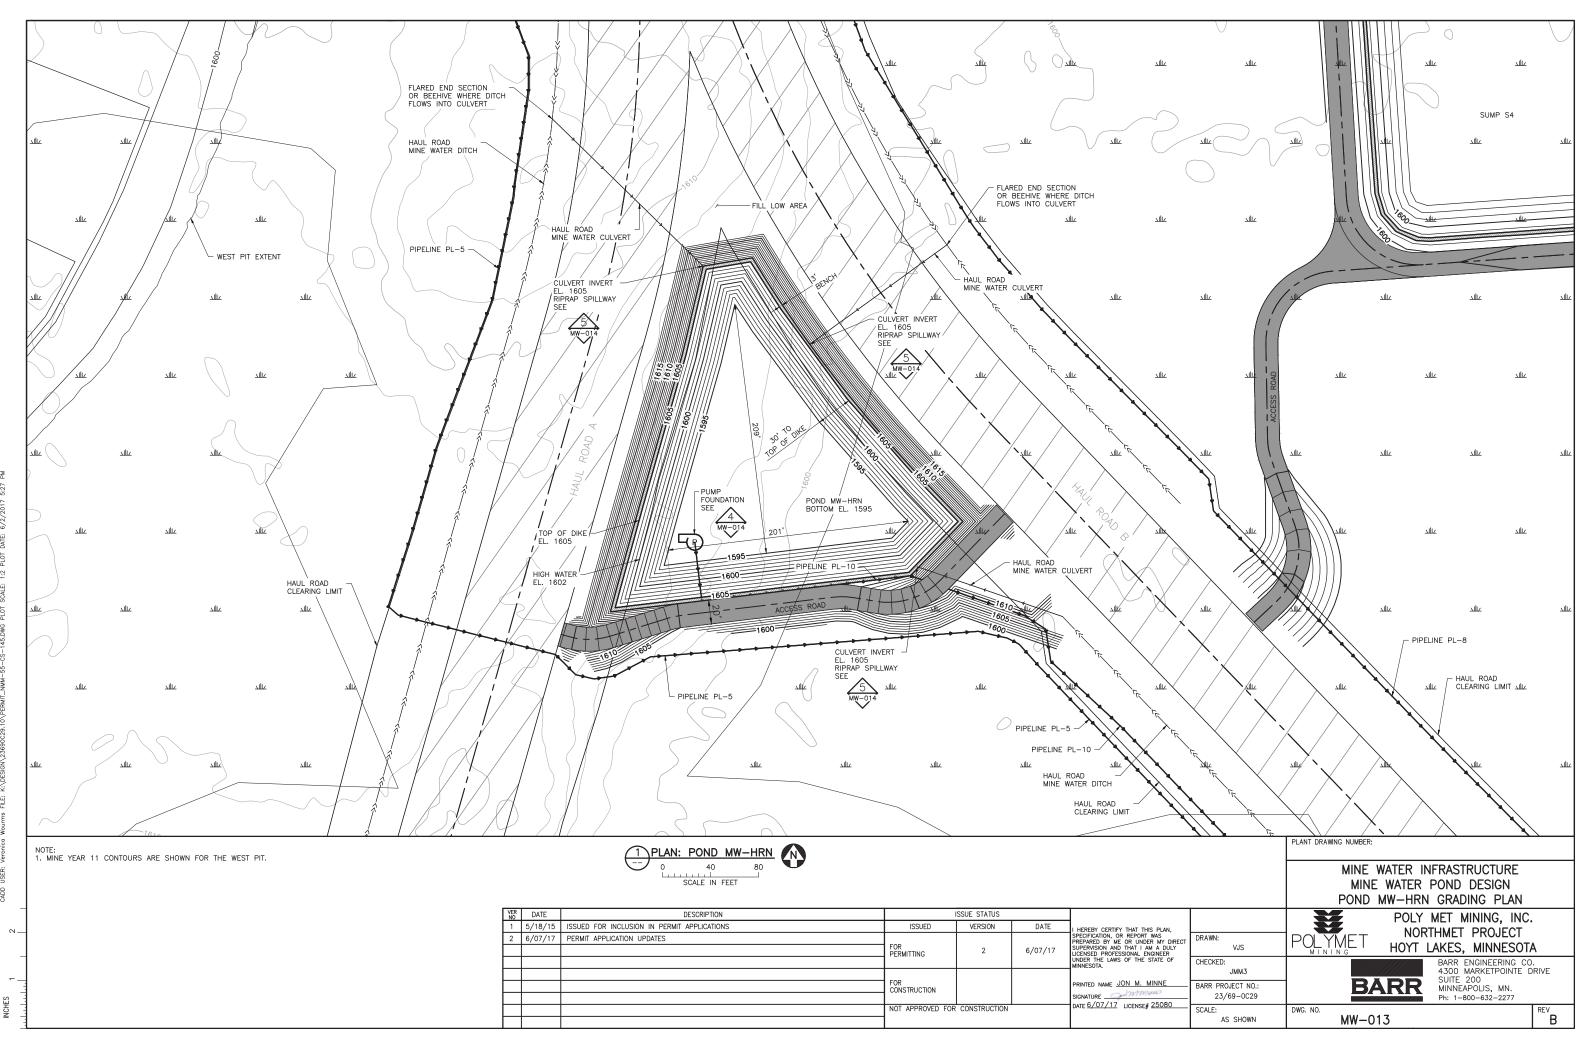




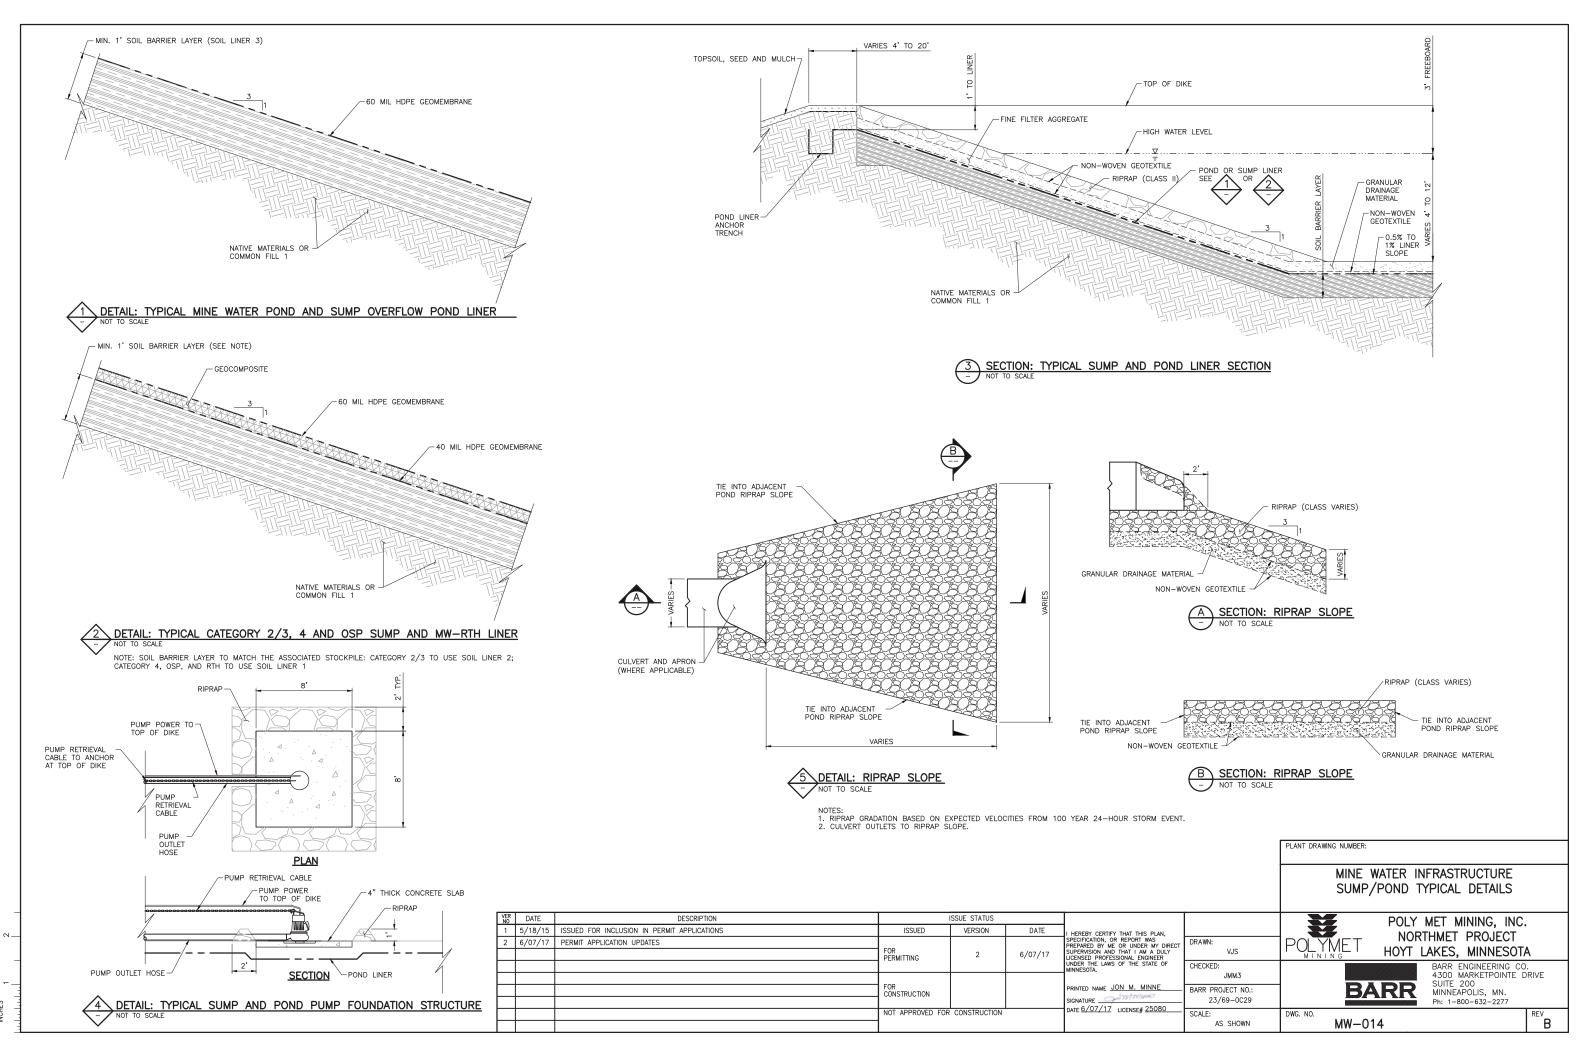
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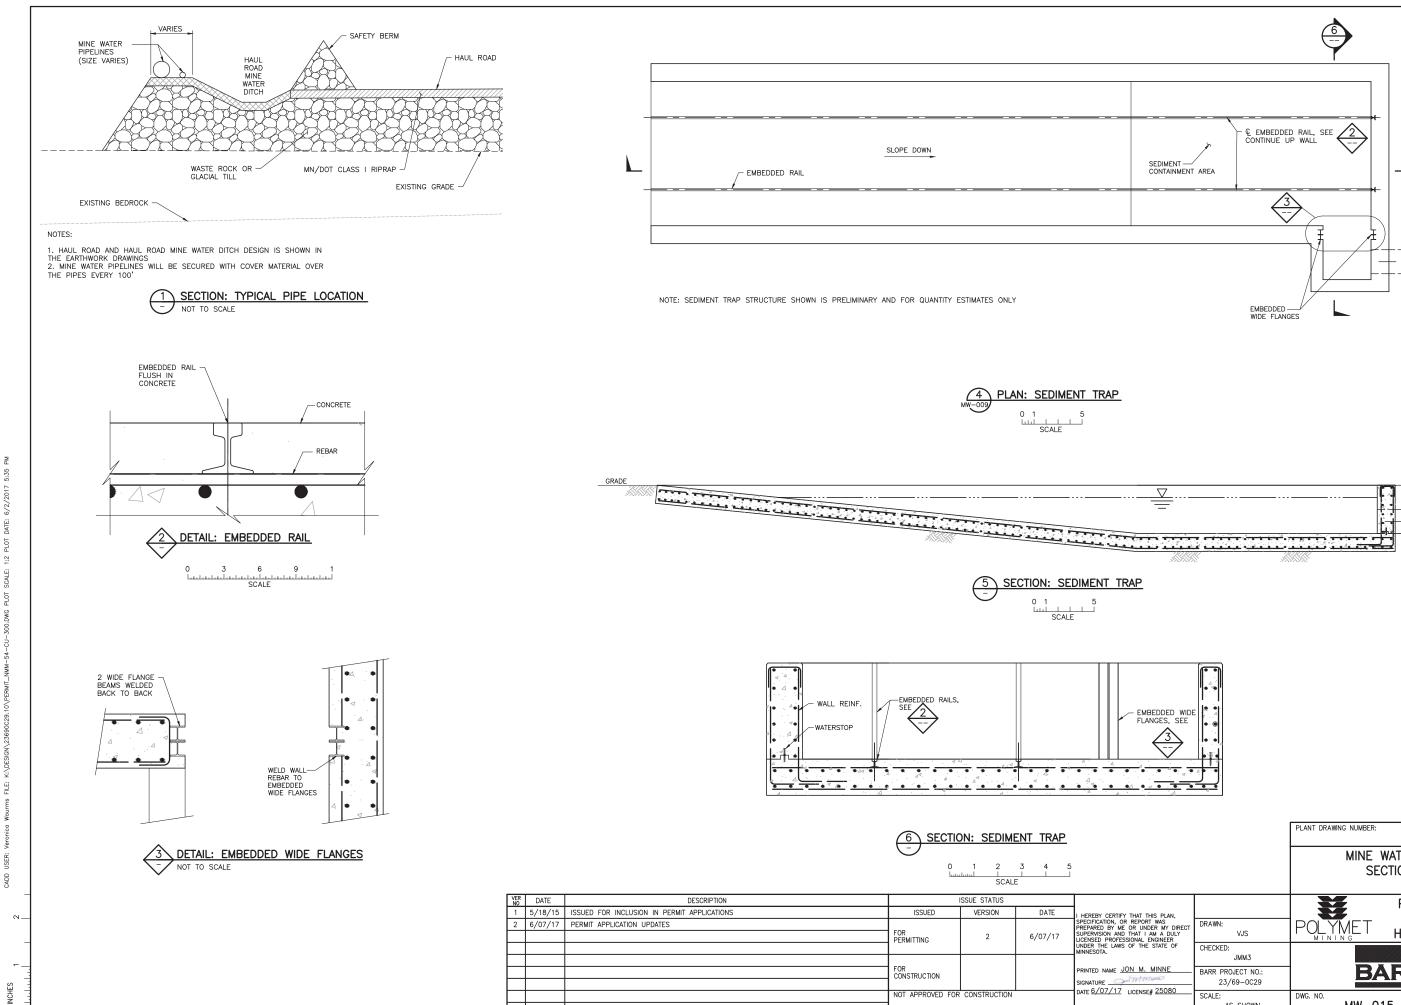
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		PLANT DRAWING NUMBER:	
		MINE WATER POND MW-HR	INFRASTRUCTURE POND DESIGN W GRADING PLAN
I HEREBY CERTIFY THAT THIS PLAN, SPECIFICATION, OR REPORT WAS PREPARED BY WE OR UNDER MY DIRECT SUPERVISION AND THAT I AM A DULY LICENSED PROFESSIONAL ENGINEER UNDER THE LAWS OF THE STATE OF MINNESOTA.	DRAWN: VJS	NOI	' MET MINING, INC. RTHMET PROJECT LAKES, MINNESOTA
	CHECKED: JMM3		BARR ENGINEERING CO. 4300 MARKETPOINTE DRIVE SUITE 200
PRINTED NAME JON M. MINNE SIGNATURE	BARR PROJECT NO.: 23/69-0C29	BARR	MINNEAPOLIS, MN. Ph: 1-800-632-2277
*	SCALE: AS SHOWN	DWG. NO. MW-012	REV B

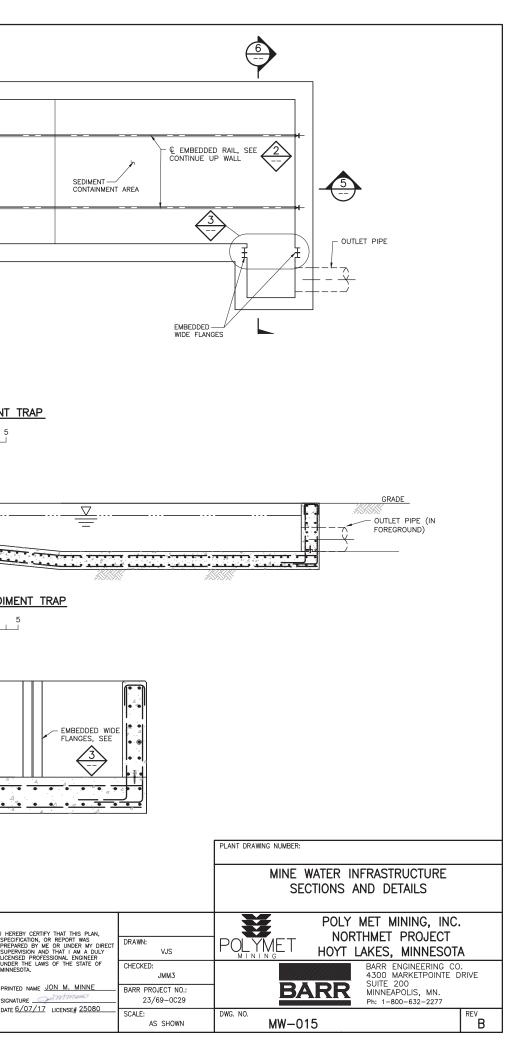


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